

#### OROVILLE PLANNING COMMISSION/ HISTORICAL ADVISORY COMMITTEE

Council Chambers 1735 Montgomery Street Oroville, CA. 95965

February 23, 2023 REGULAR MEETING 6:00 PM AGENDA

#### **PUBLIC ACCESS AND PARTICIPATION**

To view the meeting or provide comment, please see the options below.

#### To Watch or Listen to the Meeting:

- 1. Watch live feed https://www.youtube.com/channel/UCAoRW34swYl85UBfYgT7lbQ/
- 2. Zoom <a href="https://zoom.us/j/99508232402?pwd=aThZc1BsUG9sWnhNYnlwZHZZdFFrQT09">https://zoom.us/j/99508232402?pwd=aThZc1BsUG9sWnhNYnlwZHZZdFFrQT09</a> Meeting ID: 995 0823 2402 Passcode: 17351735
- 3. Listen via telephone: 1-669-900-9128 Meeting ID: 995 0823 2402 Passcode: 17351735

#### **To Provide Comments:**

- 1. Email before the meeting by 2:00 PM your comments to publiccomment@cityoforoville.org
- 2. Attend in person

If you would like to address the Commission at this meeting, you are requested to complete the blue speaker request form (located on the wall by the agendas) and hand it to the City Clerk, who is seated on the right of the Council Chamber. The form assists the Clerk with minute taking and assists the Mayor or presiding chair in conducting an orderly meeting. Providing personal information on the form is voluntary. For scheduled agenda items, please submit the form prior to the conclusion of the staff presentation for that item. The Commission has established time limitations of three (3) minutes per speaker on all items and an overall time limit of thirty minutes for nonagenda items. If more than 10 speaker cards are submitted for non-agenda items, the time limitation would be reduced to one and a half minutes per speaker. (California Government Code §54954.3(b)). Pursuant to Government Code Section 54954.2, the Commission is prohibited from taking action except for a brief response from the Council or staff to statements or questions relating to a non-agenda item.

#### **CALL TO ORDER / ROLL CALL**

Commissioners: Glenn Arace, Marissa Hallen, Natalie Sheard, Warren Jensen, Vice Chairperson Wyatt Jenkins, Chairperson Carl Durling

#### **OPEN SESSION**

Pledge of Allegiance

#### PUBLIC COMMUNICATION - HEARING OF NON-AGENDA ITEMS

This is the time to address the Commission about any item not listed on the agenda. If you wish to address the Commission on an item listed on the agenda, please follow the directions listed above.

#### **CONSENT CALENDAR**

Consent calendar items are adopted in one action by the Commission. Items that are removed will be discussed and voted on immediately after adoption of consent calendar items.

#### 2. APPROVAL OF THE MINUTES

The Planning Commission may approve the minutes of January 26, 2023.

#### **RECOMMENDATION**

Approve the minutes of January 26, 2023.

#### **PUBLIC HEARINGS**

The Public Hearing Procedure is as follows:

- Mayor or Chairperson opens the public hearing.
- Staff presents and answers questions from Council
- The hearing is opened for public comment limited to two (2) minutes per speaker. In the event of more than ten (10) speakers, time will be limited to one and a half (1.5) minutes. Under Government Code 54954.3, the time for each presentation may be limited.
- Public comment session is closed
- Commission debate and action

# 3. MINOR USE PERMIT UP23-02 FOR AN ADDITION AND NEW DRIVE-THROUGH TO BE USED AS A MEMBER'S ONLY PHARMACY.

The Oroville Planning Commission will review and consider approving Use Permit No. UP23-02 for an addition to an existing building and construction of a new drive-through with associated site improvements at 2145 5th Avenue. Related Projects (B2212-072 & PL2212-010)

#### RECOMMENDATION

Conduct a Public Hearing on the proposed project;

**Adopt the Notice of Exemption as the appropriate** level of environmental review in accordance with the California Environmental Quality Act (CEQA);

Adopt the recommended Findings for Use Permit No. UP23-02;

Approve Use Permit UP23-02 and recommended Conditions of Approval;

Adopt Resolution No. P2023-02

# 4. MINOR USE PERMIT UP23-01 FOR THE CONSTRUCTION OF A NEW 7,800 SQUARE FOOT METAL BUILDING USED FOR OFFICE SPACE AND A WAREHOUSE AT 2640 SOUTH 5TH AVENUE (APN 035-380-060)

The Oroville Planning Commission will review and consider approving Use Permit No. UP23-01 for the construction of a new 7,800 square foot metal building used for office space and warehouse storage serving and adjacent to the North Valley Food Bank at 2640 South 5th Avenue. Project# PL2301-003

#### RECOMMENDATION

Conduct a Public Hearing on the proposed project;

Adopt the Notice of Exemption as the appropriate level of environmental review in accordance with the California Environmental Quality Act (CEQA);

Adopt the recommended Findings for Use Permit No. UP23-01;

**Approve** Use Permit UP23-01 and recommended Conditions of Approval;

Adopt Resolution No. P2023-01

# 5. MINOR USE PERMIT UP23-03 FOR A DRIVE-THROUGH CAR WASH ON FEATHER RIVER BLVD NORTH OF ORO DAM BLVD APN (035-030-109)

The Oroville Planning Commission will review and consider approving Use Permit No. UP23-05 for the construction of a new 3,365 square foot car wash building with associated car wash tunnel, equipment room, and a 660 square foot pay station building with office and restrooms. The project also includes 18 standard vacuum stalls and one van accessible vacuum stall under canopies fitted with solar panels.

#### **RECOMMENDATION:**

Conduct a Public Hearing on the proposed project;

**Adopt the Notice of Exemption as the appropriate** level of environmental review in accordance with the California Environmental Quality Act (CEQA);

Adopt the recommended Findings for Use Permit No. UP23-03;

**Approve** Use Permit UP23-03 and recommended Conditions of Approval;

Adopt Resolution No. P2023-03

#### REPORTS / DISCUSSIONS / CORRESPONDENCE

- 6. Commissioner Reports
- 7. Historical Advisory Commission Reports
- 8. Staff Reports

#### **ADJOURN THE MEETING**

The meeting will be adjourned. A regular meeting of the Oroville Planning Commission will be held on March 23, 2023 at 6:00 PM.

Accommodating Those Individuals with Special Needs – In compliance with the Americans with Disabilities Act, the City of Oroville encourages those with disabilities to participate fully in the public meeting process. If you have a special need in order to allow you to attend or participate in our public meetings, please contact the City Clerk at (530) 538-2535, well in advance of the regular meeting you wish to attend, so that we may make every reasonable effort to accommodate you. Documents distributed for public session items, less than 72 hours prior to meeting, are available for public inspection at City Hall, 1735 Montgomery Street, Oroville, California.

Recordings - All meetings are recorded and broadcast live on cityoforoville.org and YouTube.

Planning Commission Decisions - Any person who is dissatisfied with the decisions of this Planning Commission may appeal to the City Council by filing with the Zoning Administrator within fifteen days from the date of the action. A written notice of appeal specifying the grounds and an appeal fee immediately payable to the City of Oroville must be submitted at the time of filing. The Oroville City Council may sustain, modify or overrule this decision.

#### Item 2.



# OROVILLE PLANNING COMMISSIQ 1/12 HISTORICAL ADVISORY COMMITTEE

Council Chambers 1735 Montgomery Street Oroville, CA. 95965

> January 26, 2023 MINUTES

This agenda was posted on XXXX. This meeting was recorded and may be viewed at cityoforoville.org or on YouTube.

#### **CALL TO ORDER / ROLL CALL**

PRESENT: Commissioners: Glenn Arace, Natalie Sheard, Warren Jensen, Chairperson Carl Durling

ABSENT: Commissioner Marissa Hallen, Vice Chairperson Wyatt Jenkins

STAFF: Assistant Community Development Director Dawn Nevers, Assistant Planner Danny

Kopshever, Principal Planner Wes Ervin, Assistant City Clerk Jackie Glover

#### **OPEN SESSION**

Pledge of Allegiance - Led by Chairperson Durling

#### PUBLIC COMMUNICATION - HEARING OF NON-AGENDA ITEMS

There was one public speaker on non-agenda items: Carolos Valdez

#### **CONSENT CALENDAR**

Motion by Commissioner Jensen and seconded by Commissioner Sheard to adopt the consent calendar. Motion passed.

1. APPROVAL OF THE MINUTES

The Planning Commission approved the minutes of June 23, 2022 and November 17, 2022.

#### **PUBLIC HEARINGS**

2. MINOR USE PERMIT UP22-13 FOR A NEW 4000 SQUARE FOOT BUILDING WITH A DRIVE-THROUGH AT A NEW COMMERCIAL BUILDING ON 2250 ORO DAM BLVD E. (APN 013-170-065)

The Oroville Planning Commission reviewed and considered approving Use Permit No. UP22-13 for the construction of a new 4000 square foot commercial building and associated site improvements at 2250 Oroville Dam Blvd on an existing concrete pad.

Motion by Commissioner Arace and seconded by Commissioner Jensen to adopt the Notice of Exemption as the appropriate level of environmental review in accordance with the California Environmental Quality Act (CEQA); and adopt the recommended Findings for Use Permit No. UP22-13; approve Use Permit UP22-13 and recommended Conditions of Approval, including a

Item 2.

new condition to work with the city engineer regarding signs and lighting related to entering a exiting the parking lot; and adopt Resolution No. P2022-21. Motion passed.

#### **REGULAR BUSINESS**

3. TENTATIVE PARCEL MAP 22-02 TO SPLIT APN 035-040-056 INTO THREE PARCELS TO FACILIATATE TWO AFFORDABLE HOUSING PROJECTS ON SOUTH LINCOLN BOULEVARD

The Commission reviewed and considered approving Tentative Parcel Map 22-02 for a lot split of mixed-use property on South Lincoln Boulevard. The map will split one lot into three lots in order to facilitate development of two affordable housing projects.

Motion by Commissioner Sheard and second by Commissioner Jensen to approve the recommended findings for Tentative Parcel Map 22-02 and recommended Conditions of Approval; and adopt Resolution No. P2203-01. Motion passed.

#### REPORTS / DISCUSSIONS / CORRESPONDENCE

- 1. Commissioner Reports None
- 2. Historical Advisory Commission Reports None
- 3. Staff Reports
  - DRC Commissioner Jensen will replace Commissioner Sheard.
  - Ervin Spoke about upcoming projects that the planning department has been working on, items coming to the Feb. 7<sup>th</sup> City Council Meeting, upcoming items for the DRC, and staff are working on a General Plan report.
  - Glover Spoke about upcoming mandatory training.
  - Kopshever Provided a Historical Advisory Award update

#### ADJOURN THE MEETING

Chairperson Durling adjourned the meeting at 7:06pm	
APPROVED:	ATTESTED:
Chairperson Carl Durling	Assistant City Clerk Jackie Glover



# City of Oroville

#### COMMUNITY DEVELOPMENT DEPARTMENT

1735 Montgomery Street Oroville, CA 95965-4897 (530) 538-2430 FAX (530) 538-2426 www.cityoforoville.org

#### PLANNING COMMISSION STAFF REPORT

Thursday, February 23, 2023

RE: Minor Use Permit UP23-02 for an addition and new drive-through to be used as a member's only pharmacy.

**SUMMARY:** The Oroville Planning Commission will review and consider approving Use Permit No. UP23-02 for an addition to an existing building and construction of a new drive-through with associated site improvements at 2145 South 5<sup>th</sup> Avenue. Related Projects (B2212-072 & PL2212-010)

#### **RECOMMENDATION: Staff recommends the following actions:**

- Conduct a Public Hearing on the proposed project;
- 2. Adopt the Notice of Exemption as the appropriate level of environmental review in accordance with the California Environmental Quality Act (CEQA);
- 3. **Adopt** the recommended Findings for Use Permit No. UP23-02;
- 4. **Approve** Use Permit UP23-02 and recommended Conditions of Approval;
- 5. Adopt Resolution No. P2023-02

APPLICANT:	Mark Hadrick on behalf of Feather River Tribal Health			
LOCATION: 2145 5 <sup>th</sup> Ave Blvd (APN 035-250-080)  GENERAL PLAN: PUB (Public Facilities a Services)  ZONING: PQ (Public Quasi-Public)  FLOOD ZONE: Zone X		ZONING: PQ (Public Quasi-Public)		
<b>ENVIRONMENTAL DETERMINATION:</b> Categorically Exempt per Section 15332 of Title 14, California Code of Regulations, In-Fill Development Projects.				
REPORT PREP	ARED BY:	REVIEWED BY:		
•	er, Assistant Planner elopment Department	Dawn Nevers, Assistant Director Community Development Department		

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#### **DISCUSSION**

Feather River Tribal Health (FRTH) is proposing to construct a new drive-through and building addition for the relocation of their pharmacy. The pharmacy is to serve FRTH members only. The proposed hours of operation are from 7am to 6pm. Plans show the removal of four parking spaces to make way for the drive-through, and an addition of 791 square feet to the existing 2730 square foot building. The addition and renovations are to Wing A of the existing building, and will include a staff bathroom and breakroom, pharmacy open spaces, a lobby, storage, and the drive-through.

The Zoning Administrator has determined under OMC 17.08.090 that the proposed use of APN 035-380-060 is appropriate, substantially similar to, and less intensive than several uses approved in the Public Quasi-Public (PQ) Zone, such as a hospital. Thus, the proposed use as a members only drive-through pharmacy for Feather River Tribal Health is allowed, but like these other uses requires a use permit to be decided by the Planning Commission. See the attached Zoning Interpretation #23-02.

#### **Design Guidelines**

#### From Design Guidelines - Chapter 4 - Industrial and Office

Sheet number A3.2, titled Floor Plan, and sheet A8.1 Exterior Elevations show finish materials that match the existing building. The existing facility was reviewed for compatibility with the Oroville Design guidelines and as the additions and renovations match and/or are "like for like", this project remains compatible with the Oroville Design Guidelines.

#### Parking & Site Access

Plans show the removal of four parking spaces to make way for the drive-through, and an addition of 791 square feet to the existing 2730 square foot building. The parcel directly south of the project site, APN 035-250-083, is also owned and operated by Feather River Tribal Health and has an existing Use Permit, (UP 16-03), which permitted FRTH to exceed the required parking there by 149%. Due to the existing parking in the area, the small reduction, and the general condition of parking spaces at the site; no mitigation measures regarding parking are recomended. Sheet A1.1, titled Overall Site Plan, shows accessible path of travel from the site entrance to the pharmacy and main building. The drive-through curbs have been designed according to City of Oroville Engineering standards and will be covered by a canopy with cement plaster finish.

#### **Signage**

Plans do not include signage. Sign permits will be reviewed upon submittal. On-site directional signs, with a maximum area of 5 square feet for each sign, do not require permits and are encouraged.

#### Landscaping

Landscaping shall be completed in accordance with the existing landscape maintenance agreement for the property.

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#### OMC 17.08.135 Art in public places/Oroville beautification.

**Public Art Contribution**. All new nonresidential development projects subject to the requirements of this section shall install public art on the project site in a public place as approved by the city council. The cost of the public art must be equal to at least one percent of the estimated construction costs. The creator of public art shall be an artist, defined as a person who has a reputation among peers as a person of artistic excellence, through a record of exhibitions, public commissions, sale of works, or educational attainment as judged by the arts commission. Public art shall be displayed in a manner that will enhance its enjoyment by the general public. The developer has the option to opt out of this requirement and instead pay the equivalent in-lieu fee which shall be a one percent fee of the estimated construction costs.

**Execution of Installation/Time of Payment**. If the developer chooses to pay the in-lieu fee, payment in full shall be required at the time all fees are due on any project processed through the city or upon completion of the project, whichever occurs first. The payment of all outstanding fees shall be required prior to the issuance of a Certificate of Occupancy.

For developers choosing to provide art as part of their project the developer shall provide the city with designs for review by the Arts Commission, plus proof of installation of the required public art on the development site - prior to the issuance of a Certificate of Occupancy.

#### **Required Findings for Use Permits (OMC 17.48.010)**

Before approving a use permit, the Planning Commission must consider each of the following issues and make appropriate findings (Staff's comments are in *italics*, draft findings are in the Resolution):

1. The granting of the permit will not be incompatible with or detrimental to the general health, safety or public welfare of the surrounding area or of the city as a whole.

The project will be located in an area surrounded by active commercial development. The project has been reviewed and conditioned to minimize or prevent any potential impacts to the general health, safety, or public welfare of the surrounding area and the city as a whole.

2. The proposed use follows sound principles of land use by having a suitable location relative to the community as a whole, as well as to transportation facilities, public services and other land uses in the vicinity.

The proposed use will provide a desired commercial product and is located in an area with significant employment and transportation access.

3. Public utilities and facilities, including streets and highways, water and sanitation, are adequate to serve the proposed use or will be made adequate prior to the establishment of the proposed use.

All infrastructure is in and available. Any utilities not already provided on site will be installed by the property owner, subject to all applicable fees and permits.

4. The location, size, design and operating characteristics of the proposed use will be harmonious and compatible with the surrounding neighborhood and will not adversely affect abutting properties.

As required by OMC Chapter 17.52, the project underwent development review and the applicant made revisions based on the committee's comments. The addition and drive-through are entirely within the existing parcel and will not impact neighboring properties. The site plan, design, lighting, landscaping, and other improvements have been reviewed and the project conditioned to minimize any adverse impacts on abutting properties. Code enforcement will monitor for compliance on an ongoing basis.

5. The subject site is physically suitable for the type and intensity of land use being proposed.

Applicant has submitted a set of drawings demonstrating that the site is physically suitable for the proposed type and intensity of use. The site will provide adequate capacity for the use.

6. The size, intensity and location of the proposed use will provide services that are necessary or desirable for the neighborhood and community as a whole.

Feather River Tribal Health serves Native Americans residing in Butte, Yuba, and Sutter counties. The inclusion of a drive-through for their in-house pharmacy has been determined to be a needed safety measure to address Covid-19 concerns.

7. The permit complies with all applicable laws and regulations, including the requirements of the general plan, of this title and of the city municipal code.

The use is permitted, subject to a use permit for the drive-thru, and is compatible with the General Plan, Zoning codes, and the Oroville Municipal Code.

#### FISCAL IMPACT

None. The project is subject to all customary fees.

#### **PUBLIC NOTICE**

A request for comments was prepared and circulated to the local agencies and

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surrounding property owners within 300 feet of the property. Additionally, the meeting date, time, and project description were published in the Oroville Mercury Register and posted at City Hall.

#### **ATTACHMENTS**

- 1. Resolution P2023-02
- 2. Notice of Exemption (CEQA)
- 3. Application Package
- 4. Zoning Interpretation 23-02

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#### **RESOLUTION NO. P2023-02**

A RESOLUTION BY THE OROVILLE CITY PLANNING COMMISSION MAKING FINDINGS AND CONDITIONALLY APPROVING UP#23-02, FOR AN ADDITION INCLUDING A DRIVE-THROUGH TO AN EXISTING MEDICAL FACILITY ON 2145 SOUTH 5<sup>TH</sup> AVENUE (APN 035-250-080)

**WHEREAS**, the City has received a Use Permit application for a 791 square foot addition including a drive-through to an existing medical building at 2145 South 5<sup>th</sup> Avenue; and

WHEREAS, the property is zoned Public Quasi Public (PQ); and

WHEREAS, a drive-through pharmacy is not listed in OMC Table 17.40.010-1 Allowed Uses in Special Purpose Districts. However, this is an existing medical facility serving members only. The Zoning Administrator has prepared Zoning Interpretation 23-02 which has deemed that the use is permitted, subject to a Use Permit. As a condition of approval, the applicant will be required to comply with all requirements of the City's Zoning Code as found in the OMC Chapter 17, including, but not limited to, development standards, permit requirements and development review; and

**WHEREAS**, at a duly noticed public hearing, the Planning Commission considered the comments and concerns of public agencies, property owners, and members of the public who are potentially affected by the approval of the use permit described herein, and also considered the City's staff report regarding the change.

#### NOW, THEREFORE, BE IT RESOLVED BY THE PLANNING COMMISSION as follows:

- This action has been determined to be exempt from the California Environmental Quality Act (CEQA) review pursuant to Title 14, California Code of Regulations, Section 15332 "In-Fill Development Projects."
- 2. The Planning Commission approves the findings required by Section 17.16.160 of the Oroville City Code, as described in the Staff Report;
- 3. The Planning Commission approves the permit conditions described in this Resolution.

#### REQUIRED FINDINGS (OMC 17.48.010) FOR DRIVE THROUGH ESTABLISHMENTS

a) The granting of the permit will not be incompatible with or detrimental to the general health, safety or public welfare of the surrounding area or of the city as a whole.

The project will be in a location surrounded by active commercial development;

- b) The proposed use follows sound principles of land use by having a suitable location relative to the community as a whole, as well as to transportation facilities, public services and other land uses in the vicinity.
  - The proposed use will provide a desired commercial product, and is located in an area with significant employment and transportation access;
- c) Public utilities and facilities, including streets and highways, water and sanitation, are adequate to serve the proposed use or will be made adequate prior to the establishment of the proposed use.
  - All infrastructure is in and available, especially if applicant meets all proposed conditions, and any future conditions imposed by the City or Caltrans,
- d) The location, size, design and operating characteristics of the proposed use will be harmonious and compatible with the surrounding neighborhood and will not adversely affect abutting properties.
  - All abutting properties are also commercial. The proposed use is compatible with the surrounding neighborhood;
- e) The subject site is physically suitable for the type and intensity of land use being proposed.
  - Applicant has submitted a set of drawings demonstrating that the site is physically suitable for the proposed type and intensity of use. The site will provide adequate capacity for the use;
- f) The size, intensity and location of the proposed use will provide services that are necessary or desirable for the neighborhood and community as a whole.
  - The commercial pad has been vacant for years, and a new commercial tenant is desirable for the neighborhood and the entire community;
- g) The permit complies with all applicable laws and regulations, including the requirements of the general plan, of this title and of the city municipal code.
  - The use is permitted, subject to a use permit for the drive-thru, and is compatible with the General Plan, Zoning codes, and the Oroville Municipal Code.

#### **CONDITIONS OF APPROVAL**

**Approved project:** The Planning Commission hereby conditionally approves Use Permit No. 23-02, permitting a drive-through at the proposed building addition on 2145 South 5<sup>th</sup> Avenue (APN 035-250-080). The subject property has a zoning designation of Public Quasi-Public (PQ) and a General Plan land use designation of Public Facilities and Services (PUB).

#### **General Conditions**

1. The applicant shall hold harmless the City, its Council members, Planning Commissioners, officers, agents, employees, and representatives from liability for any

- award, damages, costs, and/or fees incurred by the City and/or awarded to any plaintiff in an action challenging the validity of this permit or any environmental or other documentation related to approval of this permit. Applicant further agrees to provide a defense for the City in any such action.
- 2. The project shall remain in substantial conformance with the Conditions of Approval, as adopted by the Oroville Planning Commission. Any subsequent minor changes in the project (as determined by the Zoning Administrator) may only occur subject to appropriate City review and approval. Any subsequent substantive changes in the project (as determined by the Zoning Administrator) may only occur subject to discretionary review by the Oroville Planning Commission.
- 3. The applicant shall annually pay for and obtain a City of Oroville business license.
- 4. All private facilities, improvements, infrastructure, systems, equipment, common areas, etc. shall be operated and maintained by the applicant in such a manner, and with such frequency, to ensure the public health, safety and general welfare.
- 5. All costs of operation and maintenance of private facilities, improvements, infrastructure, systems, equipment, common areas, etc. shall be the responsibility of the applicant.
- 6. Pursuant to Section 17.12.010, the proposed use of the site shall conform to the performance standards of the Oroville Municipal Code to minimize any potential negative effects that the building, structure, lighting or use could have on its surroundings, and to promote compatibility with surrounding uses and areas.
- 7. Applicable construction plans, calculations, specifications, applications, forms, etc. shall be submitted to the Building Division for review prior to the start of any construction activities requiring a building permit. All applicable plan review and development impact fees shall be paid at time of submittal.
- 8. The applicant shall ascertain and comply with the requirements of all of City, County, State, Federal, and other local agencies as applicable to the proposed project.
- 9. The project shall comply with the City's noise ordinance as found in the OMC Chapter 9.20.
- 10. Each use permit shall be issued subject to the condition that the zoning administrator may inspect the premises for which the use permit is issued at any reasonable time to ensure compliance with the conditions of the use permit. Refusal to permit the zoning administrator to inspect the premises shall be rebuttably presumed to be grounds for revocation of the use permit.
- 11. Pursuant to Section 17.48.010(F) of the City Code, the Planning Commission, upon its own motion, may modify or revoke any use permit that has been granted pursuant to the provisions of this section upon finding any of the following, based on substantial evidence:
  - I. Any of the conditions of the permit have not been satisfied within 1 year after it was granted.

- II. Any of the terms or conditions of the permit have been violated.
- III. A law, including any requirement in the Municipal Code Chapter 17, has been violated in connection with the permit.
- IV. The permit was obtained by fraud.
- 12. Applicant hereby certifies that any and all statements and information provided as part of the application are true and correct to the best of their knowledge and belief. Any misinformation provided, whether intentional or unintentional, that was considered in the issuance of this permit may be grounds for revocation.
- 13. Any roof mounted or ground placed utilities (HVAC, generators, etc.) shall include an architecturally compatible method of screening. This can include screening by landscaping or a decorative fence for ground placed utilities.
- 14. Building shall be addressed per City requirements. Building numbers shall comply with City Code 17.20.050(A).
- 15. The applicant shall submit to the City details of exterior lighting for review and approval.
- 16. The applicant or property owner shall apply for the proper permits as required by OMC Chapter 17.20 prior to any new signage being erected.
- 17. No more than 25% of any window area shall be covered with signs. This includes both permanent and temporary signs used to identify the business, products sold, or services offered.
- 18. The exterior of the building, including windows and doors, shall be maintained, and with such frequency, to ensure the public health, safety and general welfare of the city.
- 19. Windows and doors shall not be boarded up or blocked unless the appropriate approvals are received to ensure the public health, safety and general welfare. This does not include the use of plywood or other material used to cover a window for a temporary period of time that constitutes a safety hazard and/or invites trespassers and malicious mischief.
- 20. Minor changes may be approved administratively by the Community Development Director or designee upon receipt of a written request by the applicant or designee. Changes deemed to be major or significant in nature shall require a formal application for amendment.
- 21. Applicant and/or property owner will take appropriate measures to provide property maintenance of the building exterior, including provisions to keep the premise free of litter and debris.
- 22. Applicant and/or property owner shall ensure adequate lighting of exterior areas, including parking lots, to discourage loitering outside of the buildings.
- 23. Applicant and/or property owner will ensure protection of adjacent properties from noise, odors and undue light and glare, as well as illegal activity.

24. Applicant and/or property owner will maintain adequate onsite security, both inside and outside the building, to satisfy any concerns raised by the chief of police or general public. Substantial camera surveillance and written security protocols approved by the chief of police will suffice.

#### **Specific Project Permit Conditions**

- 1. Ensure that signage clearly and immediately directs patrons to the desired drive-thru lane.
- 2. Signage is not included in this Use Permit. Any signage requiring permits will require a new building permit submittal.
- 3. The quantity, locations and striping of all primary and shared parking shall be shown in the building plans upon permit submittal.

#### \*\*\*End of Conditions\*\*\*

I HEREBY CERTIFY that the foregoing resolution was duly introduced and passed at a regular meeting of the Planning Commission of the City of Oroville held on the 26<sup>th</sup> of

February 2023, by the following vote:	
AYES:	
NOES:	
ABSTAIN:	
ABSENT:	
ATTEST:	APPROVE:

JACKIE GLOVER, ASSISTANT CITY CLERK CARL DURLING, CHAIRPERSON

# FEATHER RIVER TRIBAL HEALTH CENTER

# PHARMACY ADDITION AND REMODEL

PANIC HARDWARE PLATE

PLASTIC LAMINATE PLASTER

DISPENSER COMBINATION PAPER

QUARRY TILE

RADIUS ROOF DRAIN

REFERENCE

REGISTER REINFORCED REQUIRED

RESILIENT ROOM

SOLID CORE SEAT COVER

SCHEDULE

SHOWER SHEET

SOAP DISPENSER

SHEET METAL SCREA

SANITARY NAPKIN

RECEPTACLE

REVISION CLOUD AND DELTA

DOOR TAG - STANDARD

WINDOW TAG

EQUIPMENT TAG

WALL TAG

FINISH TAG

KEYNOTE TAG

TOILET ROOM

FURNITURE TAG

ROOM NAME

- ROOM NUMBER - CEILING HEIGHT

> AREA WHERE NO WORK IS TO BE PERFORMED

PROJECT BOUNDARY

ADA CLEAR SPACE

Name3

ACCESSORY TAG

SQUARE FEET

S.C.D.

SCHED.

S.N.R.

REFRIGERATOR

ROUGH OPENING

RAIN WATER LEADER

PLYW00D

PAIR PAINT

### CLIENT:

FEATHER RIVER TRIBAL HEALTH Maria Hunzeker 2145 5TH AVENUE OROVILLE, CA 95965

(530)532-6811 MARIA.HUNZEKER@FRTH.ORG

# ARCHITECT:

**ABBREVIATIONS:** 

CENTERLINE

RELOCATED

ACOUSTICAL

ARCHITECTURAL

BACK OF WALL

BACKSPLASH

CATCH BASIN

CONTRACTOR

CONTRACTOR

FURNISHED, OWNER

BUILDING SECTION

WALL SECTION

- DETAIL NUMBER

- SHEET NUMBER

GRID BUBBLE - NEW

GRID BUBBLE - EXISTING

MANEUVERING CLEARANCE

WHEEL CHAIR MANEUVERING

CLEARANCE

INTERIOR ELEVATION

FURNISHED

CONTRACT

BLOCKING

DIAMETER OR ROUND EXT.

ASPHALTIC CONCRETE
ACCESSIBLE
AREA DRAIN
ADJUSTABLE
F.H.C.

KELLY ARCHITECTURE AND PLANNING MR. KELLY MAVES

FINISH SURFACE

FUTURE GAUGE

GALVANIZED

CONTRACTOR

GALVANIZED IRON

GENERAL

HOSE BIB

HARDWOOD

HARDWARE

P. LAM.
ELEC. WATER COOLER PLAS.
EXISTING PLYWD.
EXPOSED P.O.T.

6528 LONETREE BLVD. ROCKLIN, CA 95765 916.797.1199

EMAIL: KELLY22@KELLYARCH.COM

### STRUCTURAL:

NORTH VALLEY ENGINEERING JUSTIN LUNGERICH

5441 FAIR OAKS BLVD. SUITE G2 CARMICHAEL, CA 95608 (916)680-9922 JUSTINI@RESPONSE-ENG.COM

# MECHANICAL:

DICKSON MECHANCIAL

GENERAL NOTES:

**ERIC DICKSON** 2031 LIVE OAK BLVD. YUBA CITY, CA 95991 (530)870-6739 ERIC@DICKSONMECHANICAL.COM

# ELECTRICAL:

AGRI ELECTRIC

WADE THORPE 11011 MIDWAY. CHICO, CA 95928 (530)342-4203 WADE@AGRIELECTRIC.COM

# PLUMBING DESIGNER:

STANDARDS.

CODES, STANDARDS, AND REFERENCES:

2019 CALIFORNIA BUILDING CODE (CBC)

2019 CALIFORNIA ELECTRICAL CODE (CEC)

2019 CALIFORNIA MECHANICAL CODE (CMC)

2019 CALIFORNIA PLUMBING CODE (CPC)

2019 CALIFORNIA ENERGY CODE (CEC)

PART 6. TITLE 24. CCR

2019 CALIFORNIA FIRE CODE (CFC)

PART 9, TITLE 24, CCR

PART 12, TITLE 24, CCR

OTHER OPENING PROTECTIVE'S"

REFERENCED STANDARDS:

PART 2, TITLE 24, CCR

PART 3, TITLE 24, CCR

PART 4, TITLE 24, CCR

PART 5, TITLE 24, CCR

2019 CALIFORNIA ADMINISTRATIVE CODE (CAC)

(2018 IBC AND 2019 CALIFORNIA AMENDMENTS)

(2017 NEC AND 2019 CALIFORNIA AMENDMENTS)

(2018 UMC AND 2019 CALIFORNIA AMENDMENTS)

(2018 UPC AND 2019 CALIFORNIA AMENDMENTS)

(2015 IFC AND 2019 CALIFORNIA AMENDMENTS)

2019 CALIFORNIA REFERENCE STANDARDS CODE (CRSC)

NFPA 99 - 2018 EDITION - "HEALTH CARE FACILITIES CODE"

NFPA 72 - 2016 EDITION - "NATIONAL FIRE ALARM AND SIGNALING CODE"

OFFICE OF STATE FIRE MARSHAL - BUILDING MATERIALS LISTING PROGRAM

MORE-STRINGENT REQUIREMENTS SHALL PREVAIL UNLESS NOTED OTHERWISE.

DIVISION OF STATE ARCHITECT - CALIFORNIA STATE ACCESSIBILITY STANDARDS

NFPA 80 - 2016 EDITION - "STANDARD FOR FIRE DOORS AND OTHER OPENING PROTECTIVE'S"

NFPA 105 - 2016 EDITION - "STANDARD FOR THE INSTALLATION OF SMOKE DOOR ASSEMBLIES AND

NOTE: WHERE LAWS AND CODES ARE FOUND TO BE IN CONFLICT WITH EACH OTHER, THE

FIRE DEPARTMENT ACCESS ROADS SHALL BE ESTABLISHED AND MAINTAINED AT ALL TIMES

COMBUSTIBLE DEBRIS SHALL NOT ACCUMULATE WITHIN BUILDINGS. CFC-2019, SECTION 3304.2

3. CUTTING AND WELDING OPERATIONS SHALL BE IN ACCORDANCE WITH CFC-2019, CHAPTER 35

4. SMOKING IS PROHIBITED. "NO SMOKING" SIGNS SHALL BE POSTED. CFC-2019, SECTION 3304.1.

5. THE STORAGE, USE, HANDLING OF FLAMMABLE AND/OR OTHER HAZARDOUS MATERIALS AT

BE IN ACCORDANCE WITH CFC-2019, SECTION 507 AND SECTION 3312.

ALL TEMPORARY EXITING SHALL BE APPROVED BY THE LOCAL FIRE OFFICIAL.

10. THE OWNER SHALL DESIGNATE A PERSON TO BE THE FIRE-PREVENTION PROGRAM

9. PLASTIC FILM (VISQUEEN), WHEN USED FOR DUST PROTECTION, SHALL BE

CONSTRUCTION SITES SHALL BE IN ACCORDANCE WITH CFC-2019, CHAPTER 57 AND, SECTION

FIRE PROTECTION SYSTEMS SHALL BE MAINTAINED OPERATIONAL AT ALL TIMES AND SHALL

REQUIRED MEANS OF EGRESS SHALL BE MAINTAINED DURING CONSTRUCTION, DEMOLITION,

SUPERINTENDENT WHO SHALL BE RESPONSIBLE FOR THE FIRE-PREVENTION PROGRAM AND ENSURE THAT IT IS CARRIED OUT THROUGH COMPLETION OF THE PROJECT. CFC-2019,

WHERE A REQUIRED FIRE PROTECTION SYSTEM IS OUT OF SERVICE, THE FIRE DEPARTMENT

AND THE FIRE CODE OFFICIAL SHALL BE NOTIFIED IMMEDIATELY AND, WHERE REQUIRED BY

THE FIRE CODE OFFICIAL, THE BUILDING SHALL EITHER BE EVACUATED OR AN APPROVED FIRE WATCH SHALL BE PROVIDED FOR ALL OCCUPANTS LEFT UNPROTECTED BY THE

SHUTDOWN UNTIL THE FIRE PROTECTION SYSTEM HAS BEEN RETURNED TO SERVICE.

READILY ACCESSIBLE EMERGENCY TELEPHONE FACILITIES SHALL BE PROVIDED IN AN

ONE STANDPIPE SHALL BE PROVIDED FOR USE DURING CONSTRUCTION. CFC-2019, SECTION

REMODELING, ALTERATIONS, AND/OR ADDITIONS TO ANY BUILDING. CFC-2019, SECTION 3311.2.

NFPA 13 - 2016 EDITION - "SPRINKLER SYSTEMS"

OTHER REGULATORY NOTICES AND REQUIREMENTS

FIRE SAFETY NOTES:

AND SECTION 3304.6.

FLAME-RETARDANT.

CFC-2019, SECTION 901.7.

APPLICABLE LAWS & CODES:

PART 1, TITLE 24, CALIFORNIA CODE OF REGULATIONS (CCR)

THE CONTRACTOR SHALL COMPLY WITH ALL APPLICABLE LAWS AND BUILDING CODES GOVERNING

THIS PROJECT. SUCH COMPLIANCE WILL INCLUDE, BUT NOT BE LIMITED TO, THE LATEST ADOPTED

ALLCOM PLUMBING INC.

ANTHONY UPTON 3140 N. TOWNSHIP RD. YUBA CITY, CA 95993 (530)671-3182 AUPTON@ALLCOMPUMBINGINC.COM

# FIRE SPRINKLER:

AUICK ACTION FIRE PROTECTION DEAN KASSUBE

921 WASHINGTON BLVD, ROSEVILLE, CA 95678 (916)296-4864 DEANK@GSFSCO.COM

# CIVIL:

NORTH VALLEY ENGINEERING

PROJECT SUMMARY:

RENOVATE EXISTING OFFICE AND LIBRARY IN WING A INTO ENCLOSED OFFICES WITH STAFF

BATHROOM AND BREAK ROOM, PHARMACY OPEN SPACES, LOBBY, AND STORAGE.

GEORGE MUSALLAM 1547 STARR DRIVE, SUITE J YUBA CITY, CA 95993 (530)713-0417 GMUSALLAM@NVESCA.COM

# Bear Rock P Project Location:

2145 Fifth Ave, Oroville, CA 95965

VICINITY MAP

### GENERAL

DEMO & TOPO SITE PLAN C 5 GRADING PLANS AND DETAILS

CODE PLAN

FLOOR PLAN

A10.3 CEILING DETAILS

### STRUCUTRAL

STRUCTURAL NOTES

TYP. FRAMING DETAILS TYP. COLD-FORMED STEEL DETAILS

TYP. CFS DETAILS TYP. STEEL DETAILS

FOUNDATION PLAN

MI.O MECHANICAL SCHEDULES

PI.O PLUMBING SCHEDULE AND NOTES

WATER PIPING PLAN

# ELECTRICAL

DEMOLITION PLAN POWER PLAN LIGHTING PLAN

DOOR AND WINDOW SCHEDULE INTERIOR ELEVATIONS AND SECTIONS

A10.4 DETAILS

ELEVATIONS & SECTIONS FOUNDATION DETAILS

STEEL FRAMING DETAILS ROOF FRAMING DETAILS

# <u>MECHANICAL</u>

M2.0 MECHANICAL FLOOR PLAN M3.0 MECHANICAL TITLE 24

WASTE AND VENT PIPING PLAN

P3.1 ROOF DRAIN PLAN

Permit No.:

Key Plan

KAP Job No. 463.01 Scale: As Noted Date: December 2022

Checked By: ML

Sheet Name

**COVER SHEET** 

Sheet Number

#### SPECIFICATION(S) HOLLOW METAL HORIZONTAL STAINLESS STEEL SERVICE SINK HEIGHT INSIDE DIAMETER CEILING STANDARD CAULKING INTERIOR **JANITOR** STRUCT CONCRETE JOINT SUSPENDED SYMMETRICAL KITCHEN LABORATORY CASED OPENING LAMINATE LAVATORY LONG LEG HORIZONTAL TELLONG LEG VERTICAL TERR. TELEPHONE TERRAZZO CONSTRUCTION TONGUE & GROOVE MEDICINE CABINET T.O.B. CERAMIC MECHANICAL TOP OF CONCRETE MEMBRANE TOP OF PARAPET TOP OF STEEL MANUFACTURER TOP OF WALL TOILET PAPER T.P.D. MANHOLE DESCRIPTION MINIMUM MIRROR DISPENSER DRINKING FOUNTAIN TELEVISION TYP. TYPICAL MULLION UNDERCUT UNLESS NOTED NOT IN CONTRACT OTHERWISE DOOR OPENING NOT TO SCALE VINYL COMPOSITION V.C.T. OUTSIDE AIR VERTICAL DRY STANDPIPE VEST. VESTIBULE ON CENTER OUTSIDE DIAMETER EXPANSION JOINT OWNER FURNISHED, CONTRACTOR WITHOUT ELECTRICAL OWNER FURNISHED WATERPROOF EMERGENCY OWNER INSTALLED WATER RESISTANT ENCLOSURE WAINSCOT OPPOSITE OVER WELDED WIRE FABRIC EQUIPMENT W.W.F. **SYMBOLS LEGEND:** E NORTH ARROW DETAIL BUBBLE

# THE CONTRACTOR SHALL PROVIDE FOR ALL NECESSARY PERMITS AND INSPECTION FEES

WHERE REQUIRED, OTHER THAN PLAN CHECKING AND BUILDING PERMIT FEES WHICH ARE PROVIDE TEMPORARY LIGHTING AT LOCATIONS AT LEVELS OF ADEQUACY AS REQUIRED

THE CONTRACTOR SHALL VERIFY AND COORDINATE ALL NEW AND EXISTING FIELD

SHOWN IN THE CONSTRUCTION DOCUMENTS AND ACTUAL FIELD CONDITIONS.

THE CONTRACTOR SHALL FURNISH ALL MATERIALS, LABOR, EQUIPMENT AND

REGULATIONS OF STATE AND CITY AGENCIES HAVING JURISDICTION

TRANSPORTATION SERVICES NECESSARY FOR COMPLETION OF THE WORK. ALL

MATERIAL AND WORK PROVIDED SHALL COMPLY WITH APPLICABLE CODES AND

CONDITIONS AND SHALL NOTIFY ARCHITECT OF ANY DISCREPANCIES BETWEEN WHAT IS

- TO COMPLETE THE WORK IN A SAFE AND PROPER MANNER.
- CONTRACTOR TO PROVIDE FIRST AID, FIRE PROTECTION AND OTHER TEMPORARY SERVICES AS REQUIRED IN ACCORDANCE WITH LEGAL REQUIREMENTS.
- PENETRATIONS OF PIPES, CONDUITS, ETC., IN RATED ASSEMBLIES SHALL BE THE GENERAL CONTRACTOR SHALL BE RESPONSIBLE FOR THE COORDINATION BETWEEN
- GENERAL CONTRACTOR AND HIS SUBCONTRACTORS. IT SHALL BE THE RESPONSIBILITY OF THE GENERAL CONTRACTOR TO INSURE COORDINATION BETWEEN ALL TRADES, SO THAT THE JOB IS COMPLETE AND IN CONFORMITY WITH THE PLANS AND SPECIFICATIONS THE GENERAL CONTRACTOR SHALL INSURE THAT ANY INCIDENTAL WORK NOT SHOWN OR SPECIFIED, WHICH CAN BE REASONABLY INFERRED AS REQUIRED AND NECESSARY TO PROVIDE A COMPLETE JOB, SHALL BE FURNISHED AND INSTALLED.
- FIRE DEPARTMENT ACCESS ROADS SHALL BE ESTABLISHED AND MAINTAINED DURING CONSTRUCTION. CFC-2019, SEC 503.
- ALL WORK SHALL BE PLANNED AND CARRIED OUT SO THERE WILL BE THE LEAST INCONVENIENCE TO THE TRAVELING PUBLIC. PLACING OF LIGHTS, BARRICADES, WARNING SIGNS AND OTHER SAFETY DEVICES REQUIRED FOR PUBLIC SAFETY SHALL BE THE RESPONSIBILITY OF THE GENERAL CONTRACTOR. ALL SAFETY MEASURES REQUIRED BY LAW SHALL BE TAKEN.
- ALL DRAWINGS ARE CONSIDERED TO BE PART OF THE CONTRACT DOCUMENTS. THE CONTRACTOR SHALL BE RESPONSIBLE FOR THE REVIEW AND COORDINATION OF ALL DRAWINGS PRIOR TO ANY CONSTRUCTION, INCLUDING ARCHITECTURAL, INTERIORS, STRUCTURAL, MECHANICAL, PLUMBING, AND ELECTRICAL DRAWINGS. THE CONTRACTOR SHALL VERIFY IN THE FIELD, ALL ELEVATIONS, DIMENSIONS, EXISTING CONDITIONS AND POINTS OF CONNECTIONS. ANY DISCREPANCIES SHALL BE CALLED TO THE ATTENTION OF THE ARCHITECT BEFORE PROCEEDING WITH WORK. ANY WORK PERFORMED IN CONFLICT WITH THE CONTRACT DOCUMENTS SHALL BE CORRECTED BY THE CONTRACTOR
- AT HIS OWN EXPENSE AND AT NO EXPENSE TO OWNER. CONTRACTOR SHALL COORDINATE AND SCHEDULE ALL WORK WITH THE APPROVAL OF THE OWNER. DO NOT DISRUPT ANY EXISTING BUILDING SERVICES AND UTILITIES. NO WORK TO PROCEED WITHOUT PRIOR APPROVAL OF THE OWNER.
- 12. ALL DRAWINGS, THOUGH NOTED TO SCALE, ARE FOR ILLUSTRATION ONLY. THE CONTRACTOR SHALL NOT SCALE DRAWINGS. REQUIRED MEANS OF EGRESS SHALL BE MAINTAINED DURING CONSTRUCTION.
- 14. FIRE ALARM SYSTEM: (ANY WORK PERFORMED SHALL MEET THE FOLLOWING REQUIREMENTS: )

(CFC-2019, SEC 3311.2)

- A. PLANS FOR THE FIRE ALARM SYSTEM SHALL BE SUBMITTED TO, AND APPROVED BY THE LOCAL FIRE MARSHAL PRIOR TO INSTALLATION. THE ENTIRE SYSTEM SHALL BE TESTED IN THE PRESENCE OF THE LOCAL FIRE MARSHAL.
- FIRE SPRINKLER NOTES: (ANY WORK PERFORMED SHALL MEET THE FOLLOWING REQUIREMENTS:)
- A. THE AUTOMATIC SPRINKLER SYSTEM SHALL CONFORM TO THE REQUIREMENTS OF CFC-2019, SECTION 903.
- B. INSTALLATION OF THE FIRE SPRINKLER SYSTEM SHALL NOT BE STARTED UNTIL COMPLETE PLANS AND SPECIFICATIONS (INCLUDING WATER SUPPLY INFORMATION) HAVE BEEN APPROVED BY THE LOCAL FIRE MARSHAL.
- C. AT VARIOUS STAGES AND UPON COMPLETION, THE FIRE SPRINKLER SYSTEM MUST BE TESTED IN THE PRESENCE OF THE ENFORCING AGENCY.
- 16. ALL EMERGENCY LIGHTING SHALL BE TESTED IN THE PRESENCE OF THE LOCAL FIRE
- CONSTRUCTION SAFETY ORDERS.
- TAKE SPECIAL CARE TO PROTECT ADJACENT CONSTRUCTION FROM UNNECESSARY
- DO NOT CUT ANY EXISTING MECHANICAL, PLUMBING, OR ELECTRICAL SERVICES WITHOUT THE PRIOR APPROVAL OF THE OWNER. COORDINATE ALL REQUIRED TEMPORARY SERVICE
- 4. PROMPTLY REMOVE ALL DEMOLISHED MATERIALS FROM THE PROJECT SITE, AND
- OWNER HAS FIRST RIGHT OF SALVAGE: ARRANGEMENTS TO THE CONTRARY MUST BE BY

- LEGALLY DISPOSE OF OFF-SITE.
- AND CAPPING AS REQUIRED TO ACCOMMODATE NEW WORK.

- DAMAGE.
- SHUTDOWNS IN ADVANCE.

# SEPARATE WRITTEN AGREEMENT.

# **DEMOLITION GENERAL NOTES:**

- PERFORM ADDITIONAL PLUMBING, MECHANICAL AND ELECTRICAL DEMOLITION, CUTTING

# ALL WORK TO BE COMPLETED IN ACCORDANCE WITH GOVERNING LAWS, CODES AND

#### 12. COVERINGS PLACED ON OR OVER FIRE PROTECTION DEVICES TO PROTECT THEM FROM DAMAGE DURING CONSTRUCTION PROCESSES SHALL BE IMMEDIATELY REMOVED UPON THE COMPLETION OF THE CONSTRUCTION PROCESSES IN THE ROOM OR AREA IN WHICH THE DEVICES ARE INSTALLED, CFC-2019, SECTION 3308.7.

APPROVED LOCATION AT THE CONSTRUCTION SITE. CFC-2019, SECTION 3309.1. 14. IN BUILDINGS REQUIRED TO HAVE STANDPIPES BY CFC-2016 SECTION 905.3, NOT LESS THAN

16. WHEN REQUIRED BY THE FIRE CODE OFFICIAL FOR BUILDING DEMOLITION THAT IS

- FIRE PROTECTION SYSTEMS SHALL BE MAINTAINED OPERATIONAL AT ALL TIMES. CFC-2019,
- HAZARDOUS IN NATURE, QUALIFIED PERSONNEL SHALL BE PROVIDED TO SERVE AS AN ON-SITE FIRE WATCH, CFC-2019, SECTION 3304.5. 17. IN BUILDINGS WHERE AN AUTOMATIC SPRINKLER SYSTEM IS REQUIRED BY THIS CODE, IT SHALL BE UNLAWFUL TO OCCUPY ANY PORTION OF A BUILDING OR STRUCTURE UNTIL THE

AUTOMATIC SPRINKLER SYSTEM INSTALLATION HAS BEEN TESTED AND APPROVED. CFC-2019,

- 18. FIRE EXTINGUISHERS SHALL BE PROVIDED FOR BUILDINGS UNDER CONSTRUCTION. THE NUMBER AND TYPE OF EXTINGUISHERS SHALL BE AS REQUIRED BY THE OSHPD FIRE MARSHAL OR LOCAL FIRE DEPARTMENT. CFC-2019, SECTION 3315.1 AND CBC-2019, SECTION
- 20. PEDESTRIANS SHALL BE PROTECTED DURING CONSTRUCTION, REMODELING AND DEMOLITION ACTIVITIES AS REQUIRED BY CBC-2019, CHAPTER 33, SEC 3306 TABLE 3306.1. SIGNS SHALL BE PROVIDED TO DIRECT PEDESTRIAN TRAFFIC.

19. SMOKE DETECTORS SHALL BE COVERED DURING ALTERATIONS. NFPA 72-2016, SECTION

CONSTRUCTION MATERIALS AND EQUIPMENT SHALL NOT BE PLACED OR STORED SO AS TO OBSTRUCT ACCESS TO FIRE HYDRANTS, STANDPIPES, FIRE OR POLICE ALARM BOXES, CATCH BASINS OR MANHOLES. CBC-2019, SECTION 3308.

# SHEET INDEX:

# AO.O COVER SHEET

- ABBREVIATIONS & SYBMBOLS

# ARCHITECTURAL

- OVERALL SITE PLAN
- DEMOLITION PLAN

- ROOF DETAILS A10.2 CASEWORK

- TYPICAL CONCRETE DETAILS
- ROOF FRAMING PLAN

REVISION NAME

Description

DATE

Revisions

6528 LONETREE BOULEVARD | ROCKLIN, CA 95765 P. 916.797.1199 | www.kellyarch.com

FEATHER RIVER

TRIBAL HEALTH

Feather River Tribal

Pharmacy Addition

Health Center -

and Remodel

Construction

Document

Architect of Record

Consultant

2145 Fifth Avenue

Oroville, CA 95965

Client:

Approvals

Drawn By: YW



C-4 SITE PLAN

C-5 GRADING PLAN & DETAILS

C-6 UTILITIES PLAN

C-7 EROSION CONTROL PLAN

# FEATHER RIVER TRIBAL HEALTH PHARMACY ADDITION

# 2145 FIFTH AVENUE, OROVILLE CA

APPROVED BY:

MATT THOMPSON

CITY OF OROVILLE

DATE

CITY OF OROVILLE, CITY ENGINEER.

CALL BEFORE YOU DIG

2 WORKING DAYS CALL


"USA" TOLL FREE

1-800-227-2600

UNDERGROUND SERVICE

THE CONTRACTOR SHALL NOTIFY ALL UTILITY

COMPANIES TWO (2) WORKING DAYS PRIOR

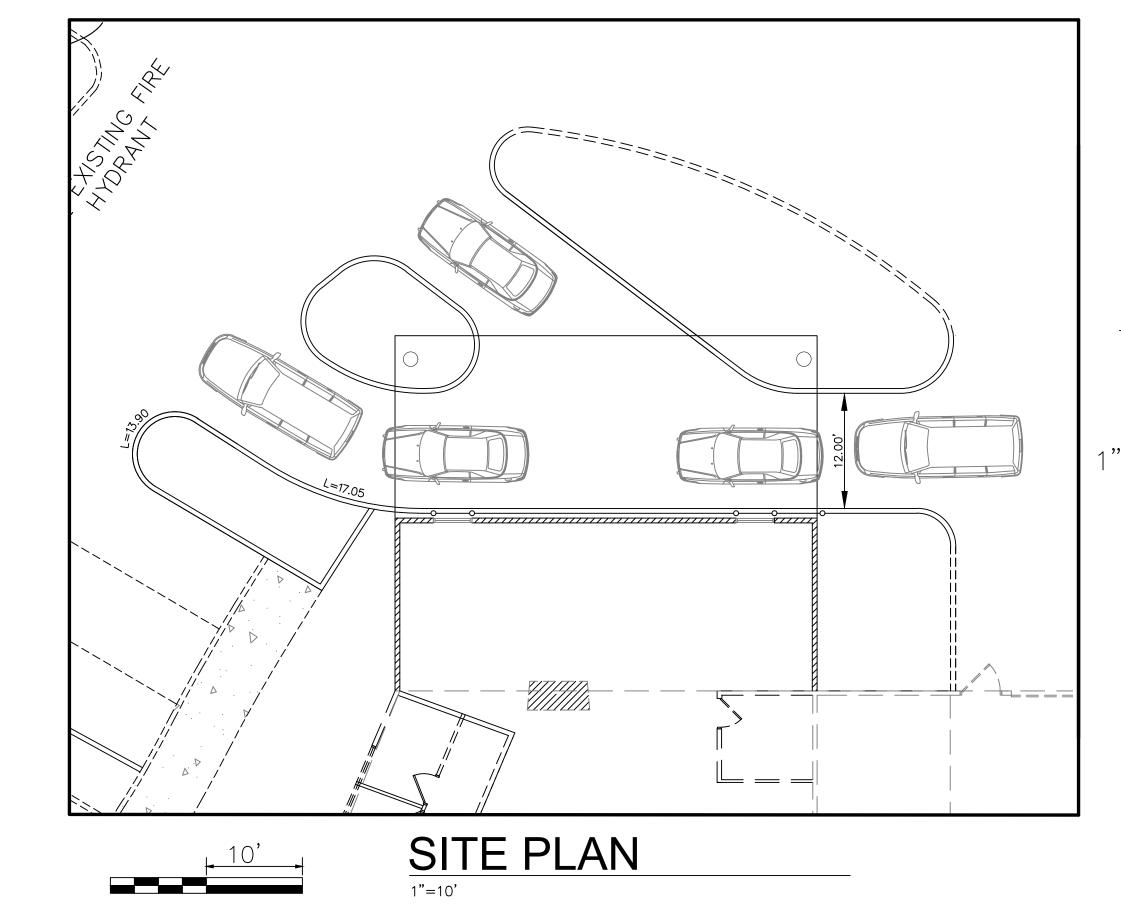

### <u>GRADING NOTES</u>

- ALL WORK TO BE PERFORMED IN ACCORDANCE WITH THE CITY OF OROVILLE STANDARD SPECIFICATIONS.
   ALL EXISTING ASPHALT AND DEBRIS SHALL BE STRIPPED PRIOR TO GRADING OPERATIONS AND TRANSPORTED
- AWAY FROM SITE.

  3. RIP PLANNED BUILDING AREA TO A DEPTH OF 8" TO 12" AND REMOVE ALL ROOTS, VEGETATION AND OTHER DELETERIOUS MATTER. MOISTURE CONDITION THE SOIL TO WITHIN 3% OF OPTIMUM MOISTURE CONTENT, AND
- RECOMPACT TO 90% RELATIVE COMPACTION PRIOR TO BEGINNING FILL PLACEMENT AND ADD FILL MATERIAL TO FINISHED PAD GRADE AS NECESSARY.

  4. FILL MATERIAL TO BE PLACED IN HORIZONTAL LIFTS OF NOT MORE THAN 6 TO 8 INCHES AND COMPACTED TO
- 90% IF IMPORTED FILL IS REQUIRED, THE MATERIAL SHALL BE APPROVED BY THE GEOTECHNICAL ENGINEER.

  5. A MINIMUM OF THREE COMPACTION TESTS TO BE TAKEN IN THE BUILDING PAD AREA AND THREE IN PARKING LOT AREA AT LOCATIONS DIRECTED BY THE DESIGN ENGINEER. RESULTS OF COMPACTION TESTS TO BE MADE
- AVAILABLE TO THE PROJECT ENGINEER.

  6. CALL (USA) TWO WORKING DAYS BEFORE YOU DIG 1-800-227-2600.
- ONSITE SOILS ARE CONSIDERED SUITABLE AS FILL. IMPORTED FILL MUST BE APPROVED BY THE GEOTECHNICAL ENGINEER.
- 8. FILL SHOULD BE MOISTURE CONDITIONED TO WITHIN 3% OF OPTIMUM WATER CONTENT. COMPACT FILLS FOR STRUCTURAL AREAS SUCH AS PAVEMENTS AND BUILDING PADS TO 90% RELATIVE COMPACTION PER ASTM D1557
- 9. COMPACT THE UPPER 12" OF PAVEMENT SUBGRADE AND AGGREGATE BASEROCK TO AT LEAST 95% RELATIVE COMPACTION PER ASTM D1557.
- 10. A) TRENCH BACKFILL SHALL HAVE A MAX PARTICLE SIZE OF 4 INCHES.
  - B) MOISTURE CONDITION TRENCH BACKFILL OUTSIDE THE TRENCH TO WITHIN 3% OF OPTIMUM WATER CONTENT.C) PLACE IN LOOSE LIFTS NOT EXCEEDING 12 INCHES FOR BACKHOES, 18" FOR LARGE EXCAVATORS.D) COMPACT FILL TO AT LEAST 90% RELATIVE COMPACTION PER ASTM D1557.
  - E) JETTING OF TRENCH BACKFILL IS NOT ACCEPTABLE EXCEPT IN JOINT TRENCHES WHERE DAMAGE TO CONDUITS MAKES MECHANICAL COMPACTION METHODS IMPRACTICAL.

- AGGREGATE BASE SHALL CONFORM TO THE PROVISIONS OF SECTION 26 OF THE STATE STANDARD SPECIFICATIONS FOR CLASS 2 AGGREGATE BASE.
- HOT MIX ASPHALT SHALL CONFORM TO THE STATE'S STANDARD SPECIFICATIONS SECTION 39-2, HOT MIX ASPHALT SHALL BE ½"

  TYPE A. PRIME COAT SHALL BE SC-70 AND SHALL BE APPLIED IF AGGREGATE BASE IS SUBJECTED TO TRAFFIC OR INCLEMENT

  WEATHER PRIOR TO PAVING.

### GENERAL NOTES

OWNER/DEVELOPER:
 FEATHER RIVER TRIBAL HEALTH
 2145 FIFTH AVENUE

OROVILLE, CA 95965 2. CIVIL ENGINEER:

NORTH VALLEY ENGINEERING AND SURVEYING
1247 STARR DRIVE SUITE J
YUBA CITY, CA 95993
(530)713-0417

3. ARCHITECT:

KELLY ARCHITECTURE & PLANNING

6528 LONETREE BOULIVARD

ROCKLIN, CA 95765

(916) 797–1199

4. BUILDER: HILBERS IN

770 N. WALTON AVENUE SUITE 100 YUBA CITY, CA 95993 (530)673-2947

TRANSPORTATION STANDARD SPECIFICATIONS, LATEST EDITION AND ANY OTHER AGENCIES' STANDARDS AS APPLICABLE.

DEPARTMENT 48 HOURS NOTICE.
7. CONTRACTOR SHALL PROVIDE FOR PUBLIC SAFETY AND TRAFFIC CONTROL IN ACCORDANCE WITH THE STATE OF CALIFORNIA MANUAL ON UNIFORM TRAFFI

CONTROL DEVICES. CONTRACTOR SHALL PROVIDE FOR SAFE VEHICULAR AND PEDESTRIAN ACCESS AT ALL TIMES DURING CONSTRUCTION.

8. CONTRACTOR SHALL CONTACT ALL UTILITY COMPANIES FOR VERIFICATION OF THE LOCATIONS OF ALL UNDERGROUND FACILITIES. CALL UNDERGROUND

SERVICE ALERT (USA) AT 1,800, 227, 2000, TWO (2) WORKING DAYS REFORE ANY EXCAVATION IS STARTED. THE CONTRACTOR SHALL CONTACT THE

SERVICE ALERT (USA) AT 1-800-227-2600 TWO (2) WORKING DAYS BEFORE ANY EXCAVATION IS STARTED. THE CONTRACTOR SHALL CONTACT THE BUILDING DEPARTMENT 8 WORKING DAYS PRIOR TO ANY WORK NEAR CITY OPERATED TRAFFIC SIGNALS FOR MARKING OUT FACILITIES. IF THE CONTRACTOR FAILS TO NOTIFY THE CITY AND DAMAGES TO TRAFFIC SIGNALS OCCUR, THE CONTRACTOR WILL BE RESPONSIBLE TO PAY ALL COSTS TO REPAIR THE DAMAGED FACILITIES.

9. THE CONTRACTOR IS RESPONSIBLE FOR THE PROTECTION OF ALL EXISTING MONUMENTS AND OTHER SURVEY MARKERS. MONUMENTS AND SURVEY MARKERS DESTROYED DURING CONSTRUCTION SHALL BE REPLACED BY A LICENSED LAND SURVEYOR AT THE CONTRACTOR'S EXPENSE. CONTRACTOR SHALL PROVIDE CITY SURVEYOR WITH TWO (2) WORKING DAYS NOTICE PRIOR TO MONUMENT REPLACEMENT.

10. THE PRIME CONTRACTOR SHALL DESIGNATE A PERSON(S) WHO SHALL HAVE THE AUTHORITY TO REPRESENT AND ACT FOR THE CONTRACTOR ON THE JOB SITE DURING ALL WORKING AND NON-WORKING HOURS AND PROVIDE BUILDING WITH CONTACT AND EMERGENCY CONTACT PHONE INFORMATION.

11. CONTRACTOR SHALL HAVE APPROVED PLANS AVAILABLE ON SITE DURING CONSTRUCTION AND CONTRACTOR SHALL CONSTRUCT ALL IMPROVEMENT TO THE LINE AND GRADE SHOWN ON THE PLANS. ANY DEVIATION FROM THE PLANS SHALL REQUIRE WRITTEN APPROVAL FROM THE BUILDING DEPARTMENT.

12. THE CONTRACTOR SHALL MAINTAIN ADEQUATE DUST CONTROL PER SECTION 10, STATE OF CALIFORNIA STANDARD SPECIFICATIONS.

13. WHERE WORK IS TO BE DONE IN AN OFF-SITE EASEMENT, THE CONTRACTOR SHALL NOTIFY THE PROPERTY OWNER IN WRITING AT LEAST TWO (2) WORKING DAYS PRIOR TO COMMENCING WORK.

14. CONTRACTOR IS RESPONSIBLE FOR THE PROTECTION OF TRAFFIC STRIPES TO REMAIN WITHIN THE LIMITS OF THE PROJECT, INCLUDING THE OPPOSITE SIDE OF THE ROADWAY FROM THE MAJORITY OF ROAD IMPROVEMENTS. TRAFFIC STRIPES DAMAGED OR COVERED DURING ROAD CONSTRUCTION SHALL BE REPLACED WITH THERMOPLASTIC MATERIAL UNLESS APPROVED BY THE CITY.

15. PRIOR TO PLACING CURB, GUTTER, SIDEWALK, ASPHALT CONCRETE, OR BASE MATERIAL, ALL UNDERGROUND FACILITIES WITHIN SHALL BE INSTALLED, BACKFILL COMPLETED, AND THE CONTRACTOR SHALL SUBMIT DOCUMENTATION TO THE CITY OF OROVILLE CITY BUILDING DEPARTMENT THAT EACH OF THE UTILITY COMPANIES HAVING FACILITIES WITHIN THE WORK AREA HAVE SATISFACTORILY PASSED ACCEPTANCE TESTS.

16. ALL STRUCTURAL CONCRETE SHALL HAVE A MINIMUM 28 DAY COMPRESSIVE STRENGTH OF 3600 PSI.

17. CONTRACTOR SHALL PROVIDE A COPY OF THE APPROVED AND SIGNED UTILITY PLAN AND COMPOSITE PLAN PRIOR TO COMMENCING ANY DRY UTILITY INSTALLATION.


### EARTHWORK

- 1. ALL EXCAVATION, EMBANKMENT, AND BACKFILL SHALL CONFORM TO THE PROVISIONS IN SECTION 19, "EARTHWORK" OF THE STATE STANDARD SPECIFICATIONS.
- CLEARING AND GRUBBING SHALL CONFORM TO THE PROVISIONS IN SECTION 16 OF THE STATE STANDARD SPECIFICATIONS.
- CONSTRUCTION ACTIVITIES OCCURRING BETWEEN OCTOBER 1 AND APRIL 30 SHALL TREAT THE SUBGRADE FOR STABILIZATION AS PROPOSED BY A GEOTECHNICAL ENGINEER AND AS APPROVED BY BUILDING.
- 4. FROM OCTOBER 1 TO APRIL 30 NO MORE THAN 300' OF OPEN TRENCHES ARE ALLOWED THROUGHOUT THE PROJECT SITE AT ONE TIME AND ALL TRENCHES SHALL BE BACKFILLED PRIOR TO RAIN EVENTS.
- 5. CONTRACTOR IS NOTIFIED THAT JETTING IS NOT ALLOWED IN ANY TRENCHES.
- 6. ALL COMPACTION TESTS SHALL BE CERTIFIED BY A REGISTERED GEOTECHNICAL ENGINEER PRIOR TO SUBMITTING TEST RESULTS TO THE BUILDING DEPARTMENT.
- . IF COMPACTION REQUIREMENTS CAN NOT BE MET THEN A RECOMMENDATION FROM A GEOTECHNICAL ENGINEER SHALL BE SUBMITTED FOR APPROVAL BY THE BUILDING DEPARTMENT.

SURVEYING SUITE "J" 95993

RTH VALLEY
ERING & SURVE
RR DRIVE, SUIT
CITY, CA 95993

ITLE SHEET

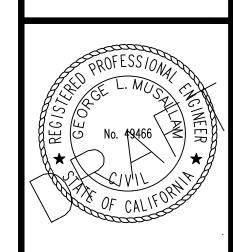

JOB TITLE:

RMACY DRIVE THROUGH
THER RIVER TRIBAL HEALTH CENTER
2145 FIFTH AVENUE

REVISIONS:

4

<u></u>

DATE DESCRIPTION


DATE DEC 2022

DRAWN RCM

JOB NO. 22-1620

C

# SYMBOLS

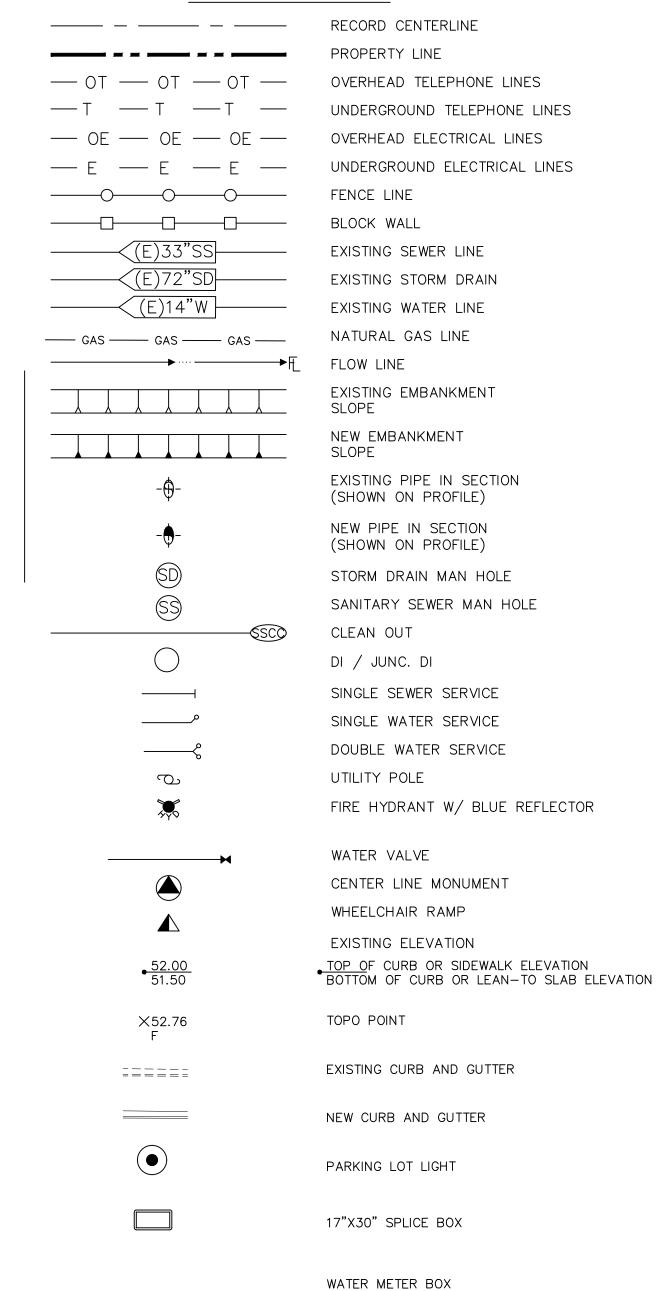

# **ABBREVIATIONS**

%	PERCENT	INV	INVERT
AB	AGGREGATE BASE	IRR	IRRIGATION
ABDN	ABANDONED	JDI	JUNCTION DRAIN INLET
AC	ASPHALTIC CONCRETE	L	LENGTH
ACP	ASBESTOS CEMENT PIPE	LAT	LATERAL/ LATITUDE
ALT	ALTERNATE	LF	LINEAL FEET
ARV	AIR RELIEF VALVE	LT	LEFT
ВС	BEGIN HORIZONTAL CURVE	MAX	MAXIMUM
BCR	BEGIN CURB RETURN	MB	MAIL BOX
BF	BLIND FLANGE	MFR	MANUFACTURER
BFV	BUTTERFLY VALVE	MH	MANHOLE
BLDG	BUILDING	MIN	MINIMUM
ВМ	BENCHMARK	MISC	MISCELLANEOUS
BVC	BEGIN VERTICAL CURVE	MJ	MECHANICAL JOINT
СВ	CATCH BASIN	MJ-LEB	MECH JOINT - LARGE END BELL
CF	CUBIC FEET	MTR	METER
CI	CAST IRON	N	NORTH
CIPCP	CAST-IN-PLACE CONCRETE PIPE	NIC	NOT IN CONTACT
CL	CENTERLINE	NO	NUMBER
CMP	CORRUGATED METAL PIPE	NTS	NOT TO SCALE
СО	CLEAN OUT	ос	ON CENTER
CONC	CONCRETE	OD	OUTSIDE DIAMETER
CORN	CORNER	ОН	OVERHEAD
CR	CROWN	OSHA	OCCUPATIONAL SAFETY & HEALTH ADMI
СТВ	CEMENT TREATED BASE	P/(P)	PROPOSED
CTV	CABLE TELEVISION	PI	POINT OF INFLECTION
DET	DETAIL	PL	PROPERTY LINE
DEWM	DEAD-END WATER MAIN	PM	PAVEMENT MARKERS
DI	DRAIN INLET	PP	POWER POLE
DIA	DIAMETER	PUE	PUBLIC UTILITY EASEMENT
DIP	DUCTILE IRON PIPE	PVC	POLYVINYL CHLORIDE
DWG	DRAWING	PVI	POINT OF VERTICAL INFLECTION
DW	DRIVEWAY	QTY	QUANTITY
E	EAST	R	RADIUS
EΑ	EACH	RCP	REINFORCED CONCRETE PIPE
EC	END HORIZONTAL CURVE	RT	RIGHT
ECR	END CURB RETURN	ROW	RIGHT OF WAY
EG	EXISTING GRADE	s	SOUTH OR SLOPE
ELEV	ELEVATION	SD	STORM DRAIN
ELEC	ELECTRICAL	SDDI	STORM DRAIN - DRAIN INLET
EOTW	EDGE OF TRAVELED WAY	SDJDI	STORM DRAIN - JUNCTION DRAIN INLET
EP	EDGE OF PAVEMENT	SDMH	STORM DRAIN - MANHOLE
EVC	END VERTICAL CURVE	SDR	STANDARD DIMENSION RATIO
EX/(E)	EXISTING	SF	SQUARE FEET
FC	FACE OF CURB	SHT	SHEET
FE	FLANGED END	SPECS	SPECIFICATIONS
FG	FINISHED GRADE	SQ	SQUARE
FH	FIRE HYDRANT	SS	SANITARY SEWER
FL	FLOW LINE	SSMH	SANITARY SEWER - MANHOLE
FM	FORCE MAIN	SVC	SERVICE
FT	FOOT OR FEET	STA	STATION
FTG	FOOTING	STD	STANDARD
GALV	GALVANIZED	SW	SIDEWALK
GALV	GALVANIZED IRON PIPE	TBC	TOP BACK OF CURB
GAS	GAS MAIN		
GAS GS	GAS SERVICE	TBM	TEMPORARY BENCHMARK
GS GV	GAS SERVICE  GATE VALVE	TBW	TOP BACK OF SIDEWALK
		TC	TOP OF CURB
HDPE HORIZ	HIGH DENSITY POLYETHYLENE HORIZONTAL	TELE	TELEPHONE
	LICITIZ CINTAL	l TR	TRENCH

TYP

TYPICAL

ID

INSIDE DIAMETER

UNDERGROUND UTILITY VITRIFIED CLAY PIPE VERTICAL WATER OR WEST WELDED WIRE FABRIC CROSSING XSECT CROSS SECTION

VIATIONS

ABBRE



JOB TITLE:


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PHARMACY

**REVISIONS:** 

# DATE DESCRIPTION DATE MAY 2022

DRAWN RCM JOB NO. 22-1629 SHEET

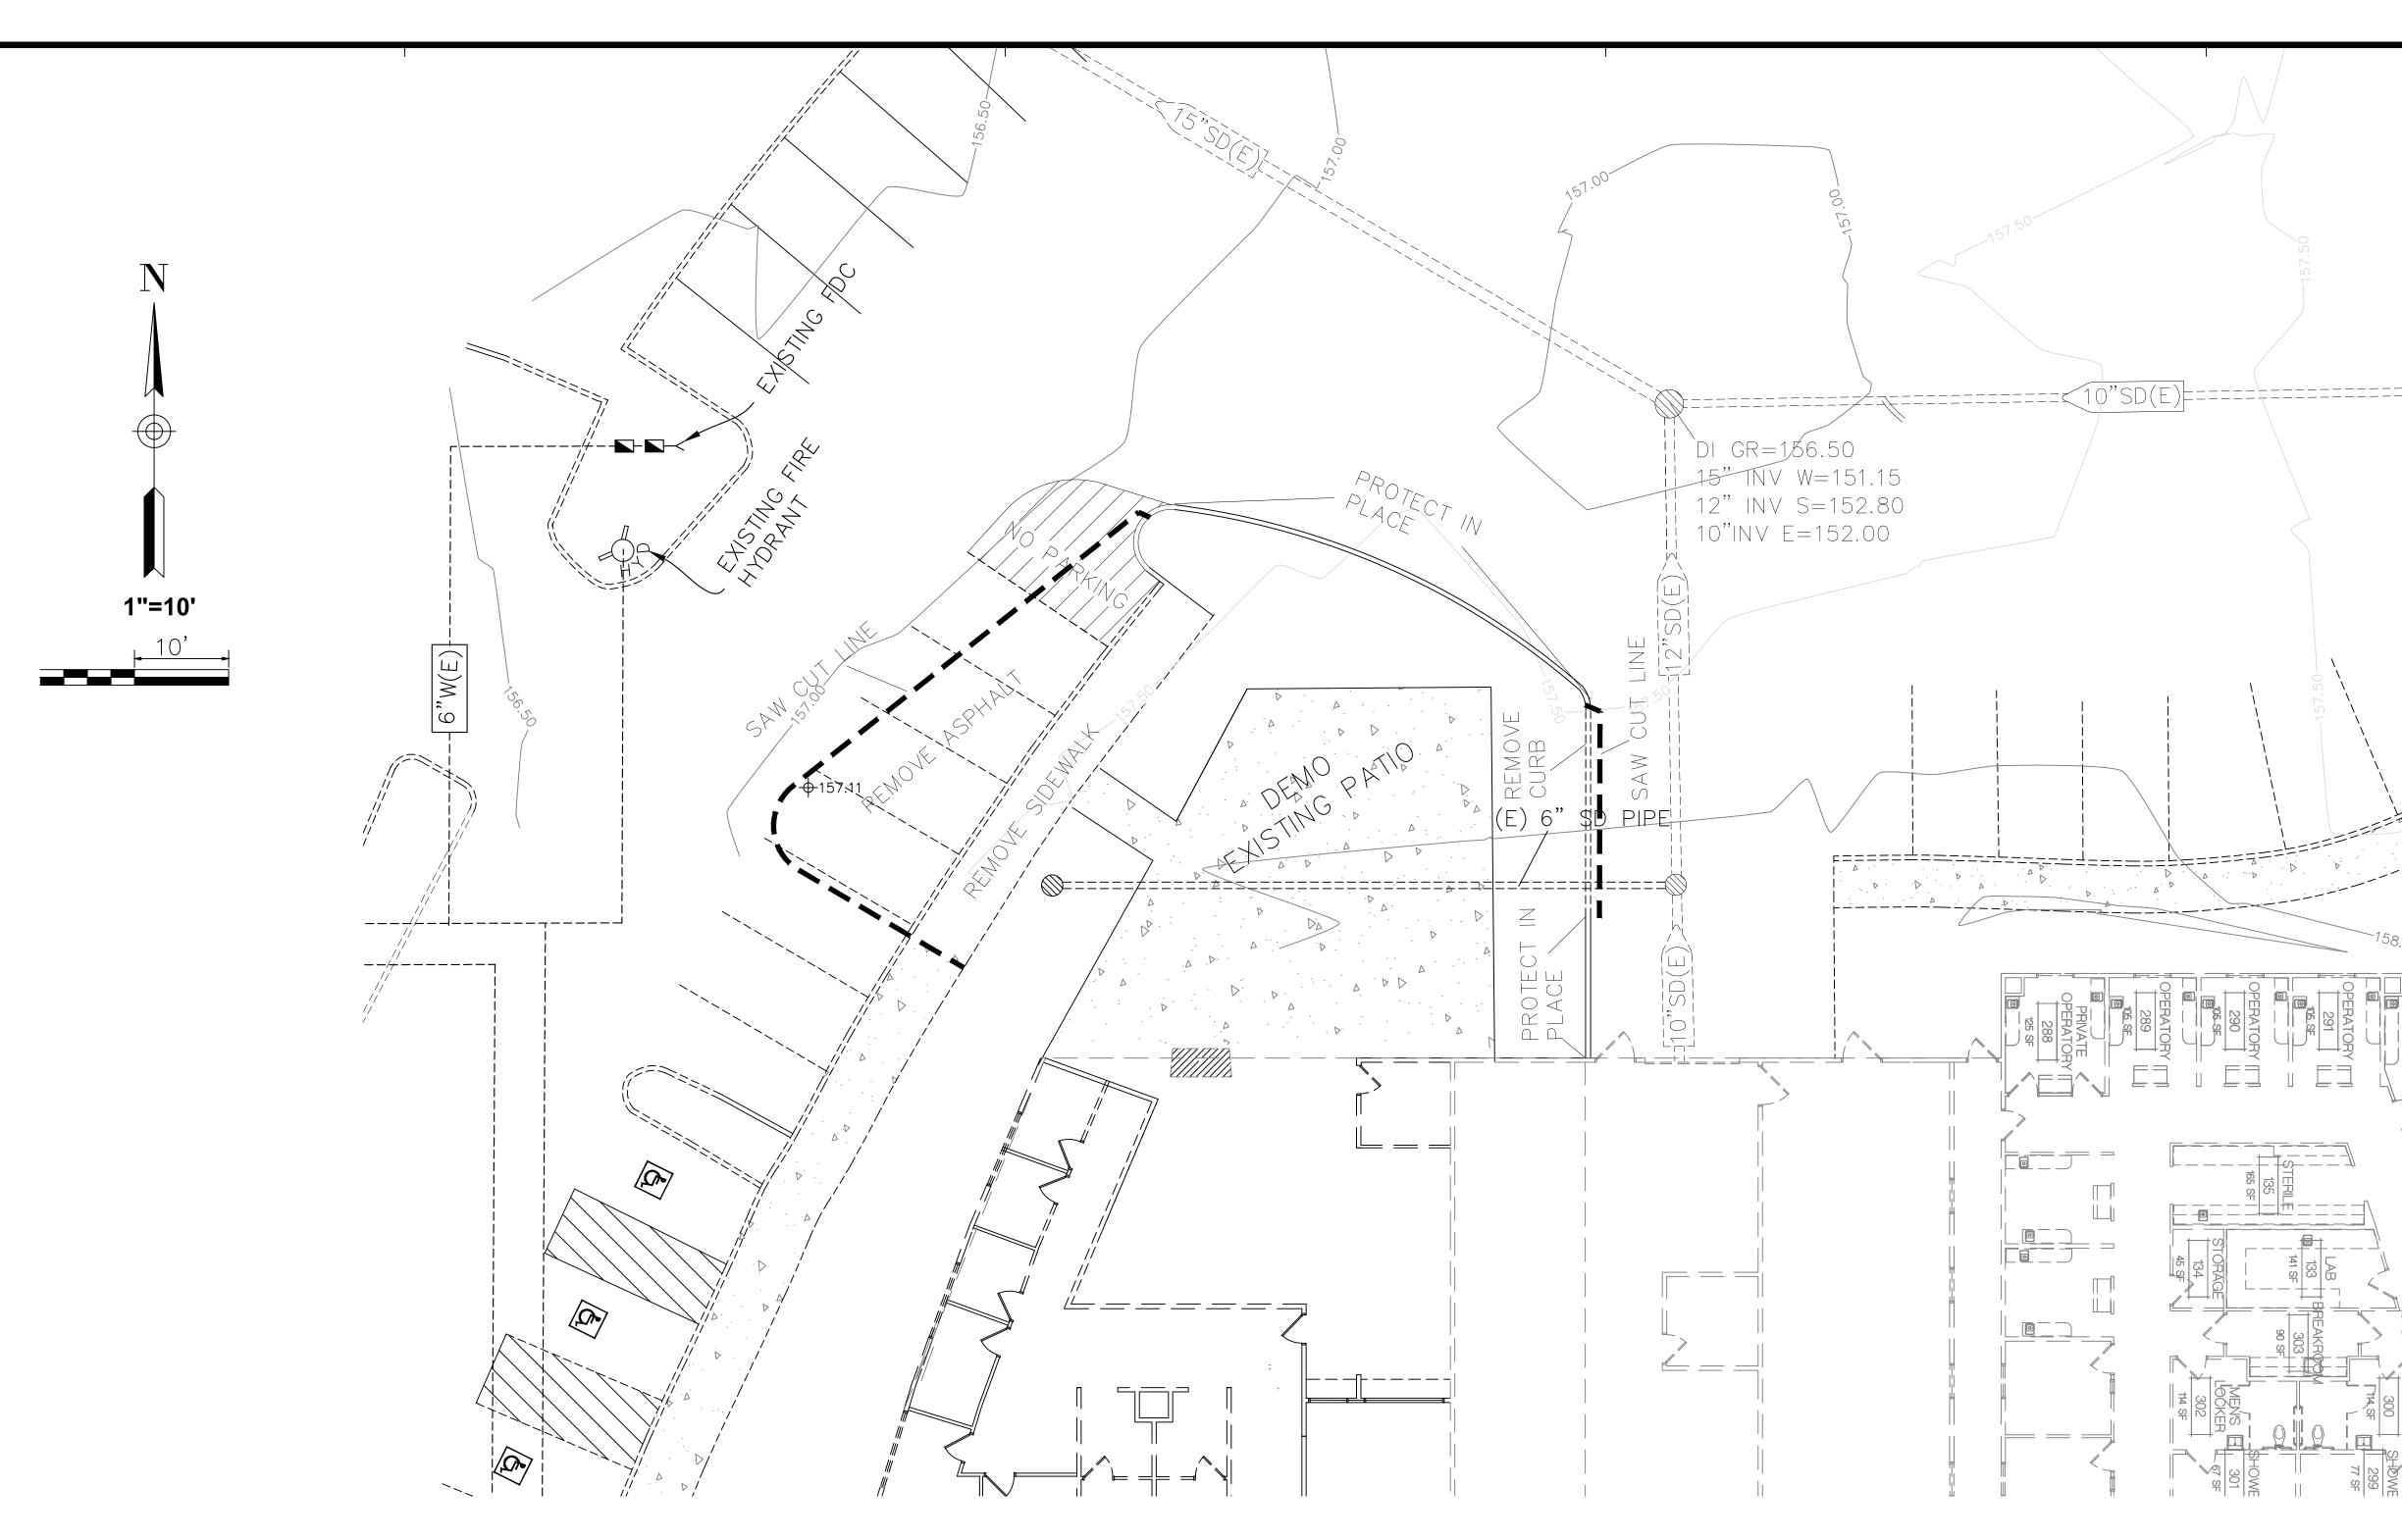

DEMOLITION & SITE PREPARATION NOTES

- 1. THE CONTRACTOR SHALL INCLUDE IN THE BID THE COST OF REMOVING ANY EXISTING SITE FEATURES AND APPURTENANCES NECESSARY TO ACCOMPLISH THE CONSTRUCTION OF THE PROPOSED SITE IMPROVEMENTS. THE CONTRACTOR SHALL ALSO INCLUDE IN THE BID THE COST NECESSARY TO RESTORE SUCH ITEMS IF THEY ARE SCHEDULED TO REMAIN AS PART OF THE FINAL SITE IMPROVEMENTS. REFER TO PLANS TO DETERMINE EXCAVATION, DEMOLITION AND TO DETERMINE THE LOCATION OF THE PROPOSED SITE IMPROVEMENTS.
- 2. THE OWNER RESERVES THE RIGHT TO REVIEW ALL MATERIALS DESIGNATED FOR REMOVAL AND TO RETAIN OWNERSHIP OF SUCH MATERIALS. IF THE OWNER RETAINS ANY MATERIAL THE CONTRACTOR SHALL MAKE ARRANGEMENTS WITH THE OWNER TO HAVE THOSE MATERIALS REMOVED OFF SITE AT NO ADDITIONAL COST.
- 3. UNLESS SPECIFICALLY NOTED TO BE SAVED / STOCKPILED OR REUSED / RELOCATED, ALL SITE FEATURES CALLED FOR REMOVAL SHALL BE REMOVED WITH THEIR FOOTINGS, ATTACHMENTS, BASE MATERIAL, ETC, TRANSPORTED FROM THE SITE TO BE DISPOSED OF IN A LAWFUL MANNER AT AN ACCEPTABLE DISPOSAL SITE AND AT NO COST TO THE OWNER.
- 4. ALL EXISTING SITE FEATURES TO REMAIN SHALL BE PROTECTED THROUGHOUT THE CONSTRUCTION PERIOD. ANY FEATURES DAMAGED DURING CONSTRUCTION OPERATIONS SHALL BE REPAIRED OR REPLACED TO THE SATISFACTION OF THE OWNER'S REPRESENTATIVE AT NO ADDITIONAL COST.
- 5. DURING EARTHWORK OPERATIONS, CONTRACTOR SHALL TAKE CARE TO NOT DISTURB EXISTING MATERIALS TO REMAIN, OUTSIDE THE LIMITS OF EXCAVATION AND BACKFILL AND SHALL TAKE WHATEVER MEASURES NECESSARY, AT THE

- CONTRACTOR'S EXPENSE, TO PREVENT ANY EXCAVATED MATERIAL FROM COLLAPSING. ALL BACKFILL MATERIALS SHALL BE PLACED AND COMPACTED AS SPECIFIED TO THE SUBGRADE REQUIRED FOR THE INSTALLATION OF THE REMAINDER OF THE CONTRACT WORK.
- 6. ALL ITEMS CALLED FOR REMOVAL SHALL BE REMOVED TO FULL DEPTH INCLUDING ALL FOOTINGS, FOUNDATIONS, AND OTHER APPURTENANCES, EXCEPT AS SPECIFICALLY NOTED OTHERWISE.
- 7. 'CLEAR AND GRUB VEGETATION' SHALL INCLUDE REMOVAL OF GRASS, SHRUBS, AND UNDERBRUSH, REMOVAL OF ROOTS, ROUGH GRADING, INSTALLATION OF LOAM (IF APPLICABLE), FINE GRADING, SEEDING AND TURF ESTABLISHMENT BY THE CONTRACTOR.
- 8. TREES DESIGNATED FOR REMOVAL SHALL BE TAGGED BY CONTRACTOR AND APPROVED BY OWNER'S REPRESENTATIVE PRIOR TO COMMENCEMENT OF CONSTRUCTION.
- 9. THE STORAGE OF MATERIALS AND EQUIPMENT WILL BE PERMITTED AT LOCATIONS DESIGNATED BY OWNER OR OWNER'S REPRESENTATIVE. PROTECTION OF STORED MATERIALS AND EQUIPMENT SHALL BE THE SOLE RESPONSIBILITY OF THE CONTRACTOR.
- 10. STRIP & STORE EXISTING TOPSOIL FOR LATER REUSE WHERE APPROPRIATE, AND AS NOTED ON PLAN, WITH APPROPRIATE EROSION AND SEDIMENT CONTROLS.
- 11. LOAM / TOP SOIL DESIGNATED FOR REUSE AS GENERAL FILL SHALL BE BLENDED WITH SUITABLE BORROW MATERIAL AS SPECIFIED.

- 12. THE CONTRACTOR SHALL PROTECT EXISTING TREES TO REMAIN, CONTRACTOR SHALL INSTALL TREE PROTECTION BARRIER AFTER CLEARING UNDERBRUSH AND TAKE DUE CARE TO PREVENT INJURY TO TREES DURING CLEARING OPERATIONS.
- CITY OF OROVILLE AND INFORMATION PROVIDED BY THE UTILITIES COMPANY. CONTRACTOR SHALL FIELD VERIFY LOCATION OF ALL EXISTING FACILITIES PRIOR TO CONSTRUCTION.
- 15. REMOVAL OF THE EXISTING OAK TREES SHALL BE DONE IN ACCORDANCE WITH THE REQUIREMENTS OF THE CITY OF OROVILLE. 16. AN ENCROACHMENT PERMIT SHALL BE OBTAINED FROM THE CITY OF OROVILLE FOR ANY WORK WITHIN THE CITY STREET RIGHT OF

14. LOCATION OF EXISTING WATER, SEWER, STORM DRAIN, GAS, AND ELECTRICAL LINES ARE APPROXIMATE AND IT WAS DETERMINED FROM

JOB TITLE:

THROUGH


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**REVISIONS:** # DATE DESCRIPTION

DATE DEC 2022 DRAWN RCM JOB NO. 22-1629



# NOTES:

CONTRACTOR SHALL PROVIDE ANY TEMPORARY ROADS OR CROSSINGS AS REQUIRED FOR EXECUTION OF THE CONTRACT.
ALL TEMPORARY CONSTRUCTION SHALL BE REMOVED AT THE COMPLETION OF THE PROJECT.

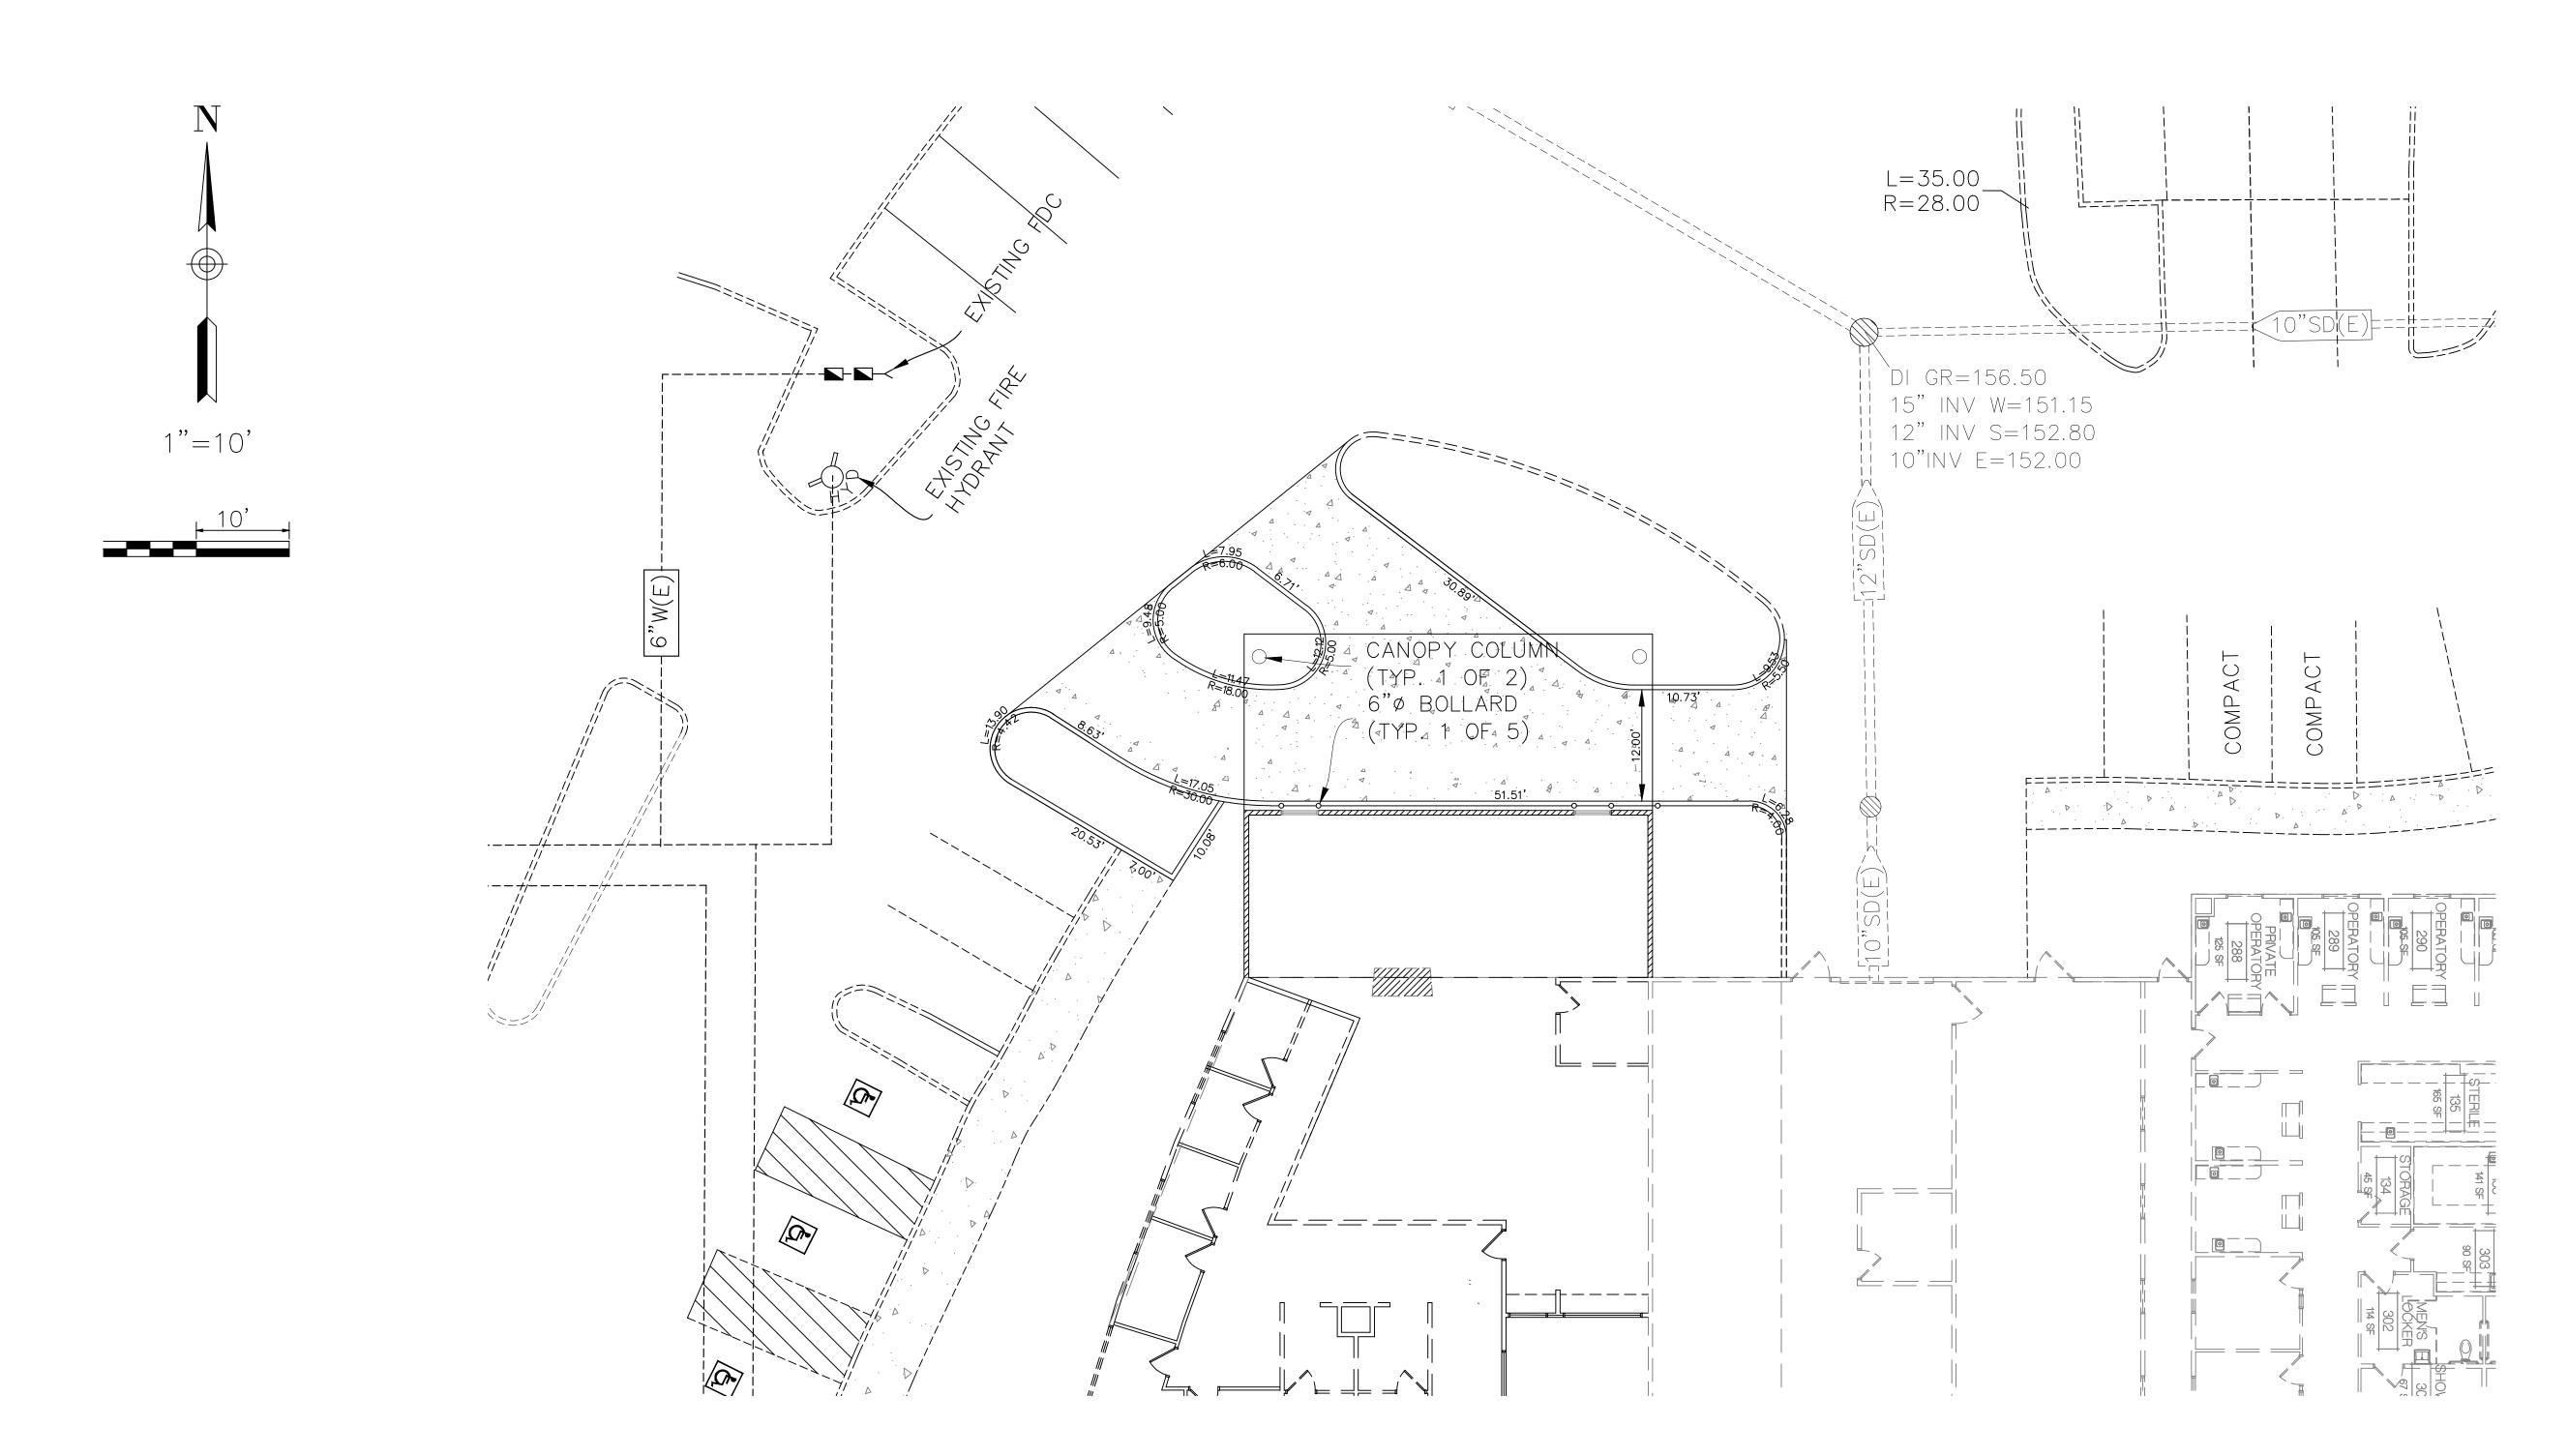A. WHERE NEW SITE WORK JOINS EXISTING CONDITIONS, EXISTING CONDITIONS SHALL CONTROL. IF MAJOR DISCREPANCIES ARE APPARENT, NOTIFY THE ENGINEER BEFORE PROCEEDING WITH THE WORK.

B. ALL EXISTING VEGETATION, SHRUBS, AND TREES TO REMAIN SHALL BE PROTECTED AS REQUIRED TO PREVENT DAMAGE FROM CONSTRUCTION ACTIVITIES. ANY DAMAGED LANDSCAPING SHALL BE REPLACED WITH LIKE PRODUCT AND LIKE SIZE AT THE DIRECTION OF THE ENGINEER.

C. EXISTING FACILITIES AND ITS AUXILIARY CONSTRUCTION SHALL BE PROTECTED FROM DAMAGE DURING THE COURSE OF NEW CONSTRUCTION ACTIVITIES. ANY DAMAGED MATERIAL SHALL BE REPLACED TO MATCH ORIGINAL CONDITIONS AT THE DIRECTION OF THE ENGINEER.

D. RELOCATION OF ALL UTILITY POLES, LINES AND OTHER EXISTING SERVICES (IF REQUIRED) SHALL BE THE RESPONSIBILITY OF THE CONTRACTOR AND SHALL BE VERIFIED AND COORDINATED WITH APPROPRIATE AGENCIES.

E. EXISTING UTILITY LINES SHALL REMAIN IN SERVICE DURING THE CONSTRUCTION PERIOD UNTIL SUCH TIME THAT NEW TIE-INS CAN BE MADE OPERATIONAL. CONTRACTOR SHALL REPAIR ANY DAMAGE TO EXISTING UTILITIES IMMEDIATELY TO INSURE NO INTERRUPTION IN UTILITY SERVICE.

F. REFER TO ELECTRICAL DOCUMENTS FOR SITE ELECTRICAL SERVICE REQUIREMENTS AND/OR SERVICE CONNECTION LOCATION.

G. REFER TO LANDSCAPE DOCUMENTS FOR HARDSCAPE, LANDSCAPE AND SITE IRRIGATION REQUIREMENTS.


H. REFER TO PLUMBING DOCUMENTS FOR PLUMBING UTILITY CONNECTION LOCATIONS.

I. REFER TO THE EXISTING SURVEY FOR TOPOGRAPHIC AND UTILITY INFORMATION.

J. THE GENERAL CONTRACTOR SHALL BE RESPONSIBLE FOR MAINTAINING THE INTEGRITY OF CONSTRUCTION FENCING ENCLOSURES AROUND THE CONSTRUCTION SITE.

NGINEERING & SURY 47 STARR DRIVE, SU YUBA CITY, CA 959

SITE PLAN

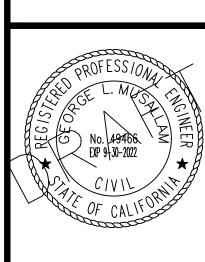

JOB TITLE:

PHARMACY DRIVE THROUGH
FEATHER RIVER TRIBAL HEALTH CENTER
2145 FIFTH AVENUE


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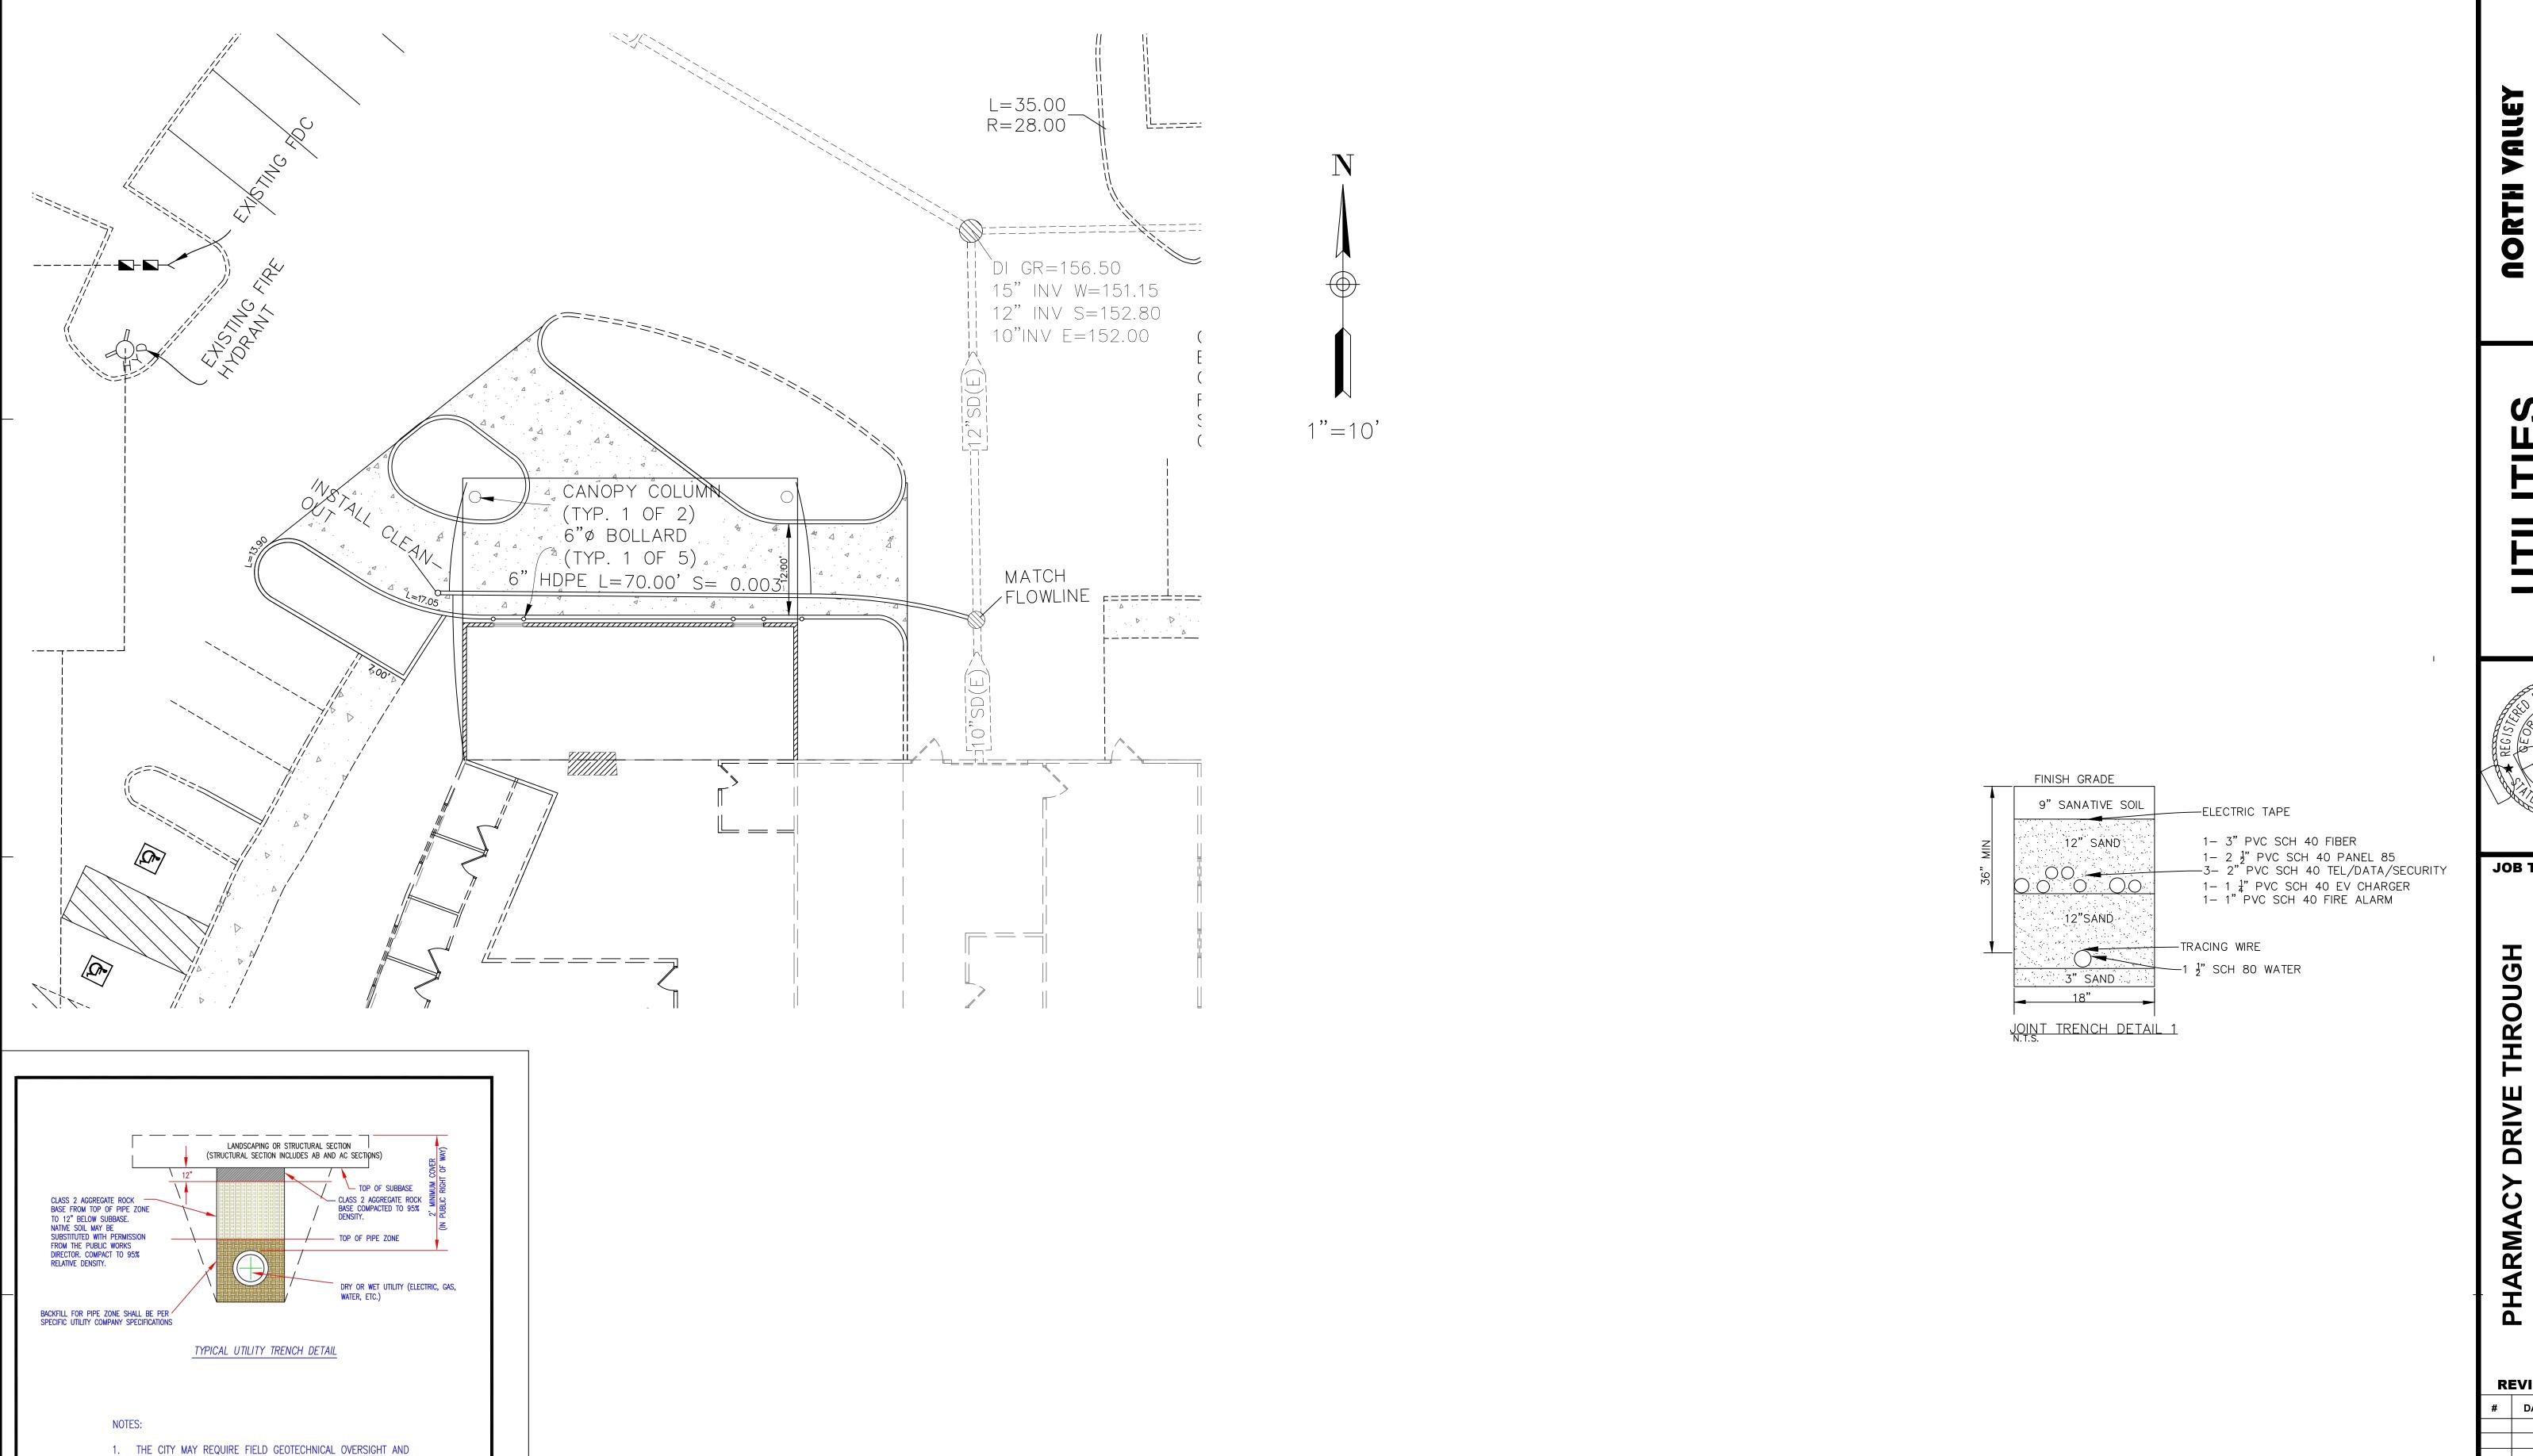
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DATE DEC 2022

DRAWN RCM
JOB NO. 22-1629

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FIELD DENSITY TESTING TO CONFIRM COMPLIANCE WITH THIS STANDARD. THE COST FOR FIELD OVERSIGHT SHALL BE PAID BY THE OWNER. COMPACTED BACKFILL MATERIAL NOT MEETING THE DENSITY REQUIREMENTS OF THIS STANDARD SHALL BE REMOVED, REPLACED, AND RECOMPACTED TO THE CITY'S SATISFACTION.


2. UTITILITY TRENCHES THAT ARE OUTSIDE OF VEHICULAR TRAFFIC

AREAS (i.e. PUE, LANDSCAPED AREAS, ETC.) MAY BE COMPACTED

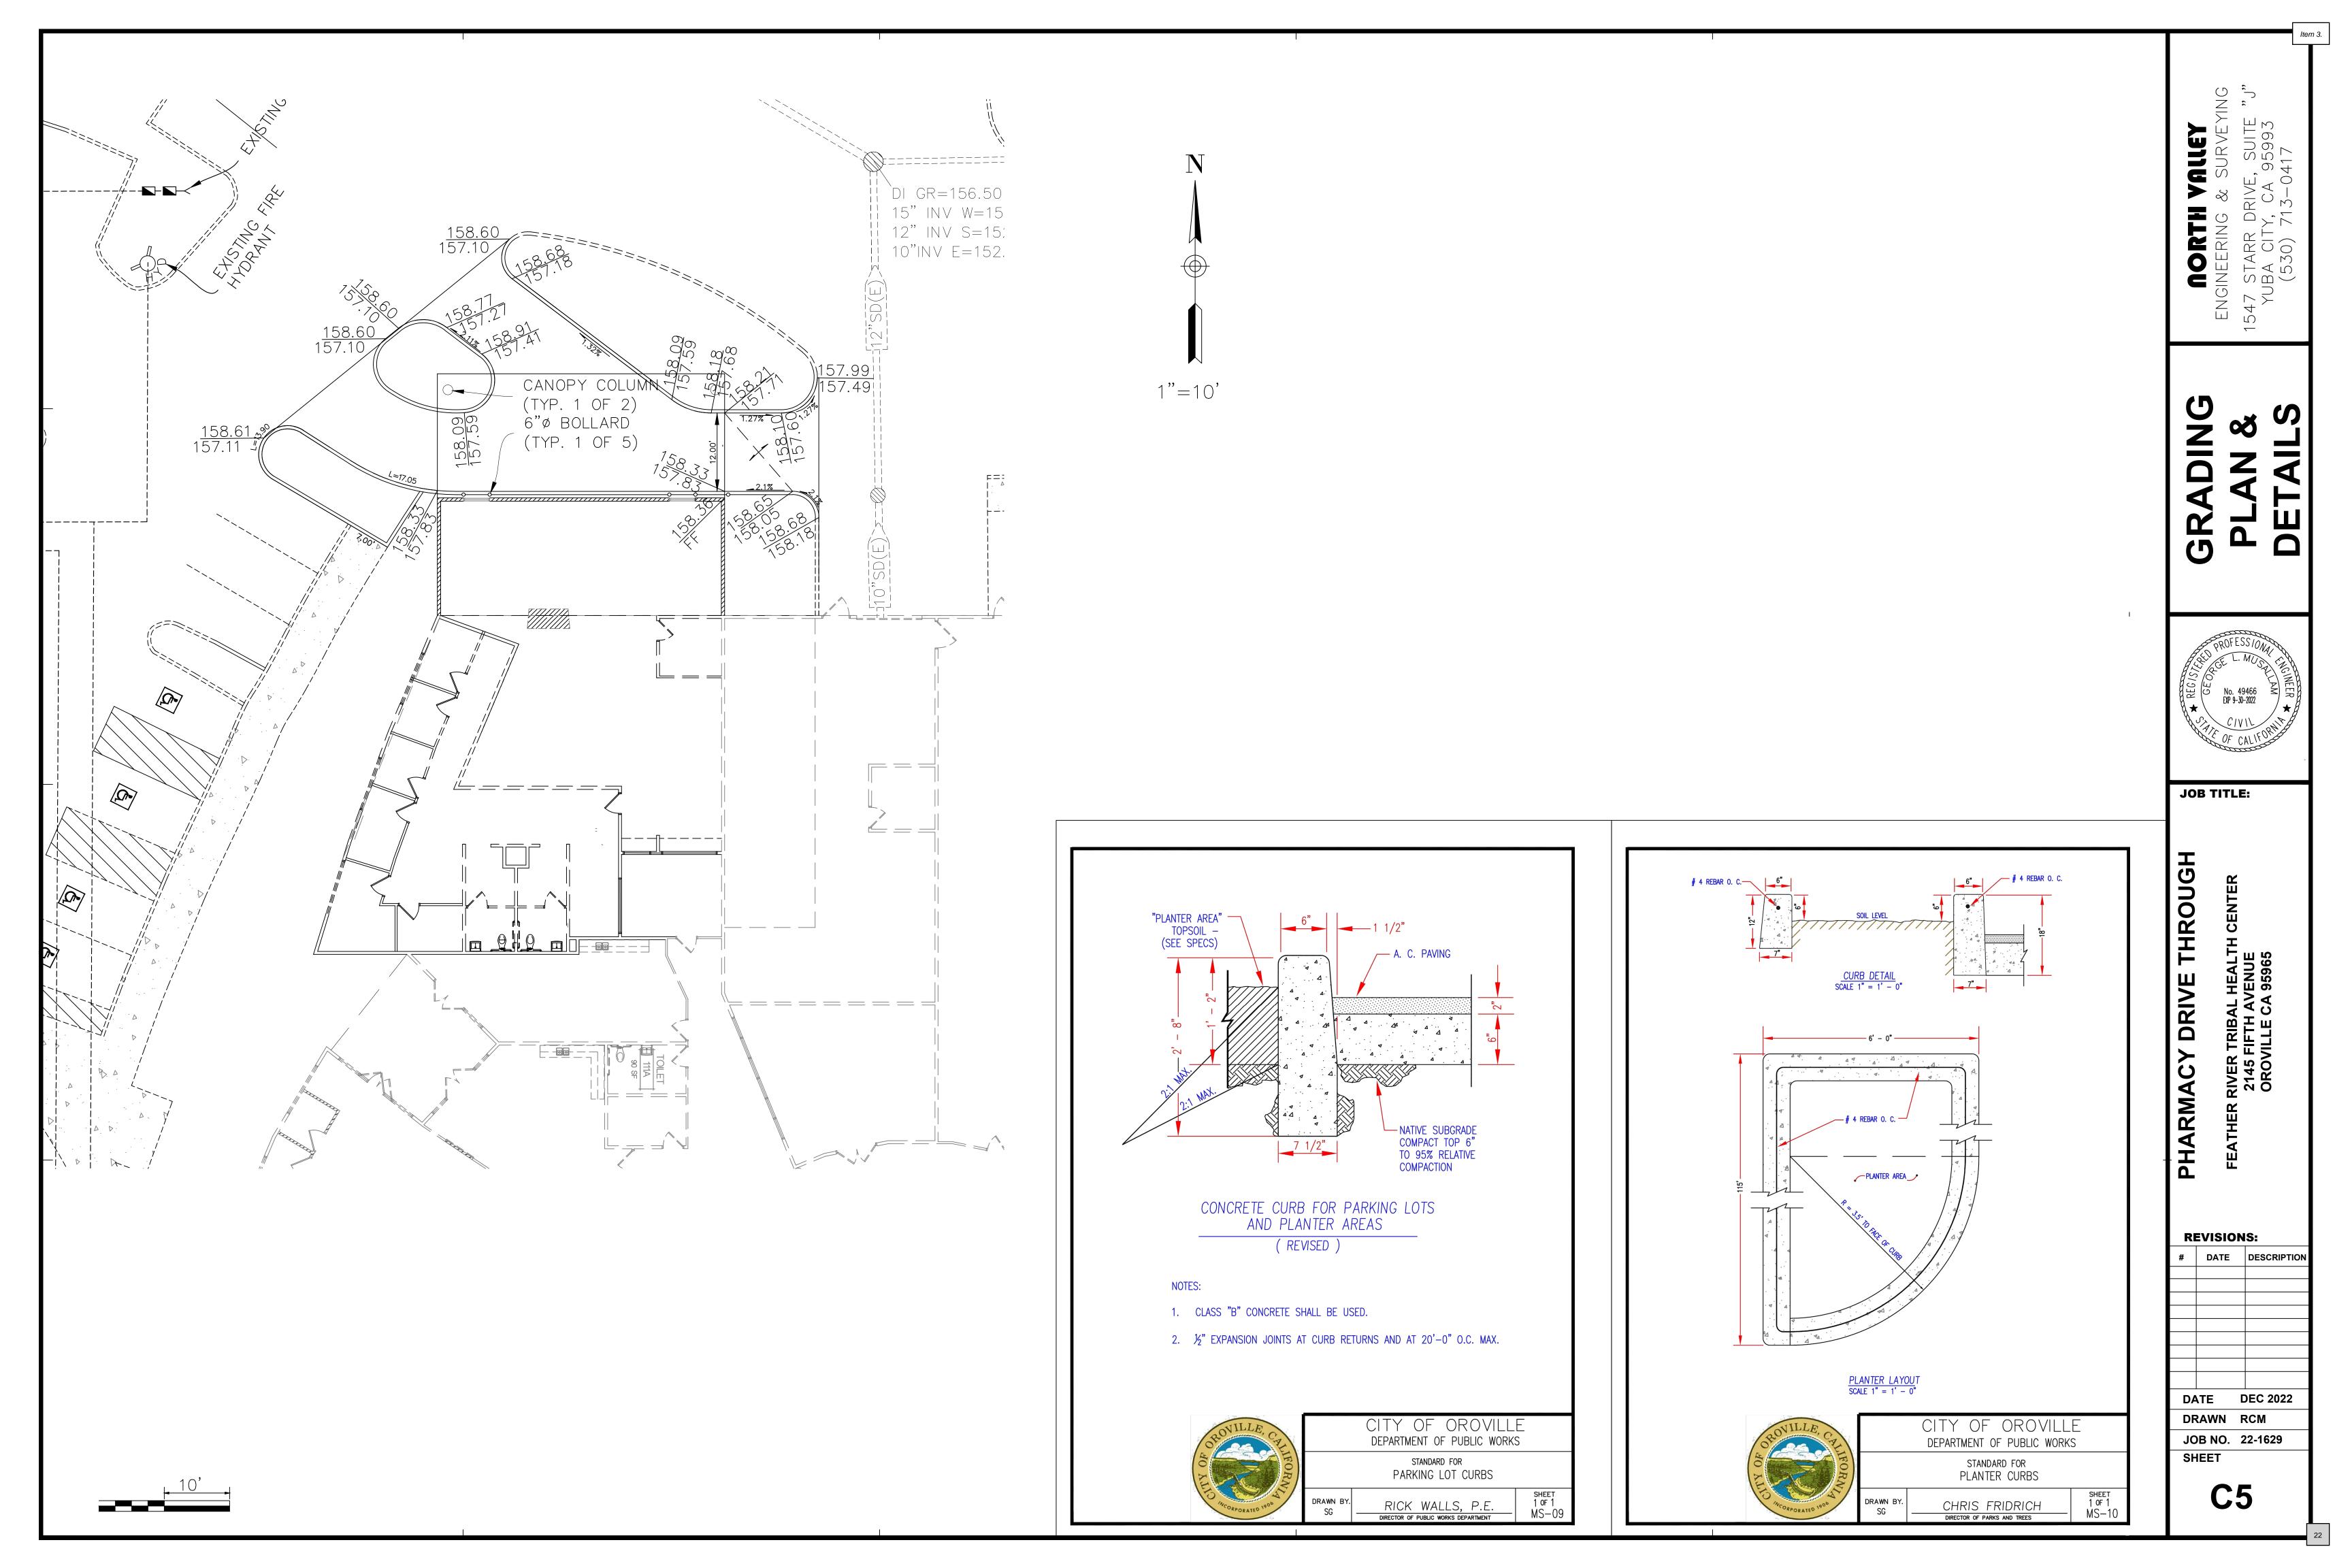CITY OF OROVILLE DEPARTMENT OF PUBLIC WORKS

STANDARD FOR JOINT UTILITY TRENCH DETAIL

RICK WALLS, P.E.
DIRECTOR OF PUBLIC WORKS DEPARTMENT

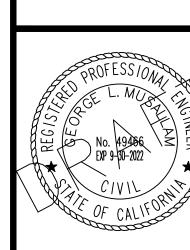


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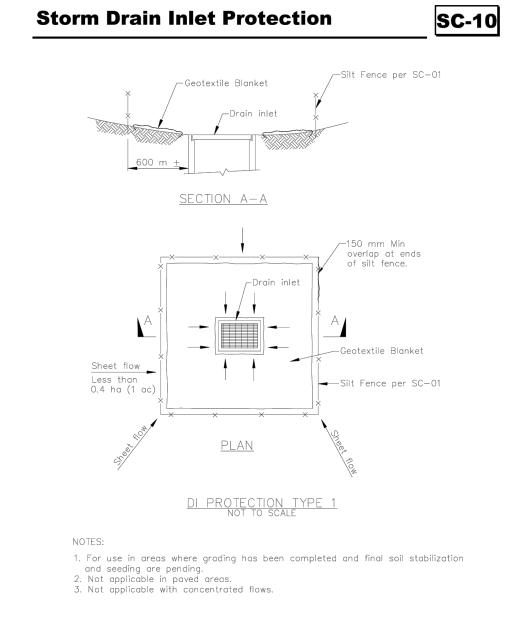
FEATHER RIVER TRIBAL HEALTH 2145 FIFTH AVENUE OROVILLE CA 95965 **PHARMACY** 

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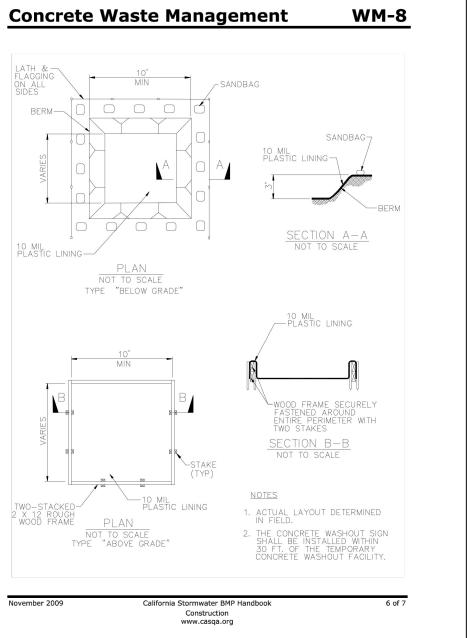
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# Vertical spacing along face of the slope varies between 3m and 6 m into a steeper slope TYPICAL FIBER ROLL INSTALLATION 300 mm mi ENTRENCHMENT DETAIL



# Construct sediment barrier and channelize runoff to emporary pipe culvert →B or four times the circumference of the largest construction vehicle tire, whichever is greater Stabilized Contraction Entrance/Exit (Type 1)

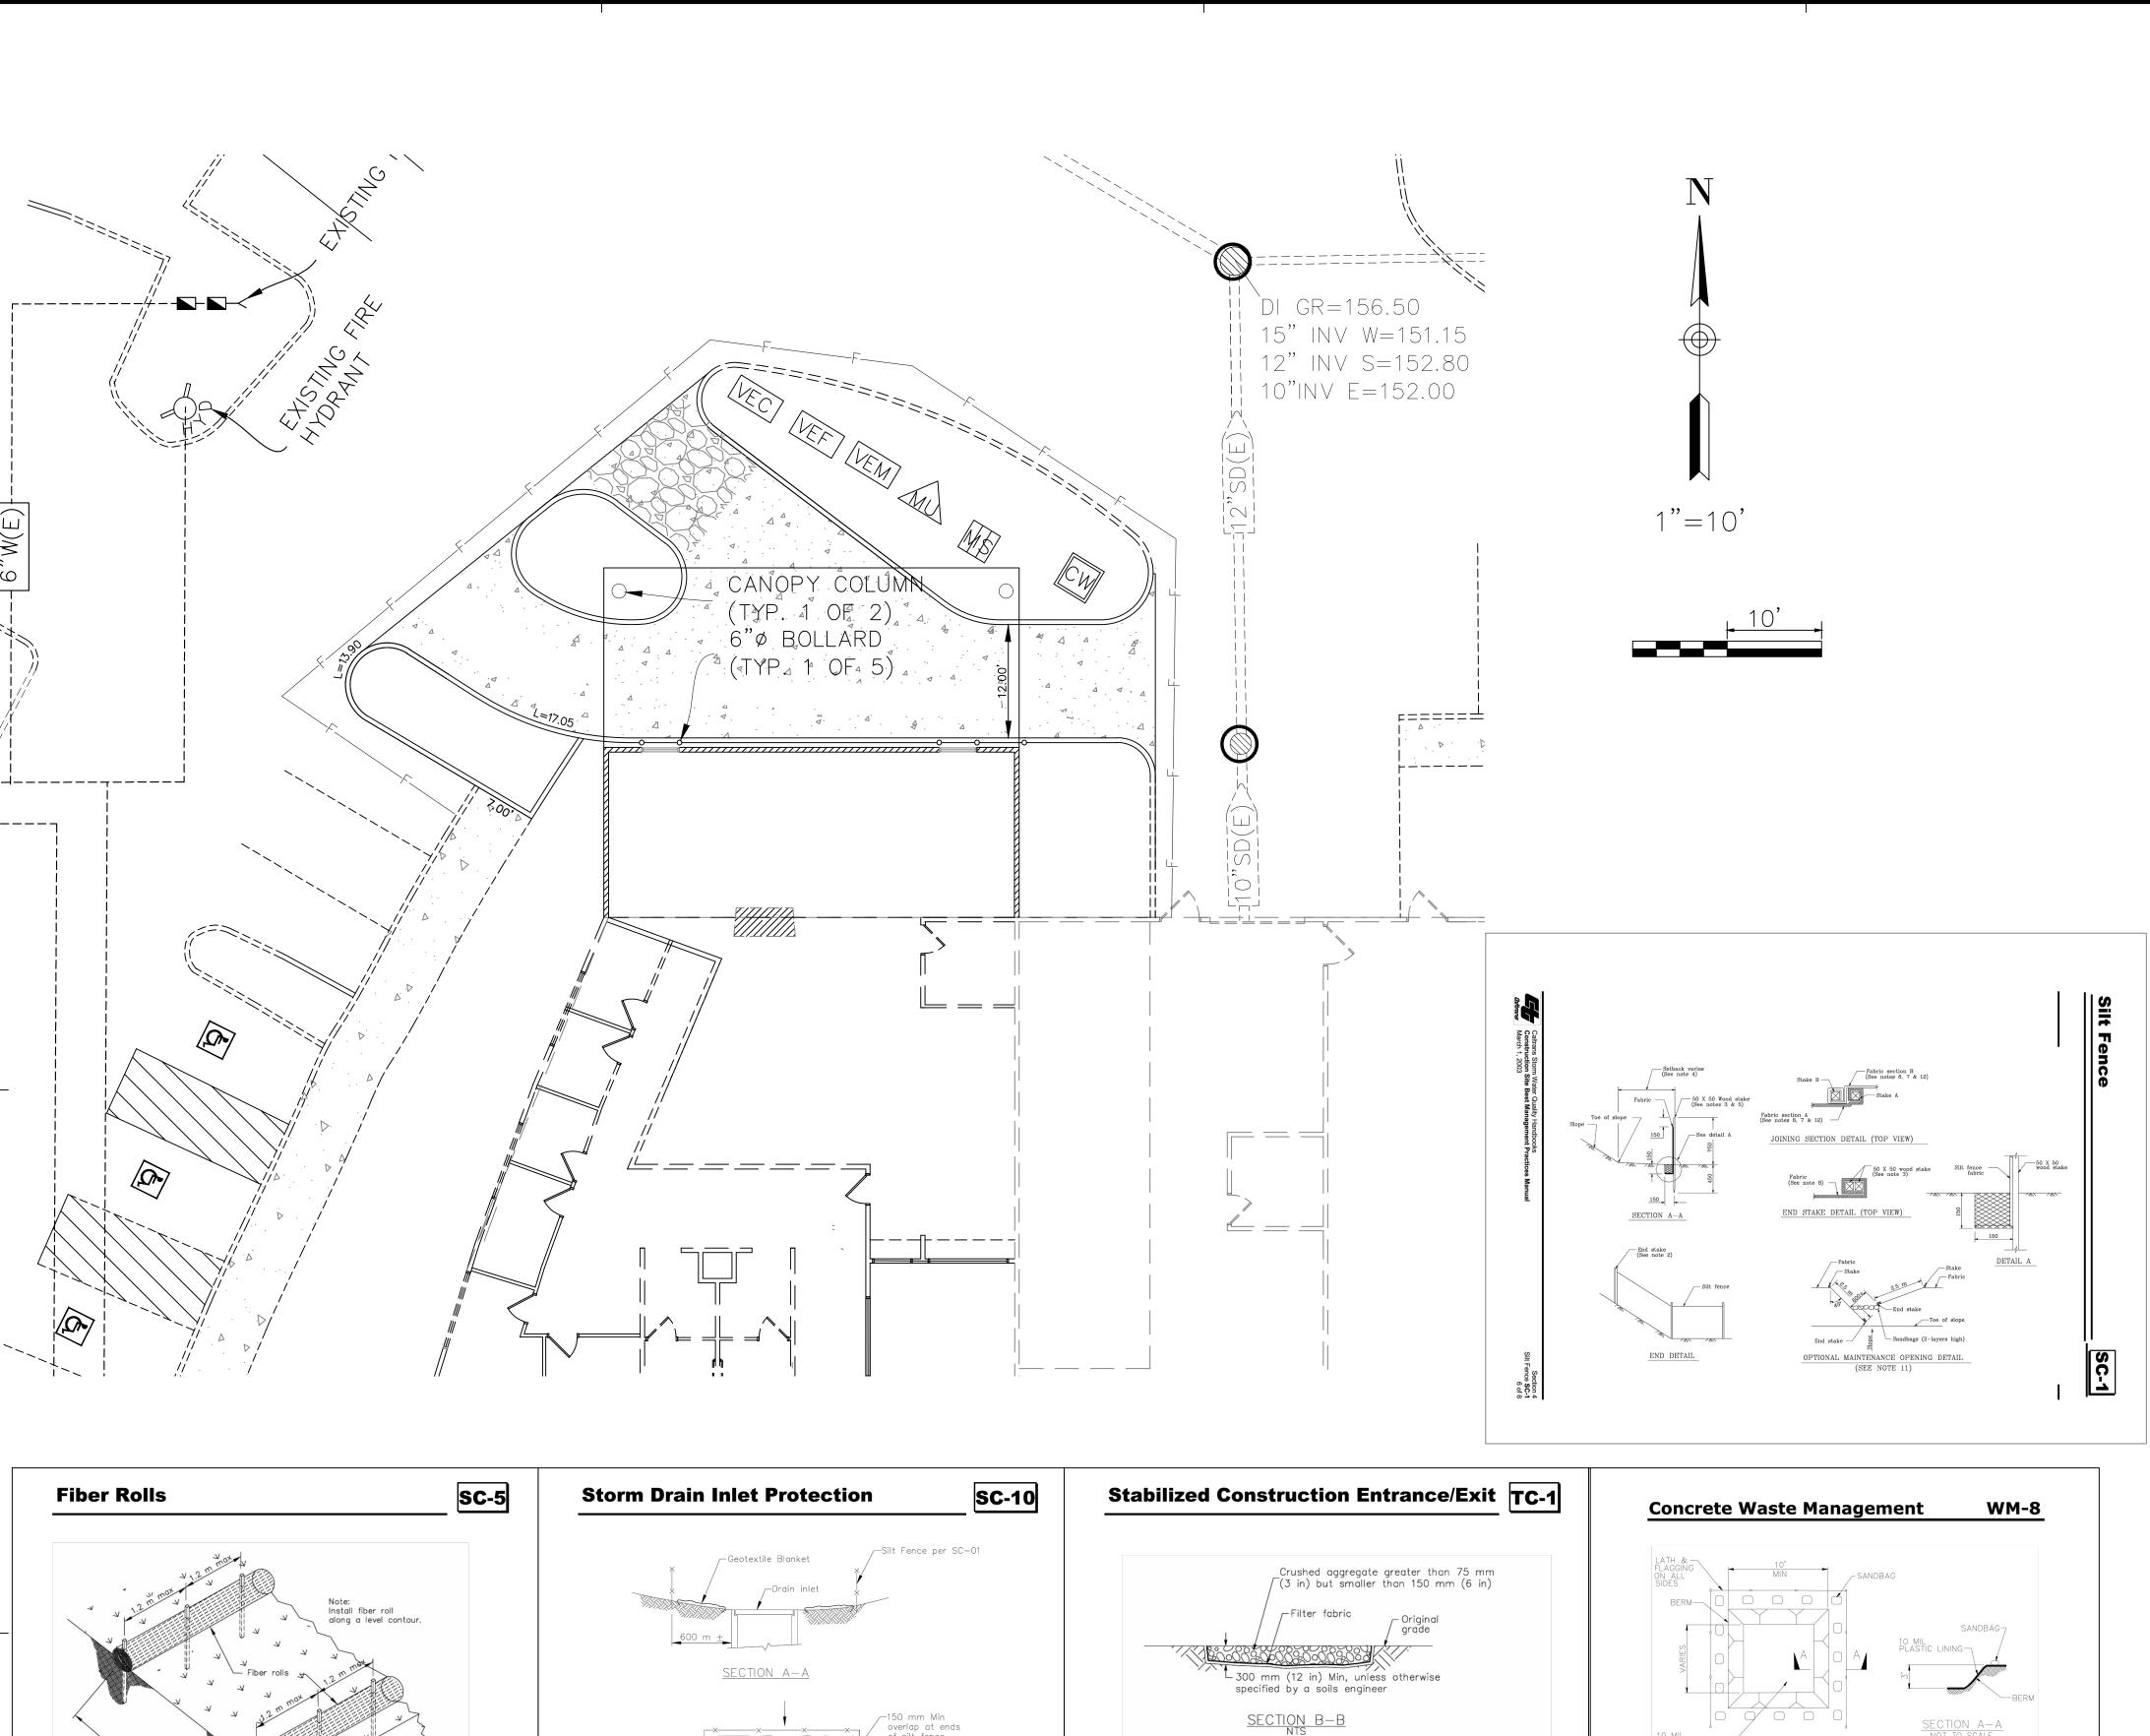

VEHICLE & EQUIPMENT CLEANING

REFER TO CAL TRANS CONSTRUCTION SITE BMP FACT SHEET NS-08 VEHICLE & EQUIPMENT FUELING

VEF REFER TO CAL TRANS CONSTRUCTION SITE BMP FACT SHEET NS-09 VEHICLE & EQUIPMENT MAINTENANCE VEM

REFER TO CAL TRANS CONSTRUCTION SITE BMP FACT SHEET NS-10



MATERIAL USAGE REFER TO CAL TRANS CONSTRUCTION SITE BMP FACT SHEET WM-02

MATERIAL STORAGE REFER TO CAL TRANS CONSTRUCTION SITE BMP FACT SHEET WM-01



CONCRETE WASHOUT REFER TO CAL TRANS CONSTRUCTION SITE BMP FACT SHEET WM-08



DRAWINGS.

STORM DRAIN INLET PROTECTION,

PAVED CONDITIONS (SEE DETAIL SC-10 THIS SHEET) - BLOOK & GRAVEL FILTER UNPAVED CONDITIONS (SEE DETAIL SC-5 THIS SHEET) - FIE


SEE DETAIL SC-5 THIS SHEET SEE DETAIL SC-1 THIS SHEET

### BEST MANAGEMENT PRACTICES (BMP'S)

1. ALL EROSION CONTROL MEASURES SHALL CONFORM TO THE CITY OF GRIDLEY STANDARDS AND THE EROSION CONTROL PLANS A SHOWN IN THE CONSTRUCTION

- 2. INTERIM EROSION CONTROL MEASURES MAY BE NEEDED AND SHALL BE INSTALLED DURING CONSTRUCTION TO ASSURE ADEQUATE EROSION CONTROL FACILITIES ARE IN PLACE AT ALL TIMES.
- 3. ALL MULCH SHALL BE STRAW OR RICE 4. ALL SANDBAGS SHALL BE GRAVEL OR SAND FILLED BAGS UNLESS SPECIFIED DIFFERENTLY.
- 5. ALL SLOPES GREATER THAN 10% AND LESS THAN 50% THAT ARE FREE OF VEGETATION SHALL HAVE MULCH
- SPREAD PRIOR TO 30% CHANCE OF RAIN. 6. THE CURRENT BEST AVAILABLE BMP'S FOR SEDIMENT CONTROL SHALL BE APPLED BY THE INSTALLATION OF A SEDIMENT CONTROL PRODUCT BEHIND THE BACK OF CURB AND/OR SIDEWALK.
- 7. DURING ALL CONSTRUCTION ACTIVITIES, DUST CONTROL MEASURES IN THE FORM OF WATER APPLICATION TO ALL EXPOSED SOIL SURFACES WHERE STORM RUNOFF IS EXPOSED TO THE VEGETATION. THIS IS FOR THE PREVENTION OF AIRBORNE PARTICULANTS FOR THE SITE WATERING OF EXPOSED SOIL SURFACES SHALL OCCUR AT LEAST TWICE DAILY, PREFERABLY IN THE LATE MORNING AND AFTER WORK IS DONE FOR THE DAY. ALL CLEARING, GRADING, EARTH MOVING OR EXCAVATION ACTIVITIES SHALL CEASE WHEN WINDS EXCEED 15 MPH AVERAGED OVER 1
- 8. THE CONTRACTOR MAY PROVIDE CATCH BASIN FILTERS TO HELP REMOVE SEDIMENTS, OIL/GREASE AND HEAVY METALS FROM STORM WATER RUNOFF.
- 9. ALL ON SITE PARKING SHALL BE PAVED AS SOON AS FEASIBLE OR WATERED PERIODICALLY OR CHEMICALLY STABILIZED.
- 10. HAUL TRUCKS SHALL BE COVERED WITH TARPAULINS OR OTHER EFFECTIVE COVERS AT ALL TIMES.
- 11. BMP'S ARE TO BE IMPLEMENTED AND BE OPERATIONAL ON A DAILY BASIS DURING ALL PHASES OF THE CONSTRUCTION. ADDITIONAL BMP'S MAY NEED TO BE IMPLEMENTED DURING THE WET SEASON.
- 12. TO HELP INCREASE STORM WATER INFILTRATION AND INCREASE THE RETENTION OF SEDIMENT, HEAVY METALS, TOXIC MATERIALS, OIL/GREASE, BACTERIA & TRENCHES LOCATED IN THE MEDIAN STRIPS AND PLANTER STRIPS ADJACENT TO THE SIDEWALKS. ALSO, A STORM WATER DETENTION POND CAN BE CONSTRUCTED FOR THE SAME REASONS. BIOFILTER LINED AND/OR VEGETATED SWALES MAY BE CONSTRUCTED FOR REASONS STATED ABOVE.
- 13. WATTLES ARE TO BE PLACED IN A KEY TRENCH PREPARED 2"-4" DEEP. THE EXCESS SOIL CREATED FROM TRENCHING SHALL BE PLACED ON THE UPPER SIDE OF THE WATTLE TO PREVENT EROSION AND UNDERCUTTING FROM SHEET FLOWS.
- 14. WATTLES SHALL BE STAKED IN PLACE, OR RETAINED WITH STAKED AND ROPE RESTRAINTS. STAKES CAN ALSO BE PLACED ON ALTERNATING SIDES OF THE WATTLE TO ANCHOR IT. THE 3/4"X3/4"24" STAKE SHOULD BE PLACED WITHIN 4 FEET OF THE ENDS. IF MORE THAN ONE ROLL IS PLACED IN A ROW, THE ROLLS SHOULD BE OVERLAPPED. NOT ABUTTED.
- 15. WATTLES SHOULD BE INSPECTED FOR SLUMPING, TEARS IN THE FIBER MESH COVER, AND OTHER SIGNS OF INEFFECTIVE PLACEMENT AND REPLACED WHEN NECESSARY. THE WATTLES HSOULD ESPECIALLY BE INSPECTED BEFORE RAIN OCCURS AND CHECKED DAILY DURING RAINFALL. AFTER PROJECT COMPLETION, WATTLES MAY BE REUSED IF THEY ARE NOT EXCESSIVELY SOILED OR DAMAGED.

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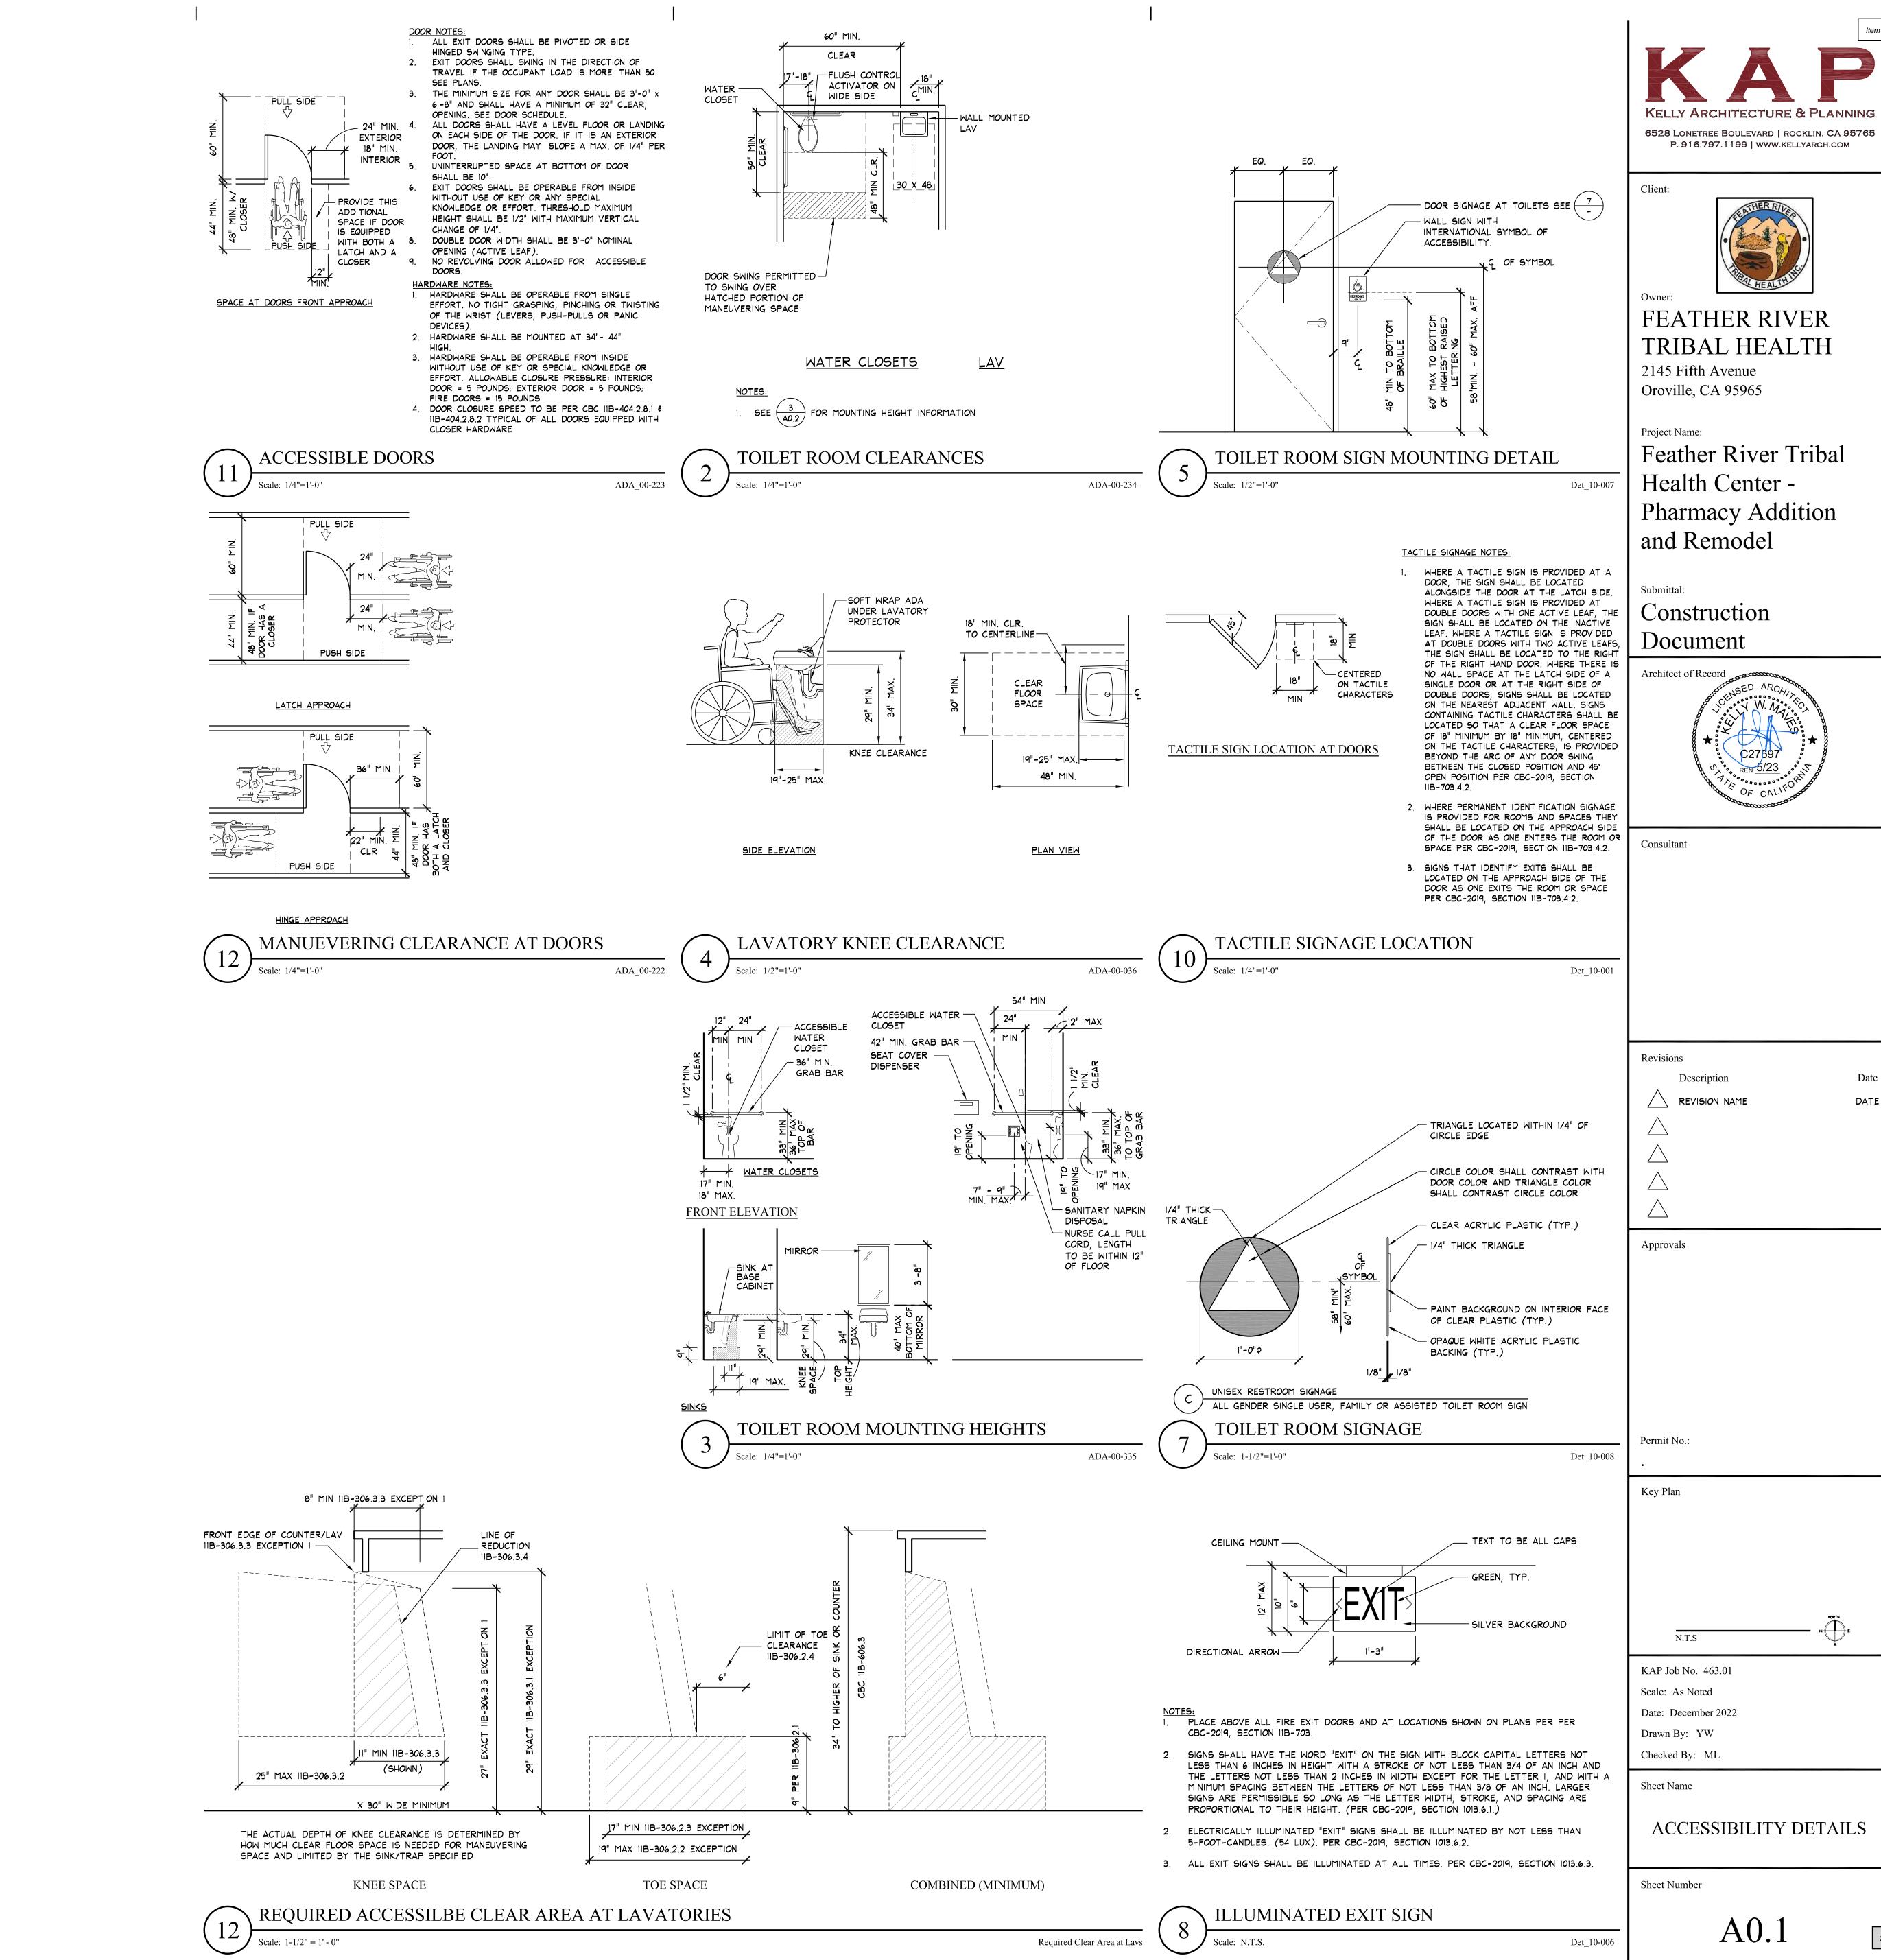

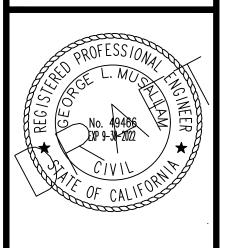
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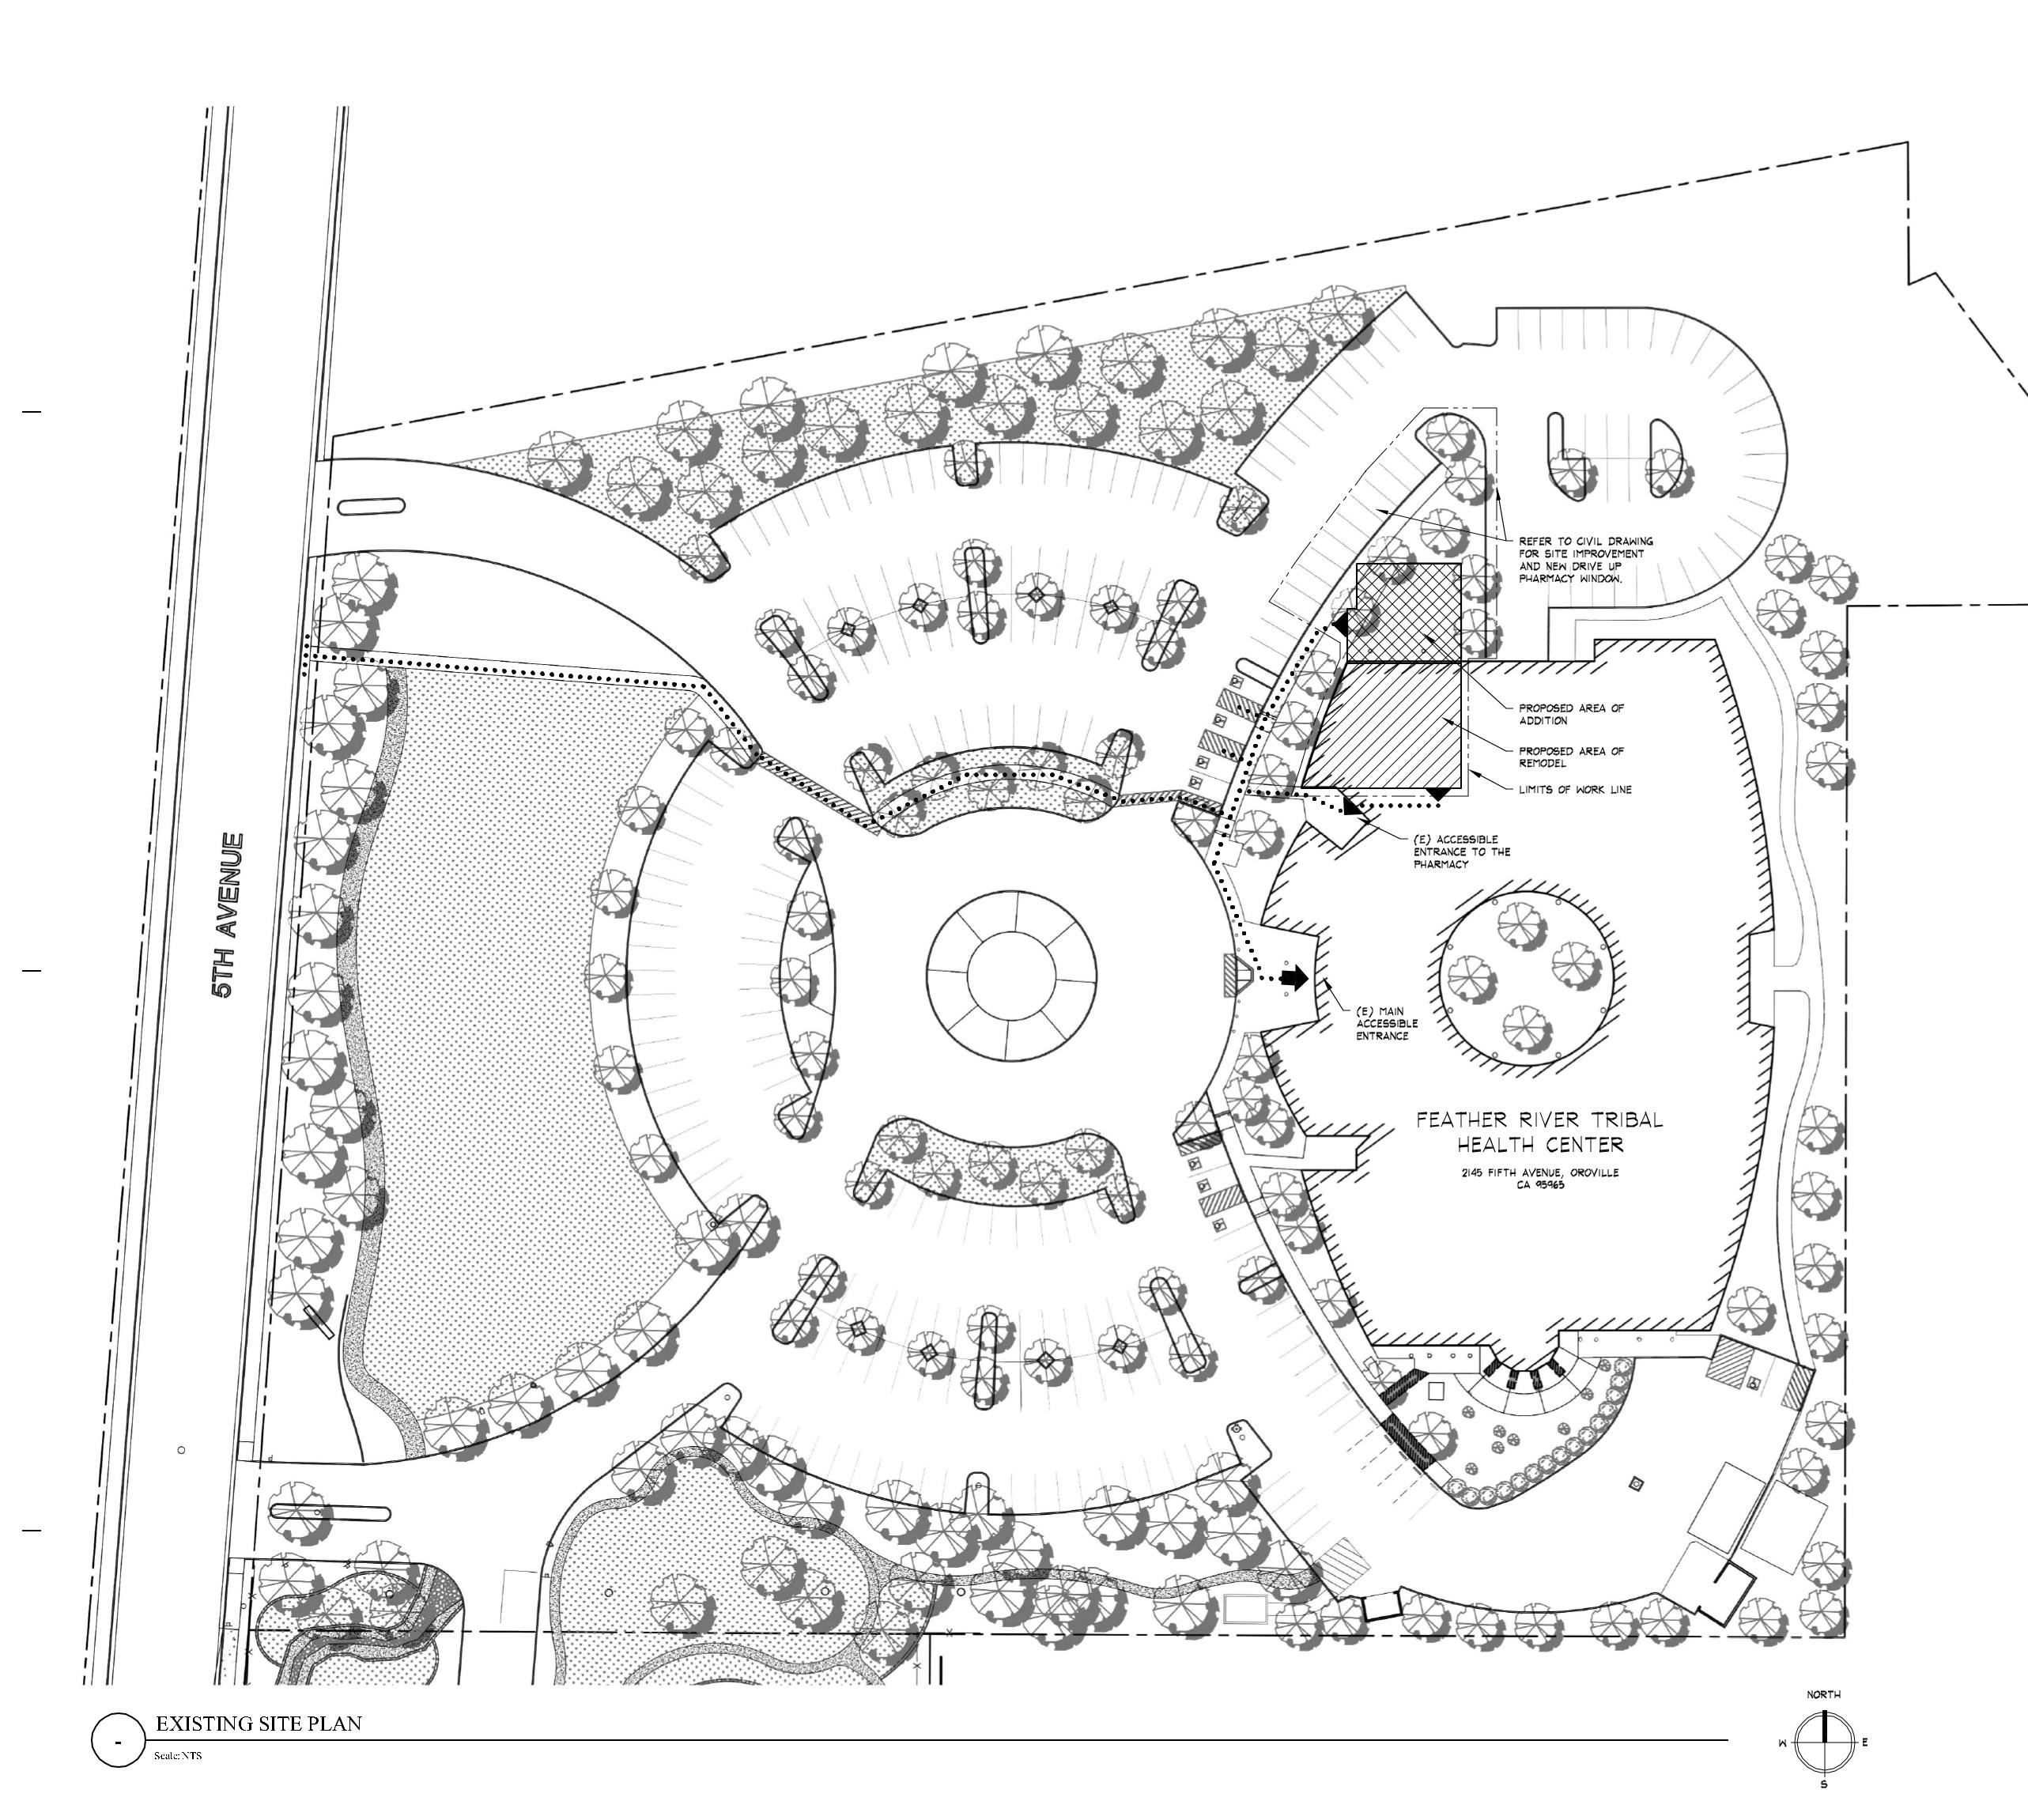
THROUG DRIVE RIVER TRIBA 2145 FIFTH A OROVILLE C PHARMAC

**REVISIONS:** # DATE DESCRIPTION DATE DEC 2022 DRAWN RCM JOB NO. 22-1629

SHEET



DATE



# SITE ANALYSIS

CITY OF OROVILLE MUNICIPAL CODE

ASSESSOR'S PARCEL NUMBER: LOT SIZE: ZONING:

035-250-080-000
1.09 ACRES (47,490 S.F.)
PQ - PUBLIC OR QUASI-PUBLIC FACILITIES
NO CHANGES TO BUILDING FOOTPRINT OR
DEVELOPMENT STANDARDS.
MEDICAL SERVICES



# GENERAL NOTES


- I. LIMIT OF WORK / CONTRACT BOUNDARY IS SHOWN FOR INTENT ONLY. ADDITIONAL WORK MAY BE REQUIRED OUTSIDE THIS PROJECT BOUNDARY AS NECESSARY TO PROVIDE A COMPLETE PROJECT. CONTRACTOR TO COORDINATE CONSTRUCTION STAGING AREA WITH PROPERTY OWNER.
- . ACCESS TO SITE, ADJACENT TENANTS AND/OR BUILDING, AND FIRE ACCESS ROUTES ARE TO BE MAINTAINED AND CLEAR AT ALL TIMES DURING ALL PHASES OF CONSTRUCTION.

  COORDINATE CONSTRUCTION STAGING AREA WITH PROPERTY OWNER PRIOR TO COMMENCEMENT
- THE ACCESSIBLE PATH OF TRAVEL, AS INDICATED ON THIS SHEET, IS A BARRIER FREE ACCESS ROUTE WITHOUT ANY ABRUPT VERTICAL CHANGES THAT DO NOT EXCEED 1/4" MAX OR 1/2" AT 1:12 SLOPE MAX. ANY ELEVATION CHANGES ARE RAMPED AT 1:12 SLOPE MAX PER THE GOVERNING LAWS OR BY APPROVED ELEVATORS. THE CROSS SLOPE AT ANY POINT ALONG THE PATH OF TRAVEL SHALL NOT EXCEED 2% SLOPE MAX. A CLEAR WIDTH NO LESS THAN 48". THE CONTRACTOR SHALL VERIFY THAT THE COMPLETE ACCESSIBLE PATH INDICATED IS FREE OF BARRIERS AND COMPLIES WITH VERTICAL CHANGE AND CROSS SLOPE MAXIMUMS.
- 4. ALL PARKING FACILITIES REMAIN UNCHANGED.

# SITE LEGEND


---- EXISTING PROPERTY LINE

EXISTING ACCESSIBLE PATH OF TRAVEL FROM BUILDING MAIN ENTRANCE TO PARKING AND PUBLIC WAY. SEE SHEET GENERAL NOTES AND DETAILS CALLED OUT ON THE PLAN FOR ADDITIONAL INFORMATION.

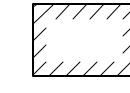


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(E) BUILDING / STRUCTURE TO REMAIN

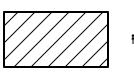

PROPOSED AREA OF RENOVATION

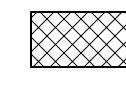

LEGAL EXIT TO EXTERIOR

PROPOSED ADDITION



MAIN ENTRANCE / SUITE ENTRANCE INTO BUILDING




FEATHER RIVER TRIBAL HEALTH 2145 Fifth Avenue

Oroville, CA 95965

Feather River Tribal Health Center -Pharmacy Addition and Remodel

Submittal: Construction Document

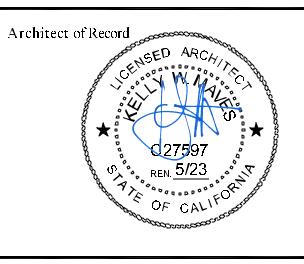


Consultant

Revisio	ns		
	Description		Date
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Approvals

Key Plan

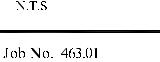

KAP Job No. 463.01 Scale: As Noted Date: December 2022 Drawn By: YW


Checked By: ML

Sheet Name

Overall Site Plan

Sheet Number

A1.1

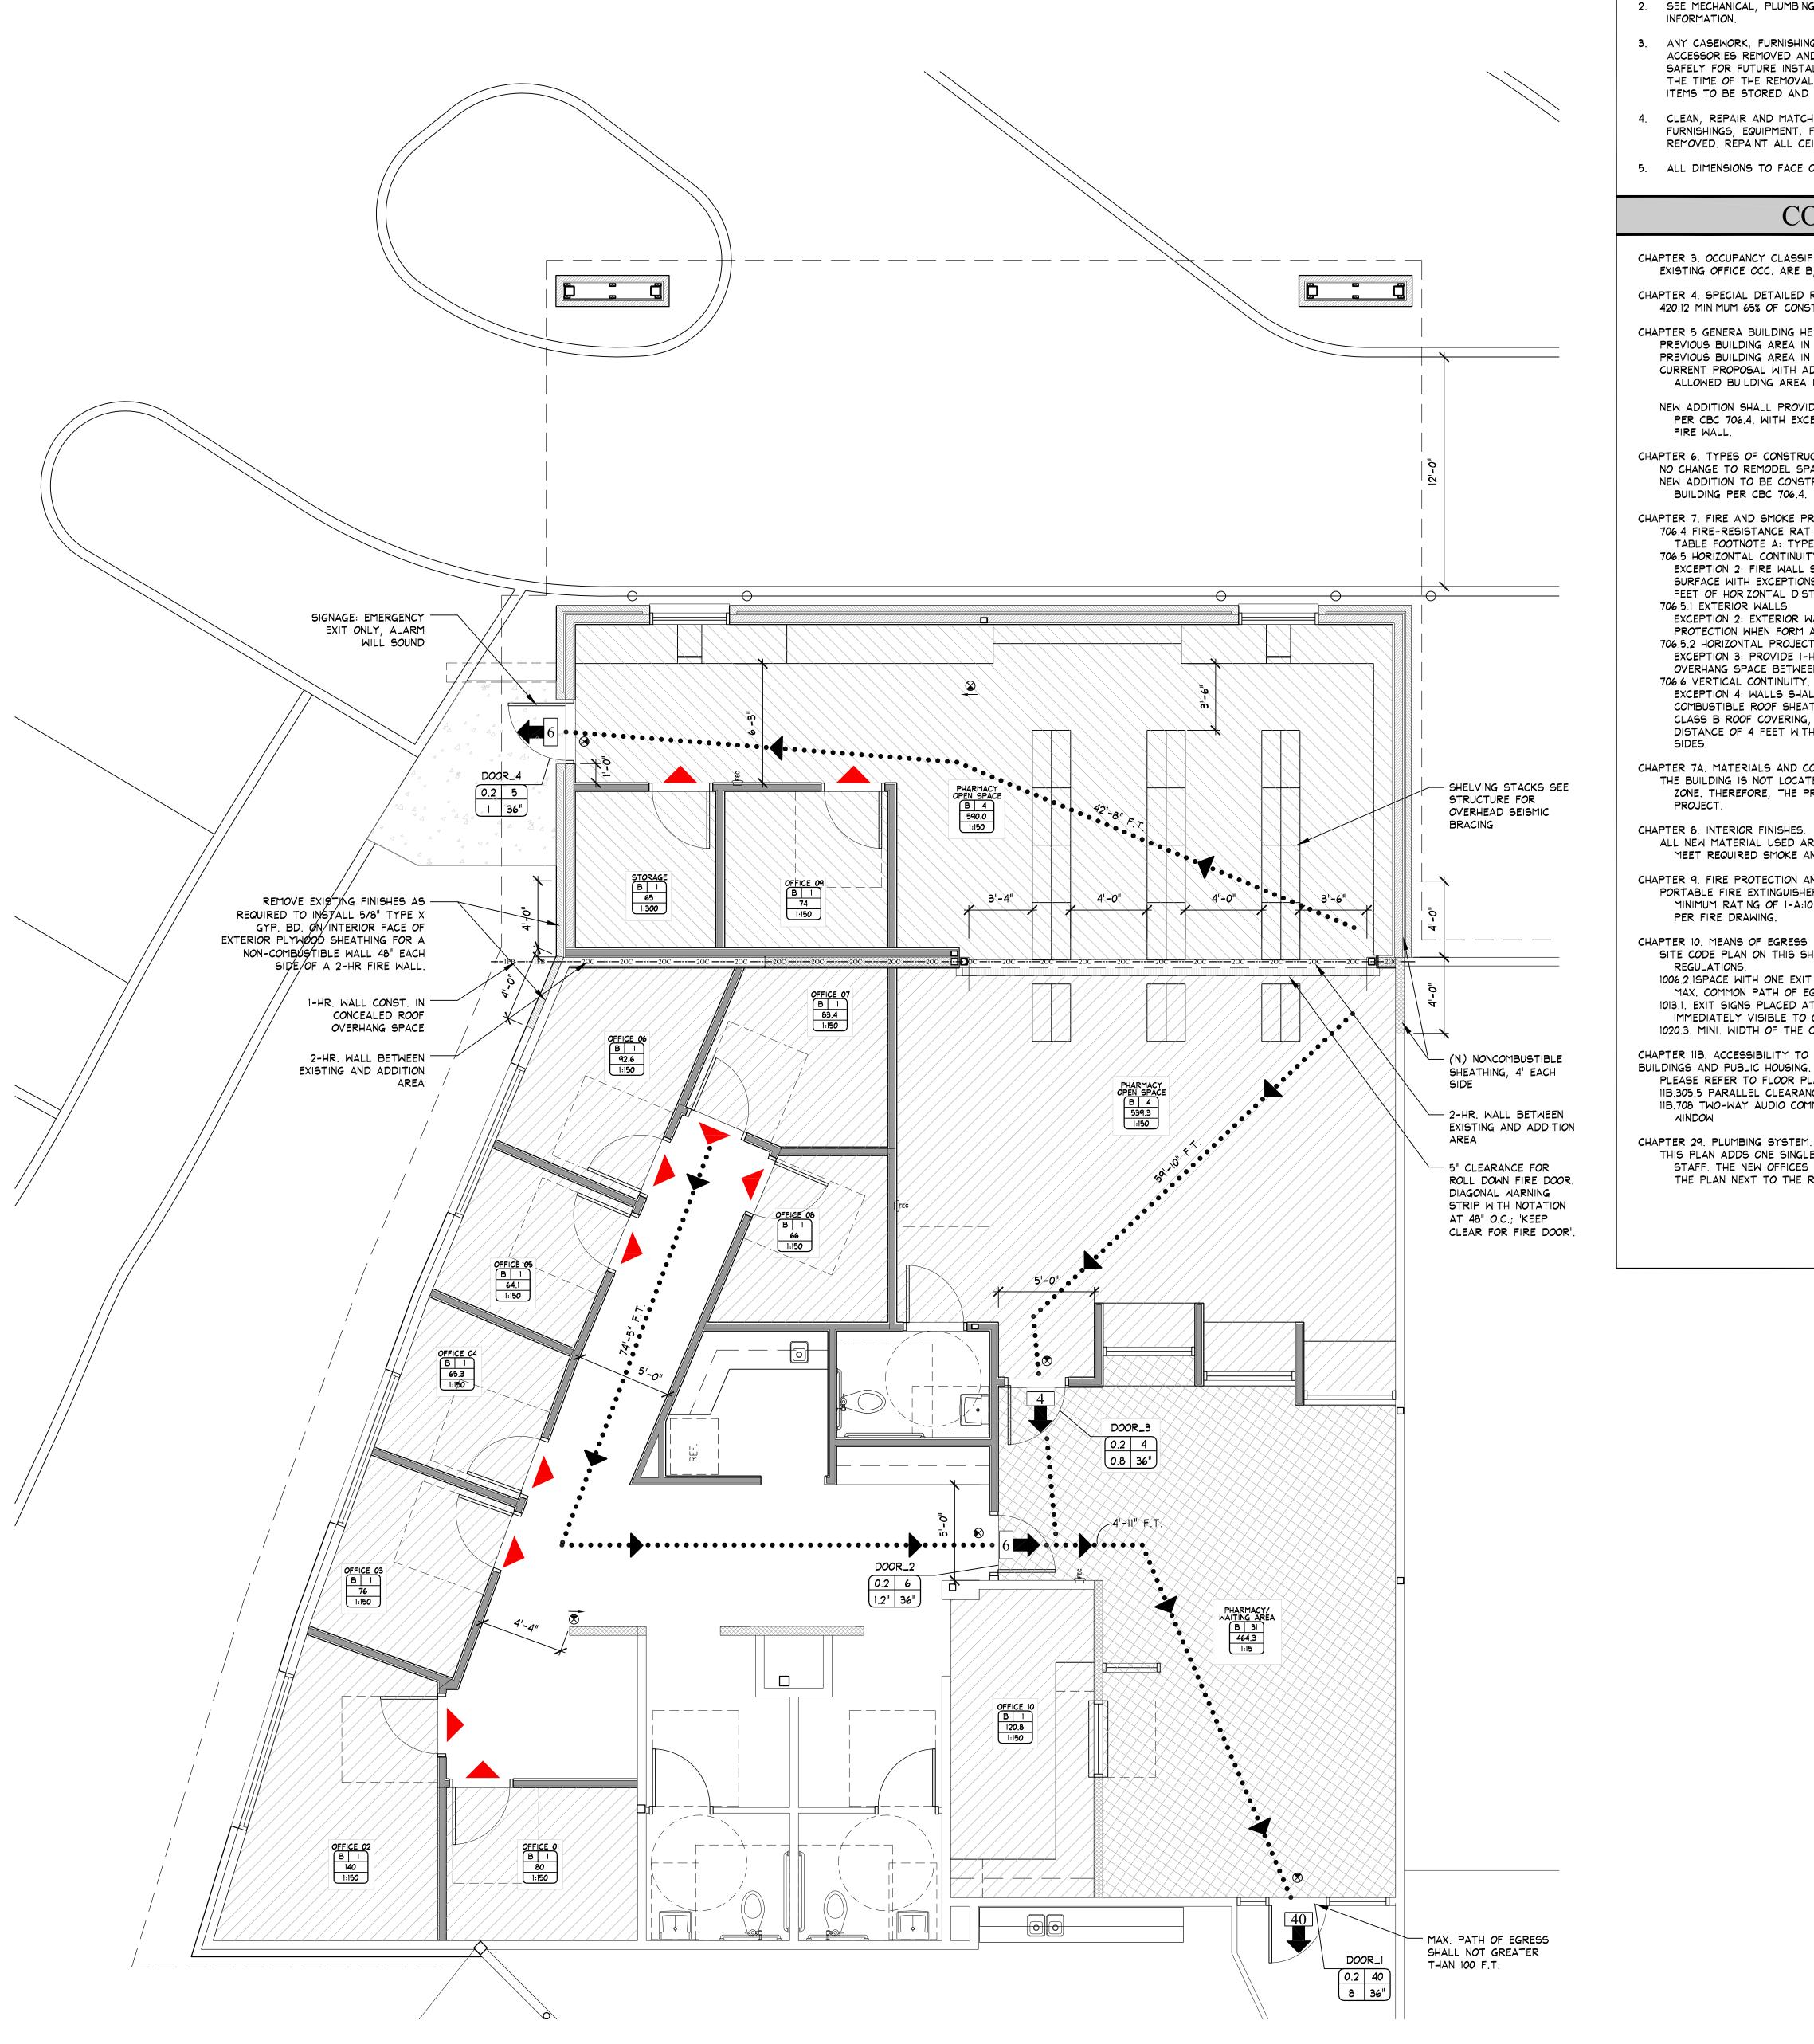

CODE PLAN

Scale: 1/4"=1'-0"

GENERAL NOTES FLOOR PLAN LEGEND

GENERAL CONTRACTOR SHALL VERIFY ALL EXISTING CONDITIONS PRIOR TO THE COMMENCEMENT OF WORK.

2. SEE MECHANICAL, PLUMBING, ELECTRICAL AND FIRE ALARM DRAWINGS FOR ADDITIONAL INFORMATION.

3. ANY CASEWORK, FURNISHING, DOORS, EQUIPMENT, FIXTURES, DEVICES, FLOOR AND ACCESSORIES REMOVED AND NOT USED IN THE PROJECT SHALL BE CLEANED, STORED SAFELY FOR FUTURE INSTALLATION, ACCOUNTED FOR, OR RETURNED TO THE OWNER AT THE TIME OF THE REMOVAL OR AT THE END OF THE PROJECT. VERIFY WITH THE OWNER ITEMS TO BE STORED AND DISCARDED.

CLEAN. REPAIR AND MATCH FINISH AT (E) WALLS, FLOORS AND CEILINGS WHERE FURNISHINGS, EQUIPMENT, FIXTURES TEMPORARY WALLS AND DEVICES HAVE BEEN REMOVED. REPAINT ALL CEILING AND WALLS TO MATCH EXISTING.

5. ALL DIMENSIONS TO FACE OF STUD UNLESS NOTED OTHERWISE

## CODE ANALYSIS

CHAPTER 3. OCCUPANCY CLASSIFICATION AND USE EXISTING OFFICE OCC. ARE B, RE-PURPOSING TO OFFICE AND PHARMACY WHICH ARE OCC. B

CHAPTER 4. SPECIAL DETAILED REQUIREMENTS BASED ON OCCUPANCY AND USE. 420,12 MINIMUM 65% OF CONSTRUCTION WASTE TO BE RECYCLED.

CHAPTER 5 GENERA BUILDING HEIGHTS AND AREAS. PREVIOUS BUILDING AREA IN YEAR 2000, IS 36,746 SQFT. PREVIOUS BUILDING AREA IN YEAR 2007, IS 47,490 SQFT. CURRENT PROPOSAL WITH ADDITION IS 48,281 SQFT, ALLOWED BUILDING AREA IS 43,750 SQFT, PER CBC 506.2

OVERHANG SPACE BETWEEN NEW ADDITION AND EXISTING.

NEW ADDITION SHALL PROVIDE 3-HR FIRE WALL BETWEEN EXISTING BUILDING AND ADDITION PER CBC 706.4. WITH EXCEPTION FOR BUILDING TYPE V-B, IT PERMITTED TO HAVE 2-HR. FIRE WALL.

CHAPTER 6. TYPES OF CONSTRUCTION.

NO CHANGE TO REMODEL SPACE IN EXISTING BUILDING SPACE, TYPE V, N.R. NEW ADDITION TO BE CONSTRUCTION TYPE V-B, WITH 2-HR. FIRE-RATED WALL TO EXISTING BUILDING PER CBC 706.4.

CHAPTER 7. FIRE AND SMOKE PROTECTION FEATURES 706.4 FIRE-RESISTANCE RATING.

TABLE FOOTNOTE A: TYPE V CONSTRUCTION SHALL HAVE A 2-HOUR WALL RATING. 706.5 HORIZONTAL CONTINUITY.

EXCEPTION 2: FIRE WALL SHALL BE PERMITTED TO TERMINATE AT THE INTERIOR SURFACE WITH EXCEPTIONS OF PROVIDE NONCOMBUSTIBLE SHEATHING NO LESS THAN 4 FEET OF HORIZONTAL DISTANCE ON BOTH SIDES OF THE FIRE WALL. 706.5.1 EXTERIOR WALLS.

EXCEPTION 2: EXTERIOR WALL TERMINATING AT FIRE WALL, NOT REQUIRE HAVING PROTECTION WHEN FORM AN ANGEL EQUAL TO OR GREATER THAN 180 DEGREES. 706.5.2 HORIZONTAL PROJECTING ELEMENTS. EXCEPTION 3: PROVIDE 1-HOUR FIRE-RESISTANCE-RATED WALL IN THE CONCEALED ROOF

706.6 VERTICAL CONTINUITY. EXCEPTION 4: WALLS SHALL BE PERMITTED TO TERMINATE AT THE UNDERSIDE OF COMBUSTIBLE ROOF SHEATHING. NO OPENING WITHIN 4 FEET OF THE FIRE WALL, MINIMUM CLASS B ROOF COVERING, AND FIRE-RETARDANT-TREATED ROOF SHEATHING FOR A DISTANCE OF 4 FEET WITH TYPE X GYP BOARD BENEATH THE ROOF SHEATHING ON BOTH

CHAPTER 7A. MATERIALS AND CONSTRUCTION METHODS FOR EXTERIOR WILDFIRE EXPOSURE. THE BUILDING IS NOT LOCATED IN AN AREA CONSIDERED TO BE A FIRE HAZARD SEVERITY ZONE. THEREFORE, THE PROVISIONS OF THIS SECTION ARE NOT APPLICABLE TO THIS

CHAPTER 8. INTERIOR FINISHES.

ALL NEW MATERIAL USED ARE TO MATCH EXISTING FINISHES OF THE PHARMACY AND TO MEET REQUIRED SMOKE AND FIRE SPREAD REQUIREMENT.

CHAPTER 9. FIRE PROTECTION AND LIFE SAFETY SYSTEM. PORTABLE FIRE EXTINGUISHERS TO BE PLACED IN THE RENOVATION AREA AND MEET MINIMUM RATING OF 1-A:10-B:C, PER CBC 906.1. LOCATION OF THE FIRE EXTINGUISHERS PER FIRE DRAWING.

CHAPTER 10. MEANS OF EGRESS

SITE CODE PLAN ON THIS SHEET DEMONSTRATED COMPLIANCE WITH CHAPTER 10 REGULATIONS.

1006.2.1SPACE WITH ONE EXIT OR EXIT ACCESS DOORWAY WITH SPRINKLER SYSTEM, MAX. COMMON PATH OF EGRESS SHALL NOT GREATER THAN 100'.

1013.1. EXIT SIGNS PLACED AT LOCATION WHERE EXIT OR PATH OF EGRESS TRAVEL IS NOT IMMEDIATELY VISIBLE TO OCCUPANTS. 1020.3. MINI. WIDTH OF THE CORRIDOR IS 44".

CHAPTER 11B. ACCESSIBILITY TO PUBLIC BUILDINGS, PUBLIC ACCOMMODATIONS, COMMERCIAL BUILDINGS AND PUBLIC HOUSING. PLEASE REFER TO FLOOR PLAN PER SHEET A3,2 AND TYPICAL DETAIL. 11B.305.5 PARALLEL CLEARANCE IS PROVIDED TO THE COUNTER SPACE.


11B.708 TWO-WAY AUDIO COMMUNICATION SYSTEM ARE PROVIDED IN THE DRIVE-THRU


THIS PLAN ADDS ONE SINGLE OCCUPANCY TOILET FOR THE CONVENIENCE OF PHARMACY STAFF. THE NEW OFFICES STILL HAVE ACCESS TO EXISTING TOILET AT THE SOUTH OF THE PLAN NEXT TO THE RECEPTION.

• • • • • • • • • • • • ACCESSIBLE EGRESS PATH OF TRAVEL COMMON PATH DISTANCE AS INDICATED



(MAX 100'-0" / CBC TABLE 1006.2.1) OFFICE / PHARMACY OPEN SPACE

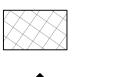

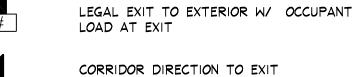


WAITING AREA

ILLUMINATED EXIT SIGN WITH DIRECTIONAL ARROW AS APPLICABLE. SEE

SEMI-RECESSED FIRE EXTINGUISHER CABINET, LARSEN'S MFR. CO., ARCH'L SERIES; W/ MODEL B500/B500T 2A;10B:C 5 LB. SEE SPEC SECTION 10520.



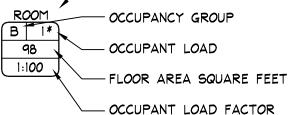



PER (CBC TABLE 1004.5)

\* OCCUPANT LOAD SIGN REQUIRED WHEN NOTED - SEC 1004.9 - REF SIGNAGE SCHEDULE. LOCATE A SIGN NEAR THE MAIN EXIT FROM THE ROOM.

# **EXITING CALCULATIONS**

\* SQUARE FOOT AREA CALCULATIONS BASED ON B-OCCUPANCY PER TABLE 1004.5, BUSINESS AREA 100 GROSS OCCUPANT LOAD FACTOR AND INCLUDES ALL OCCUPIABLE AND NON-OCCUPIABLE FLOOR SPACES

BUILDING OCCUPANT LOAD B:	SQ.FT	LOAD FACTOR	OCCUP. LOAD
OFFICES:	862.2	150	6
PHARMACY OPEN SPACE:	539.3	150	4
PHARMACY MEDICINE AREA:	590.0	150	4
WAITING AREA:	464.3	15	31
ST <i>O</i> RAGE	<b>6</b> 5	300	1
NON-OCCUPIED	1000.6	-	-
TOTAL:	3521.4		46

EXIT DOOR WIDTH:

<u>DOOR NO.1</u>

WAITING AR		PHARMACY	3.60
DOOR NO.2 DOOR NO.3	5.27 3.60	TOTAL OCC. ROUNDED	3.60 4
TOTAL OCC. ROUNDED	39.87 40	FACTOR REQUIRED	0.20 0.80
FACTOR REQUIRED	0.20 8	PROVIDED	36"
PROVIDED	36"		
DOOR NO.2 OFFICE 01	OCC. LOAD 0.53	<u>DOOR NO.4</u> PHARMACY	OCC. LOAD 3.93
OFFICE 02	0.93	OFFICE NO 9	0.49

<u>DOOR NO.3</u>

OCC. LOAD

OFFICE NO.9 0.49 OFFICE 03 0.51 STORAGE 0.22 OFFICE 04 0.44 0.43 TOTAL OCC. OFFICE 06 0.62 ROUNDED OFFICE 07 0.56 FACTOR OFFICE 08 0.44 REQUIRED OFFICE 10 0.81 PROVIDED TOTAL OCC. 5.27

ROUNDED 0.20 1.20 FACTOR REQUIRED PROVIDED

MIN NUMBER OF EXITS:

EXIT CONFIGURATION: SPACES WITH ONE EXIT SHALL NO MORE THAN 49 OCCUPANTS PER CBC 1006.2.1. MAXIMUM COMMON PATH OF EGRESS TRAVEL DISTANCE IN SPRINKLER SPACE SHALL NO MORE THAN 100 F.T.

74'-5" F.T. PATH OF EGRESS FROM OFFICES: PATH OF EGRESS FROM PHARMACY: 59'-10" F.T. PATH OF EGRESS TO EMERGENCE EXIT: 42'-8" F.T. EGRESS COMPONANTS:

NUMBER OF EXIT PROVIDED: WIDTH OF EXITS REQUIRED: WIDTH OF EXITS PROVIDED: MIN. CORRIDOR WIDTH:

BUSINESS AREAS: WIDTH OF NARROWEST CORRIDOR PROVIDED: 48"

# ACCESSIBLE FIXTURES

ACCESSIBLE STAFF UNISEX TOILET

EXTERIOR

6. ROOF CONSTRUCTION

**JOISTS** 

# **BUILDING INFORMATION**

PROJECT AREA: (LOCATED ON FIRST FLOOR) 47,490 S.F. OCCUPANCY GROUP: TYPE OF CONSTRUCTION: TYPE V-B CONSTRUCTION BASIC ALLOWABLE AREA: 43,750 SQFT ALLOWABLE INCREASES: N/A BUILDING STORIES: SPRINKLERED: BUILDING IS EQUIPPED WITH AUTOMATIC SMOKE DETECTION SYSTEM THROUGHOUT FACILITY.

NON-RATED (PER CBC TABLE 602)

FIRE-RESISTIVE REQUIREMENTS (PER CBC TABLE 601, 602): I. STRUCTURAL FRAME NON-RATED (PER CBC TABLE 601) 2. BEARING WALLS EXTERIOR NON-RATED INTERIOR NON-RATED 3. NON-BEARING WALLS AND PARTITIONS

4. NON-BEARING WALLS AND PARTITIONS NON-RATED INTERIOR 5. FLOOR CONSTRUCTION NON-RATED (PER CBC TABLE 601) INCLUDING SUPPORTING BEAMS AND

INCLUDING SUPPORTING BEAMS AND NON-RATED (PER CBC TABLE 601)

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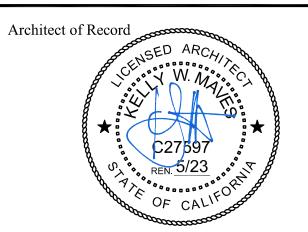
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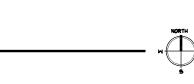
OCC. LOAD

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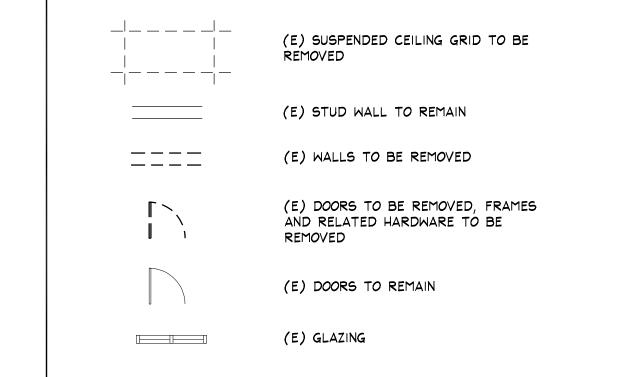




# DEMOLITION GENERAL NOTES

- . EXISTING ENTRANCE PATIO TO BE REMOVED.
- 2. EXISTING STAFF BATHROOM AND STORAGE REMAIN UNCHANGED.
- 3. FIRE SPRINKLER NOTES:
- A.BEFORE SHUTTING OFF A SECTION OF THE FIRE SERVICE SYSTEM TO MAKE SPRINKLER CONNECTIONS, PLAN THE WORK CAREFULLY, AND ASSEMBLE ALL MATERIALS TO ENABLE COMPLETION IN THE SHORTEST POSSIBLE TIME. THE REMAINDER SHALL BE KEPT IN SERVICE.
- B.WORK STARTED ON CONNECTIONS SHOULD BE COMPLETED WITHOUT INTERRUPTION, AND PROTECTION SHOULD BE RESTORED AS PROMPTLY AS POSSIBLE. DURING THE IMPAIRMENT, PROVIDE EMERGENCY HOSE LINES AND EXTINGUISHERS AND MAINTAIN EXTRA WATCH SERVICE IN THE AREAS AFFECTED.
- C.WHEN CHANGES INVOLVE SHUTTING OFF WATER FROM ANY CONSIDERABLE NUMBER OF SPRINKLERS FOR MORE THAN A FEW HOURS, TEMPORARY WATER SUPPLY CONNECTIONS SHOULD BE MADE TO SPRINKLER SYSTEM SO THAT REASONABLE PROTECTION CAN BE
- D.WHEN IT IS NECESSARY TO SHUT DOWN THE ENTIRE SYSTEM, A FIRE WATCH SHALL BE KEPT IN SITE UNTIL THE SYSTEM IS RESTORED TO SERVICE. THE SOLE DUTY OF FIRE WATCH PERSONNEL SHALL BE TO WATCH FOR THE OCCURRENCE OF FIRE. COMPLETE PIN 14, AND TO OBTAIN OSHPD FIELD FIRE MARSHALL'S APPROVAL PRIOR TO TAKING ANY SYSTEMS OFFLINE.
- E.IN ADDING TO OLD SYSTEMS OR RENOVATING THEM, PROTECTION SHOULD BE RESTORED EACH NIGHT SO FAR AS POSSIBLE NOTIFY THE LOCAL FIRE DEPARTMENT WHEN ANY OF THE CONDITIONS ABOVE ARE ANTICIPATED.
- 4. THESE PLANS MAY NOT SHOW ALL ITEMS TO BE DEMOLISHED OR REMOVED. SEE MECHANICAL, PLUMBING AND ELECTRICAL DEMOLITION DRAWINGS FOR ADDITIONAL INFORMATION.
- 5. ALL EQUIPMENT, CASEWORK, FIXTURES, FURNITURE, AND DEVICES REMOVED, THAT ARE NOT USED IN THE PROJECT, SHALL BE CLEANED AND STORED OR RETURNED TO THE OWNER AT THE TIME OF REMOVAL AND/OR AT THE END OF THE PROJECT. VERIFY WITH OWNER ITEMS TO BE STORED, RETURNED, OR DISCARDED (AT THE OWNER'S SOLE DISCRETION). COORDINATE AND SCHEDULE WITH OWNER FOR REMOVAL AND STORAGE REQUIREMENTS.
- 6. CONTRACTOR TO COORDINATE REMOVAL OF ALL ITEMS SHOWN AS REMOVED OR DEMOLISHED IN CONSTRUCTION DOCUMENTS WITH OWNER PRIOR TO COMMENCEMENT OF WORK, EXISTING ITEMS THAT ARE TO BE REMOVED AND REINSTALLED ARE TO BE STORED AND PROTECTED FROM DAMAGE DURING TRANSITION FROM REMOVAL TO INSTALLATION.
- 7. CONTRACTOR TO COORDINATE REMOVAL OF ALL VENDOR EQUIPMENT WITH VENDOR AND OWNER. CONTRACTOR TO REMOVE ALL ANCHORAGE, ELECTRICAL, MECHANICAL AND PLUMBING ITEMS ASSOCIATED WITH VENDOR REMOVED EQUIPMENT REMAINING AFTER VENDORS REMOVAL OF EQUIPMENT.
- B. ABANDON OR CAP ALL UTILITIES NOT SCHEDULED FOR REUSE. SEE MECHANICAL, PLUMBING, AND ELECTRICAL SHEETS.
- 9. THE MEANS OF EGRESS SHALL NOT BE ALTERED OR COMPROMISED UNTIL APPROVAL FROM LOCAL FIRE MARSHALL HAS BEEN OBTAINED IN WRITING. THIS INCLUDES THE CONSTRUCTION AND LOCATION OF ALL TEMPORARY CONSTRUCTION BARRIERS. NO FIRE PROTECTION SYSTEMS SHALL BE TAKEN OUT OF SERVICE WITHOUT PRIOR APPROVAL AND KNOWLEDGE FROM LOCAL FIRE MARSHALL.
- 10. EXISTING MEANS OF EGRESS NEED NOT BE MAINTAINED WHERE APPROVED TEMPORARY MEANS OF EGRESS SYSTEMS AND FACILITIES ARE PROVIDED. REQUIRED MEANS OF EGRESS SHALL BE MAINTAINED AT ALL TIMES DURING THE DEMOLITION AND CONSTRUCTION OF THE REMODEL, ALTERATION, OR ADDITION TO ANY BUILDING.
- . WHEN CONSTRUCTION BARRIERS AFFECT ANY EXIT COMPONENT, PRE-APPROVAL SHALL BE OBTAINED FROM THE LOCAL FIRE JURISDICTION AND OSHPD PRIOR TO ANY DEMOLITION OR RECONSTRUCTION.

# DEMOLITION FLOOR PLAN LEGEND



(E) ENTRY CANOPY TO BE

REMOVED

(E) DOORS TO BE REMOVED

(E) HANDRAIL TO BE REMOVED

(E) PARAPET TO BE

(E) PATIO SLAB TO BE REMOVED

(E) WALL FINISH TO BE

REMOVED TO PLYWOOD

REMOVED



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Revisions

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DATE

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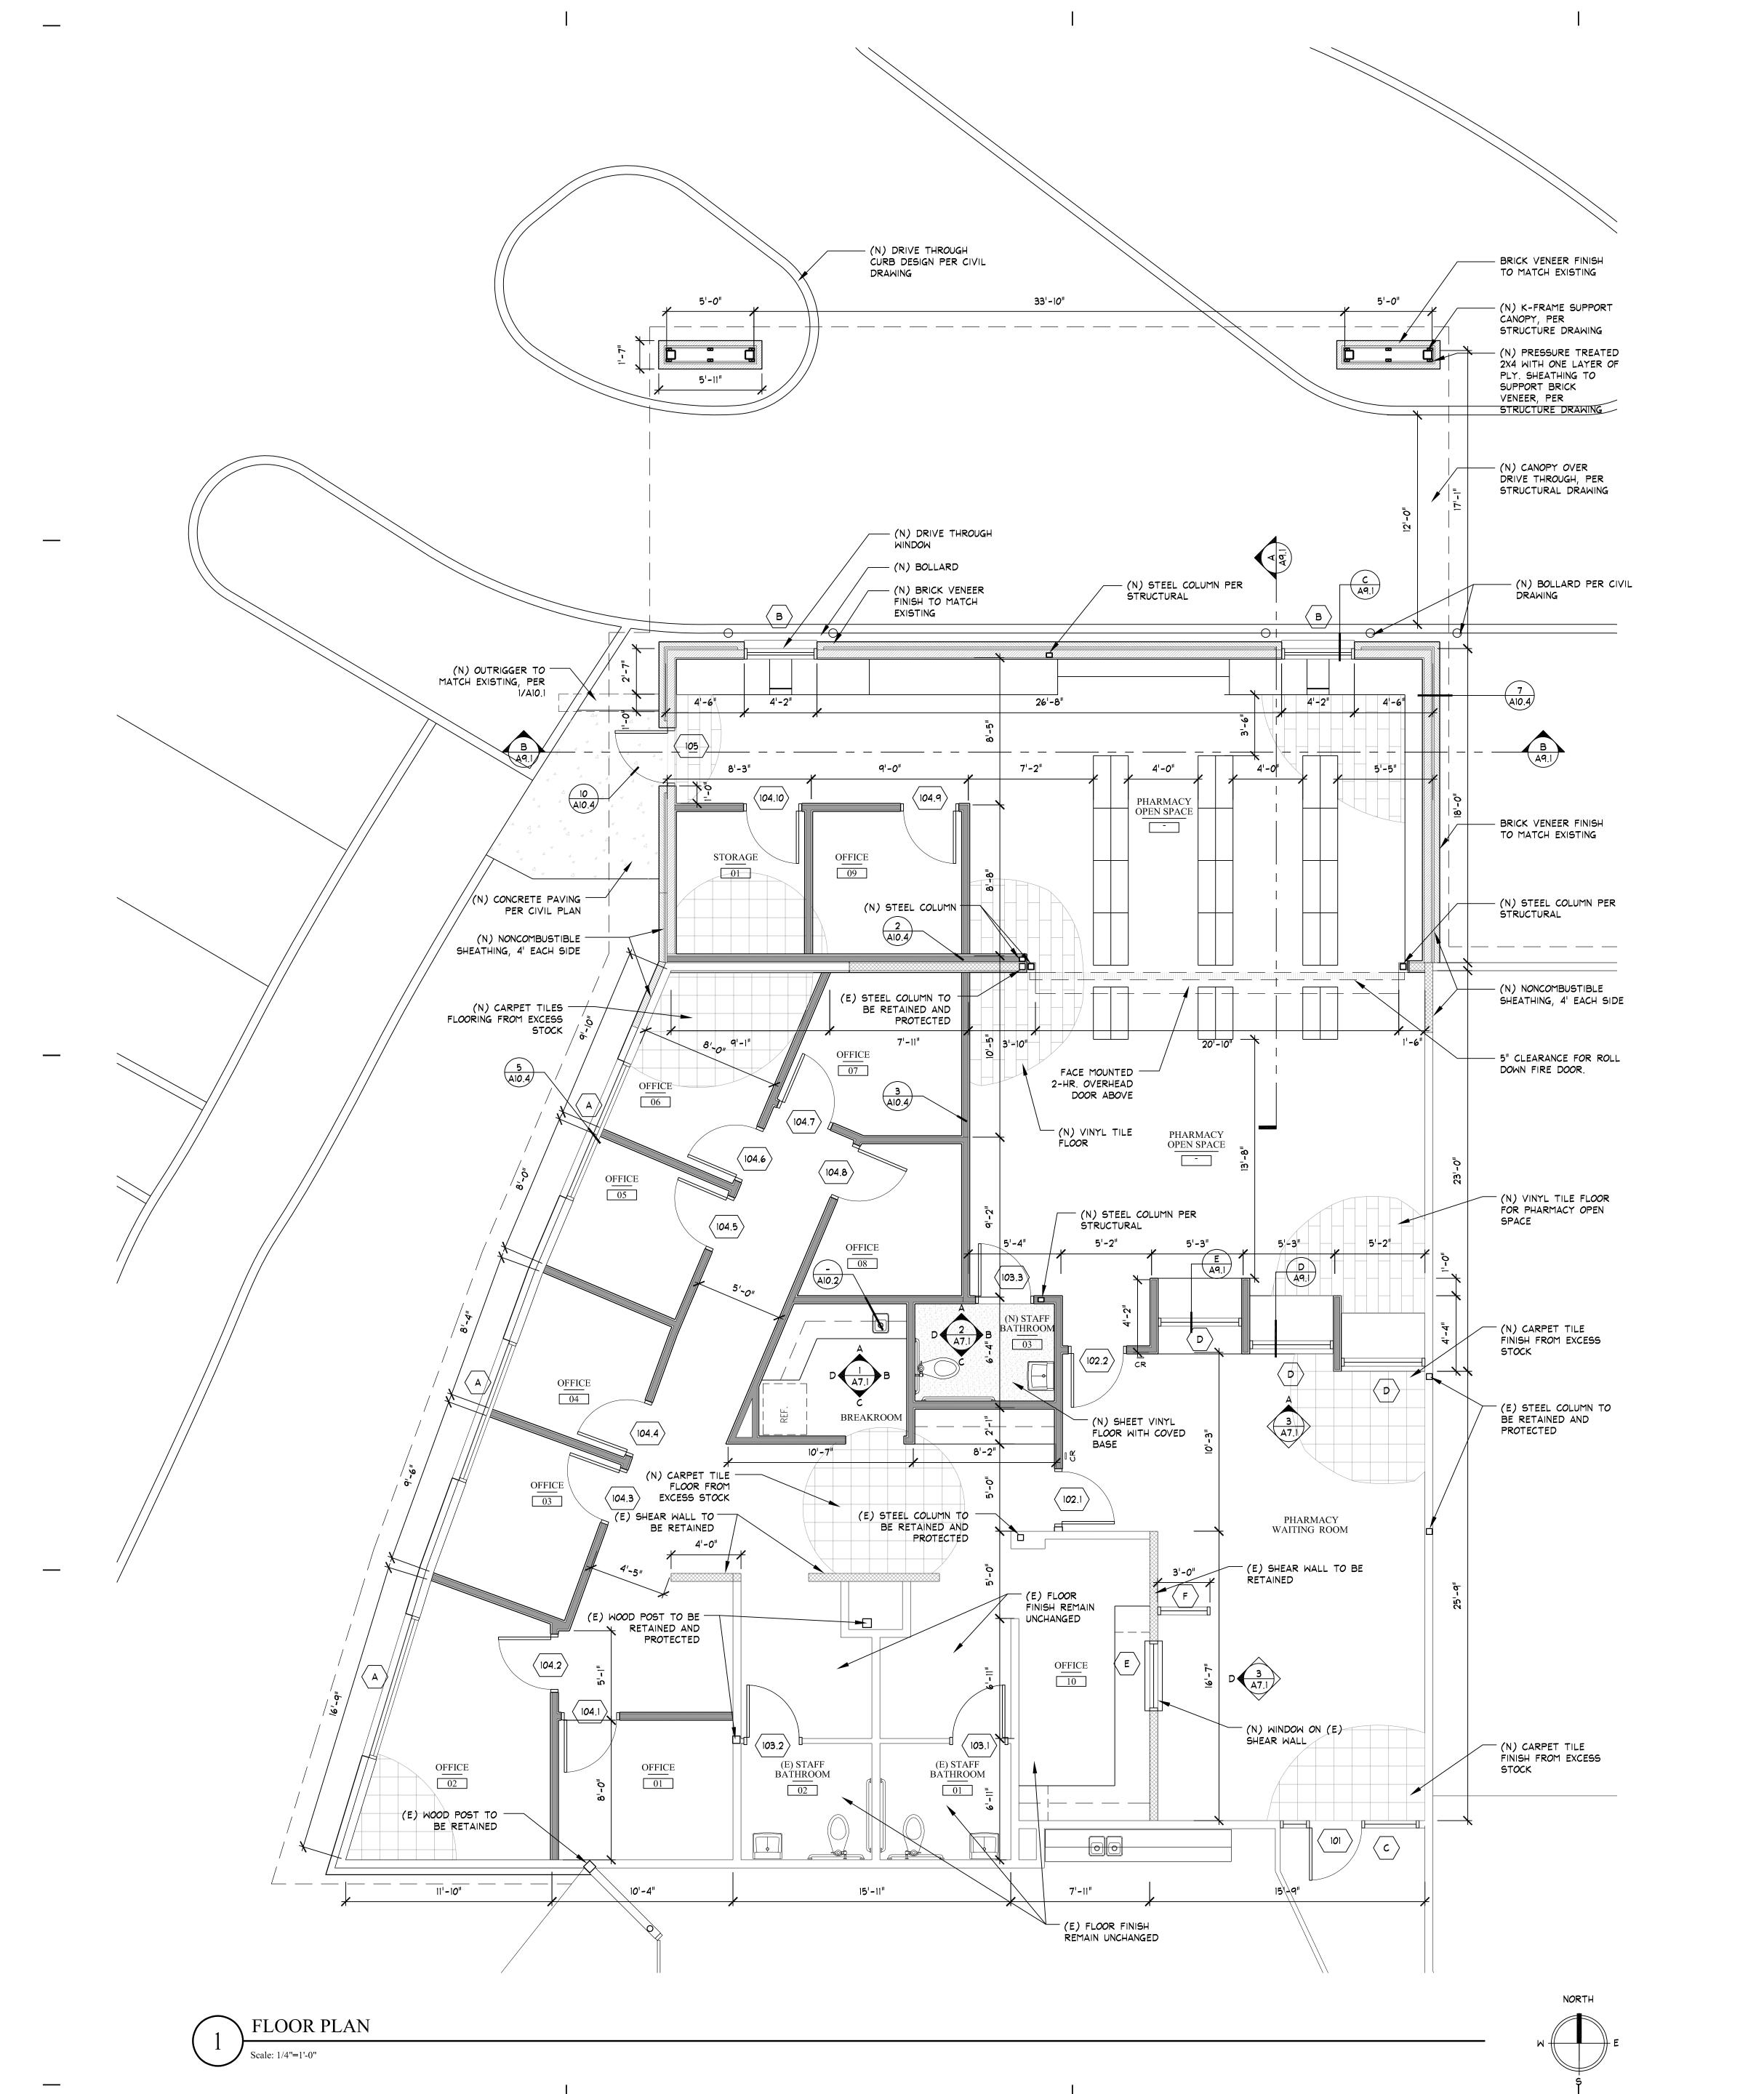
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**Demolition Plan** 

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Sheet Name

A3.1



# GENERAL NOTES

- GENERAL CONTRACTOR SHALL VERIFY ALL EXISTING CONDITIONS PRIOR TO THE COMMENCEMENT OF WORK.
- SEE MECHANICAL, PLUMBING, ELECTRICAL AND FIRE ALARM DRAWINGS FOR ADDITIONAL INFORMATION.
- 3. ANY CASEWORK, FURNISHING, DOORS, EQUIPMENT, FIXTURES, DEVICES, FLOOR AND ACCESSORIES REMOVED AND NOT USED IN THE PROJECT SHALL BE CLEANED, STORED SAFELY FOR FUTURE INSTALLATION, ACCOUNTED FOR, OR RETURNED TO THE OWNER AT THE TIME OF THE REMOVAL OR AT THE END OF THE PROJECT. VERIFY WITH THE OWNER ITEMS TO BE STORED AND DISCARDED.
- 4. CLEAN, REPAIR AND MATCH FINISH AT (E) WALLS, FLOORS AND CEILINGS WHERE FURNISHINGS, EQUIPMENT, FIXTURES TEMPORARY WALLS AND DEVICES HAVE BEEN REMOVED. REPAINT ALL GYPSUM CEILING AND WALLS TO MATCH EXISTING.
- 5. PROVIDE 2 1/2" GROMMETS AT ALL WORKSTATIONS AS SHOWN.
- 6. ALL DIMENSIONS TO FACE OF STUD UNLESS NOTED OTHERWISE

# FLOOR PLAN LEGEND








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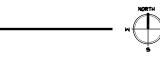


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Floor Plan

Sheet Number


A3.2

# ROOF NOTES

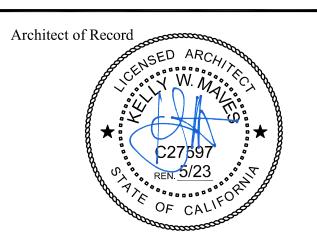- CONTRACTOR RESPONSIBLE TO FIELD VERIFY AND COORDINATE ALL DIMENSIONS OF ROOF STRUCTURE, ROOF PENETRATIONS, EAVES, GUTTERS, ETC.
- 2. INSTALL TEMPORARY ROOF COVERINGS DURING CONSTRUCTION FOR ANY EXPOSED ROOF AREAS.
- 3. THESE PLANS MAY NOT SHOW ALL ITEMS TO BE DEMOLISHED, INSTALLED OR THEIR CORRECT LOCATIONS. SEE STRUCTURAL, MECHANICAL, PLUMBING, AND ELECTRICAL DRAWINGS FOR ADDITIONAL INFORMATION.
- 4. INSTALL BATT INSULATION AT TOP CHORD OF ROOF TRUSSES. ATTIC SPACE SHALL NOT BE ENCLOSED AND THEREFORE NO VENTILATION CALCULATION REQUIRED PER CBC 1202.3.1
- 5. REPLACE UNDERLAYMENT AS REQUIRED. NEW UNDERLAYMENT TO MATCH EXISTING AND TO BE INSTALLED PER MANUFACTURERS RECOMMENDATIONS.
- 6. CONTRACTOR TO INSPECT EXISTING GUTTERS AND DOWNSPOUTS. GUTTERS THAT NEED TO BE REPLACED SHALL BE REPLACED IN KIND AND INSTALLED PER MANUFACTURERS RECOMMENDATIONS.
- EXISTING FLASHING TO BE REUSED. REPLACE IF FLASHING CONTAINS HOLES, BENT OR
  OTHERWISE DAMAGED. CONTRACTOR TO INSPECT ALL FLASHING AND COUNTER FLASHING AND
  REPLACED AS NEEDED. ALL EXISTING FLASHING IN NEED OF PAINT SHALL BE PAINTED.
- 3. PATCH AND REPAIR ALL HOLES IN EXISTING PLYWOOD SUBSTRATE LEFT FROM REMOVAL OF TOE BOARDS, ROOF JACKS, ETC.
- 4. INSTALLATION SHALL BE PER MFR. SPECIFICATIONS & TO MATCH EXISTING.

# ROOF PLAN LEGEND

DEMO (E) ROOF TILE AND ROOFING MEMBRANE. INSPECT AND REPLACE RIGID INSULATION AND PLYWOOD UNDERLAYMENT AS NECESSARY. PROTECT IN PLACE

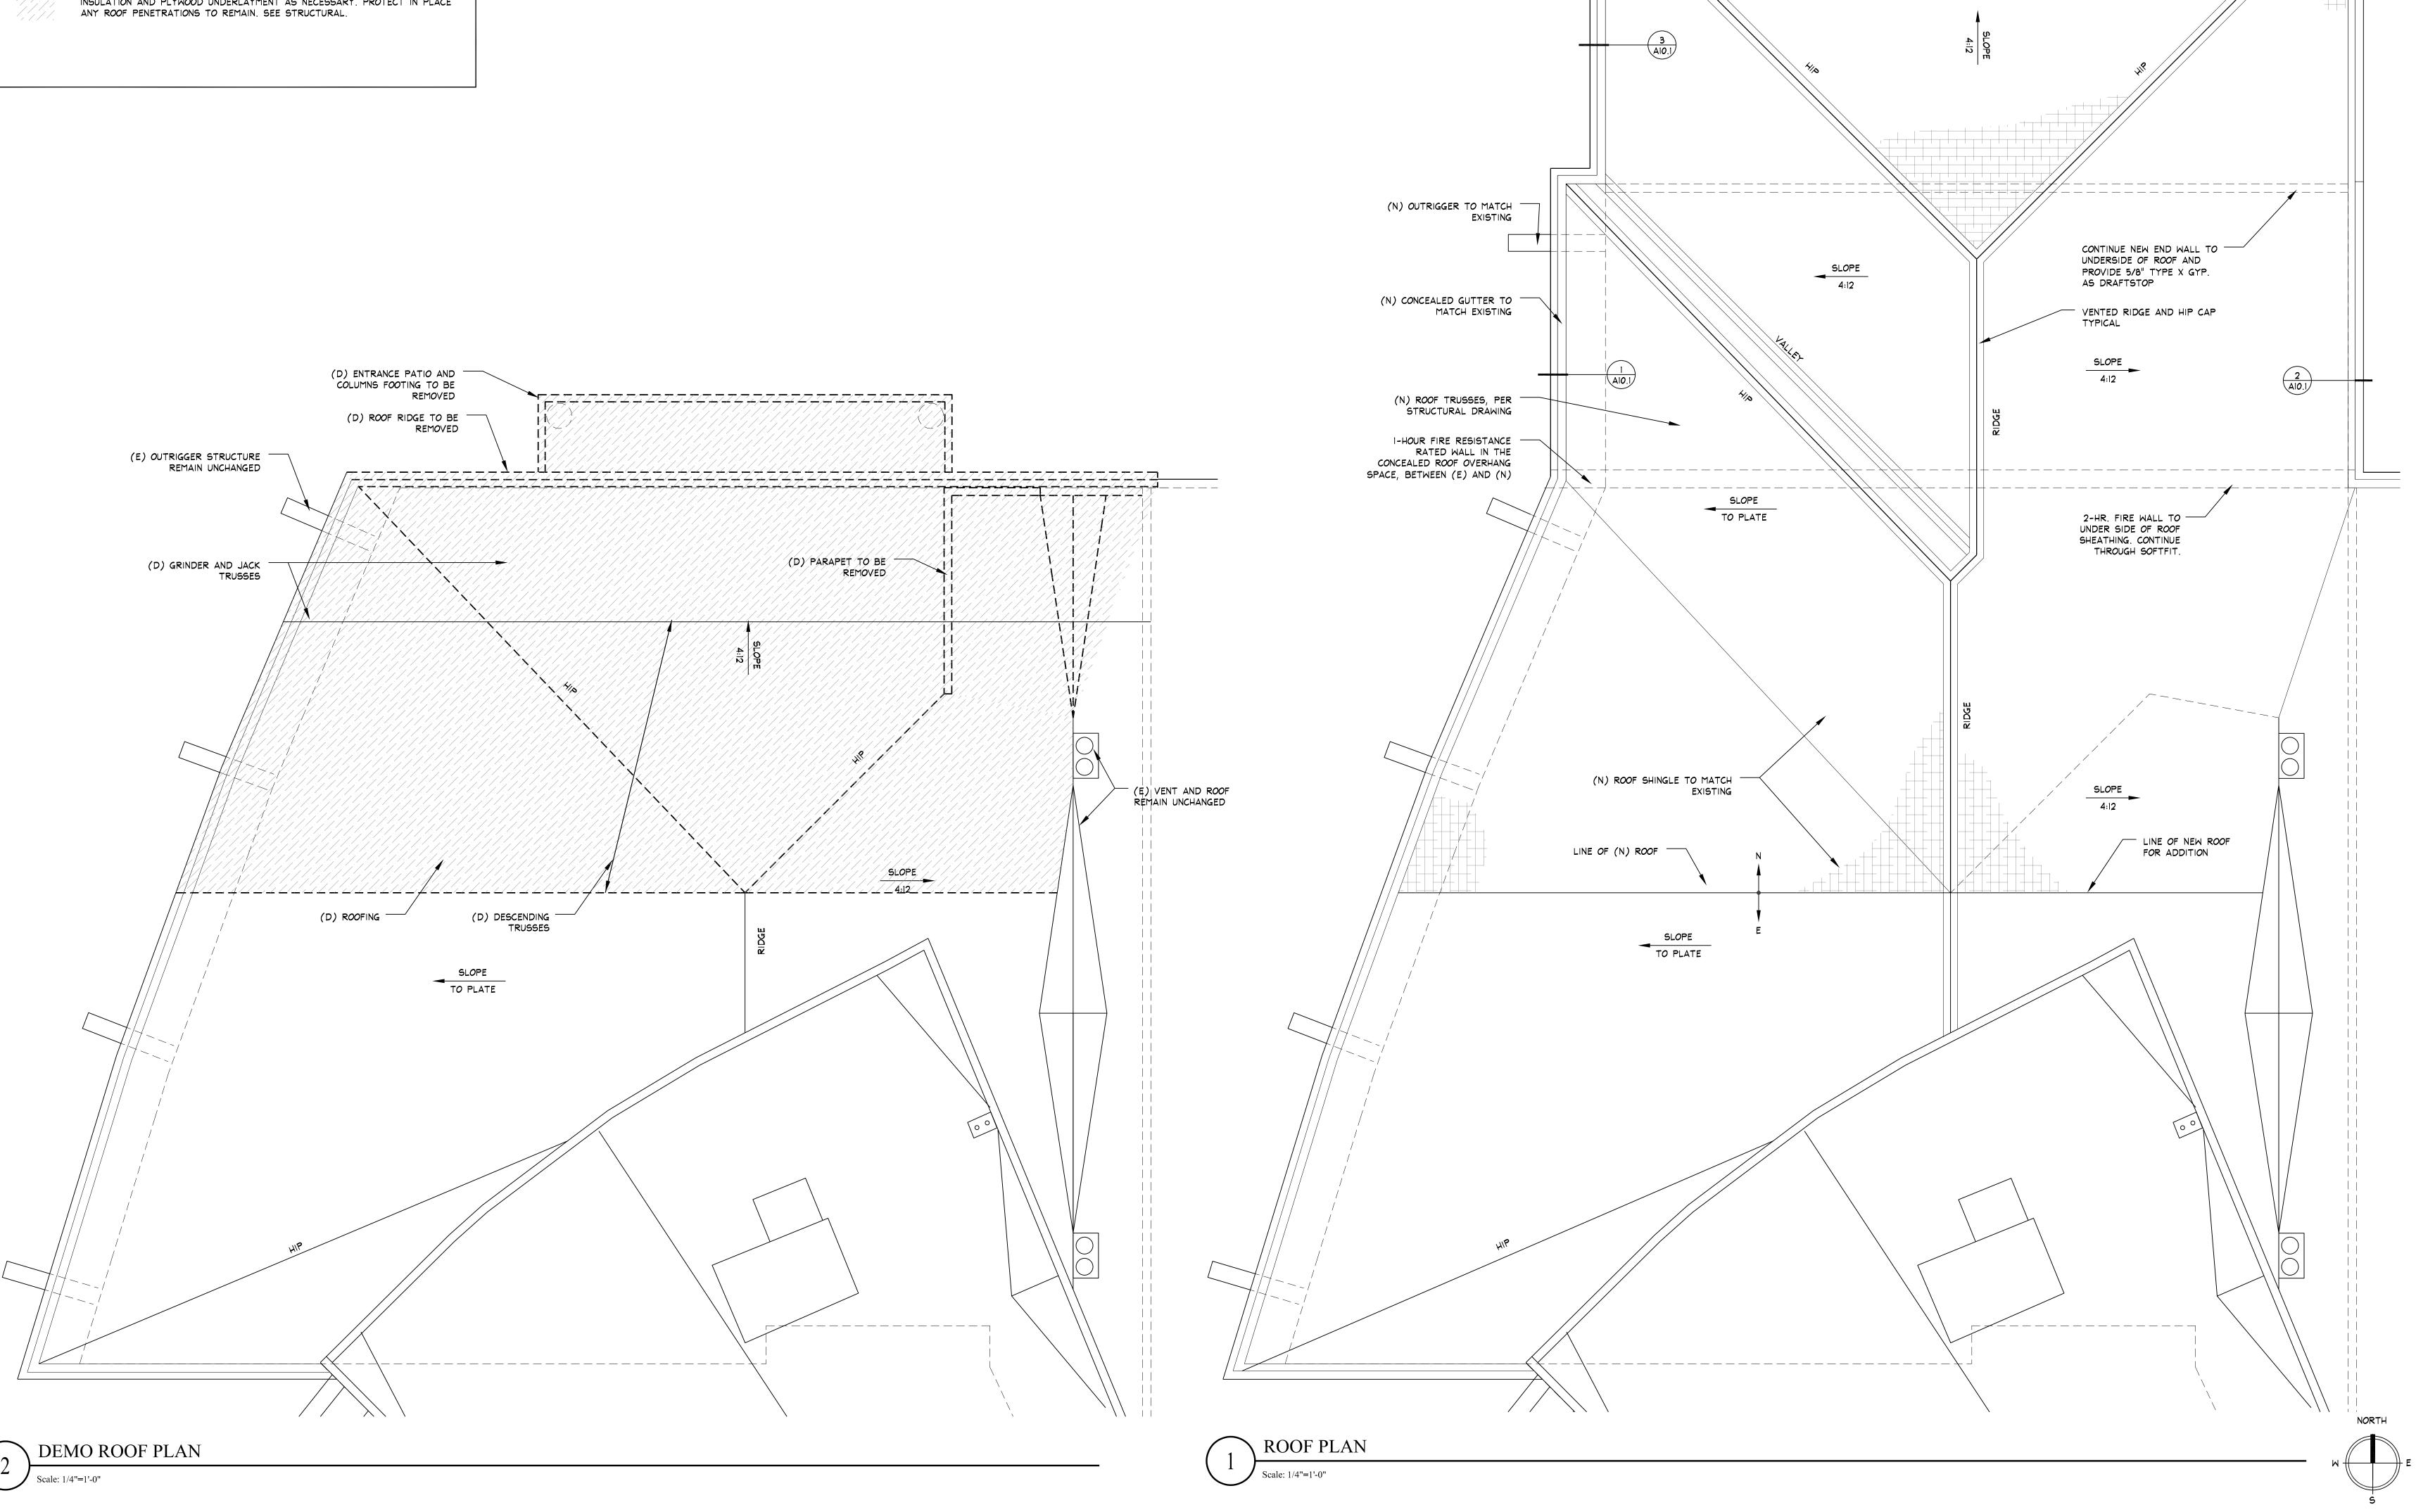



REAL HEALTH INC.

FEATHER RIVER
TRIBAL HEALTH

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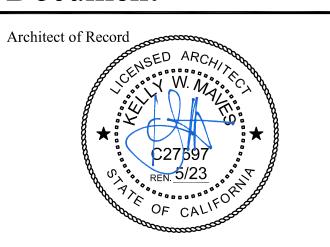
(N) CONCEALED GUTTER TO

MATCH EXISTING

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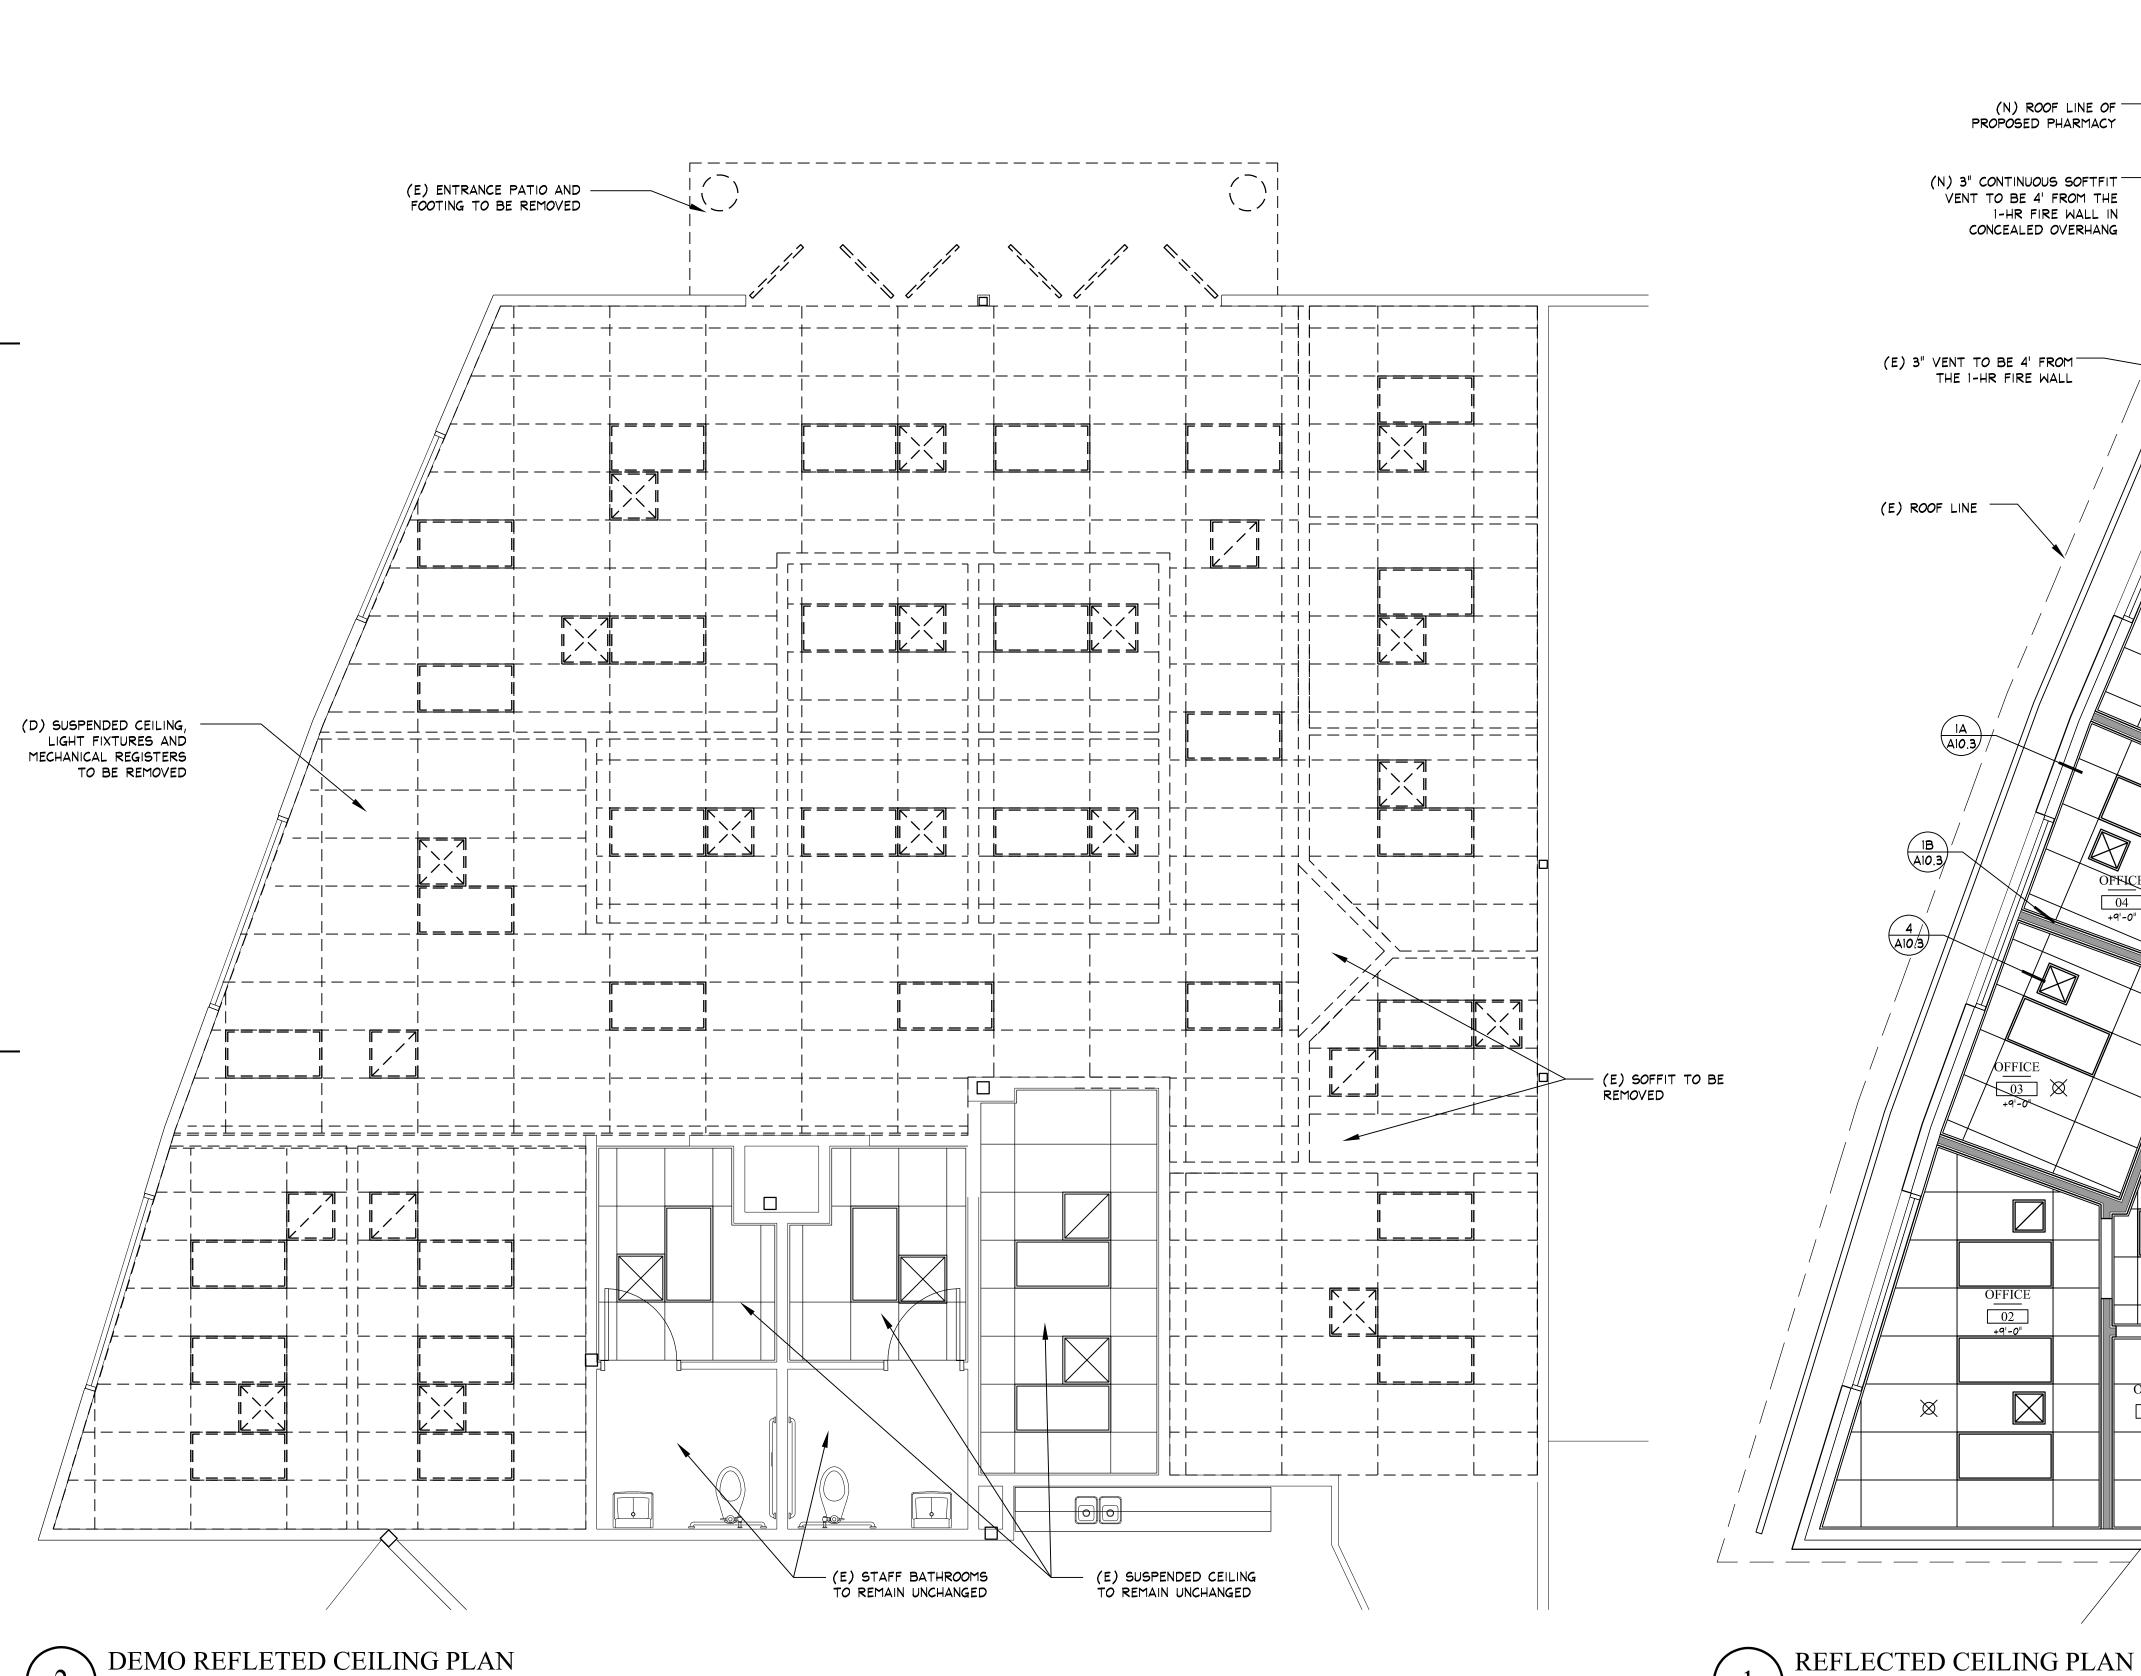
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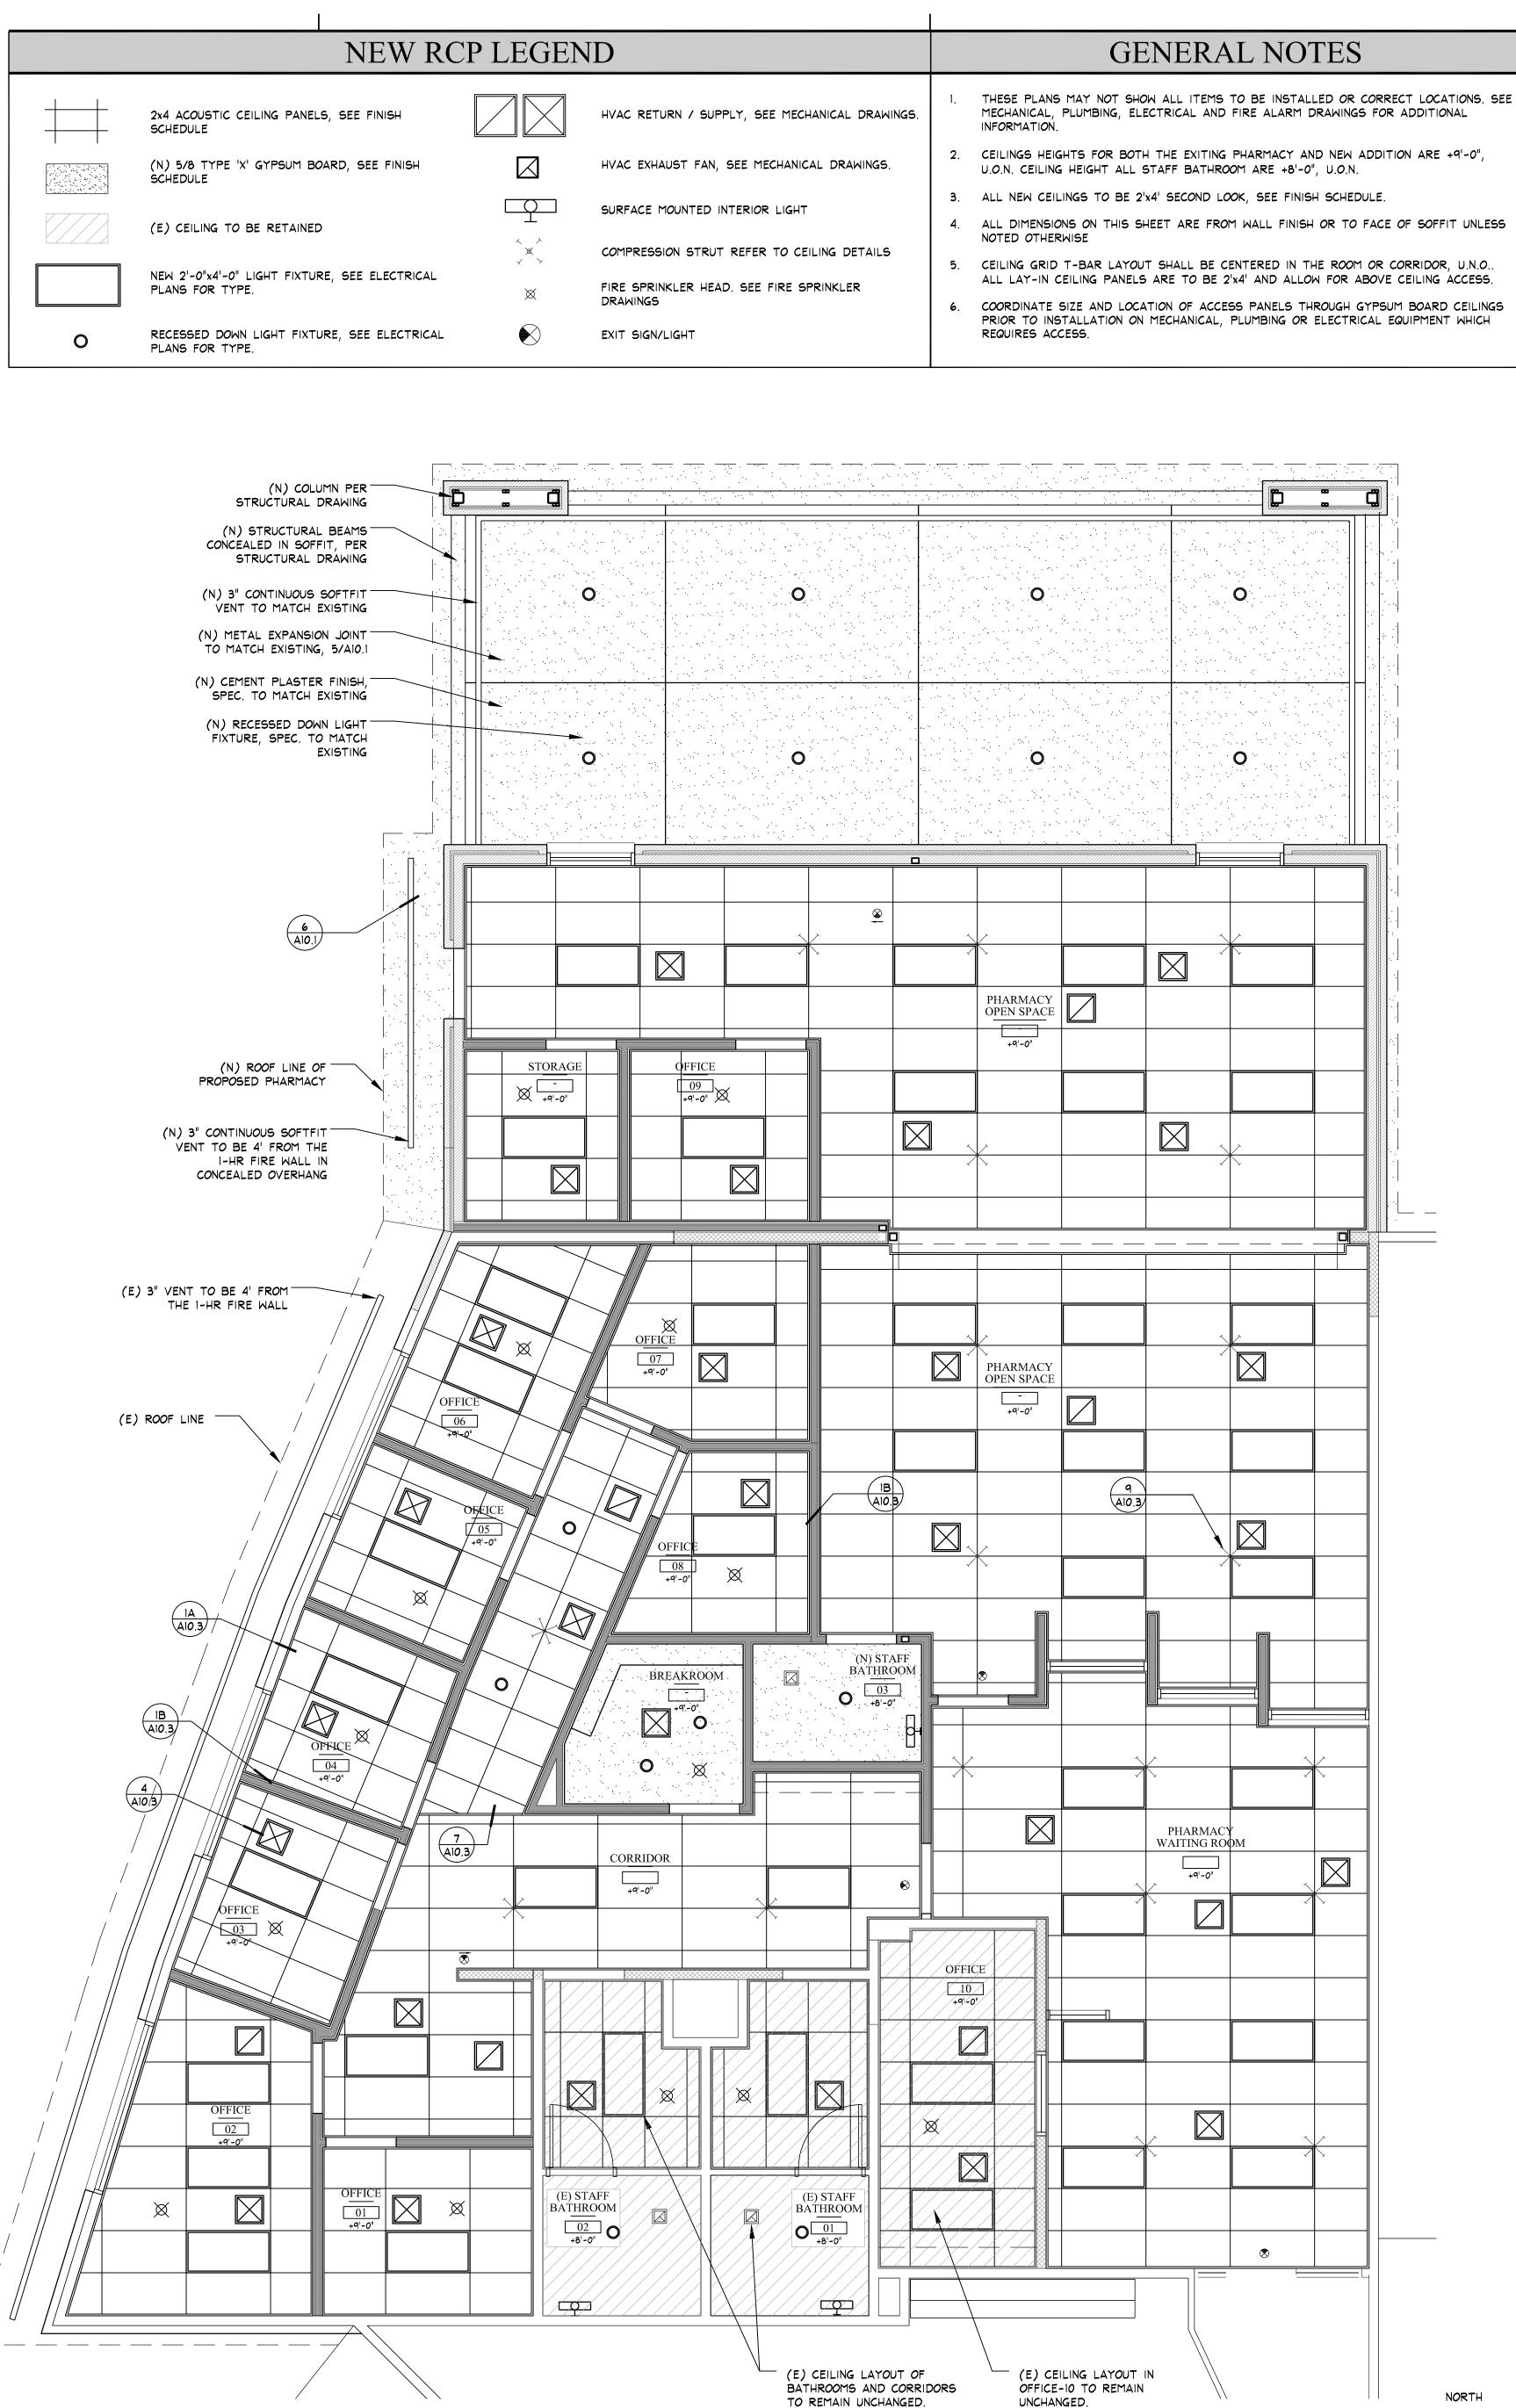
ROOF PLAN

Sheet Number

A3.3







Scale: 1/4"=1'-0"

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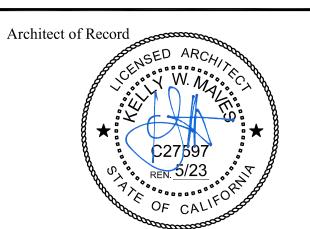
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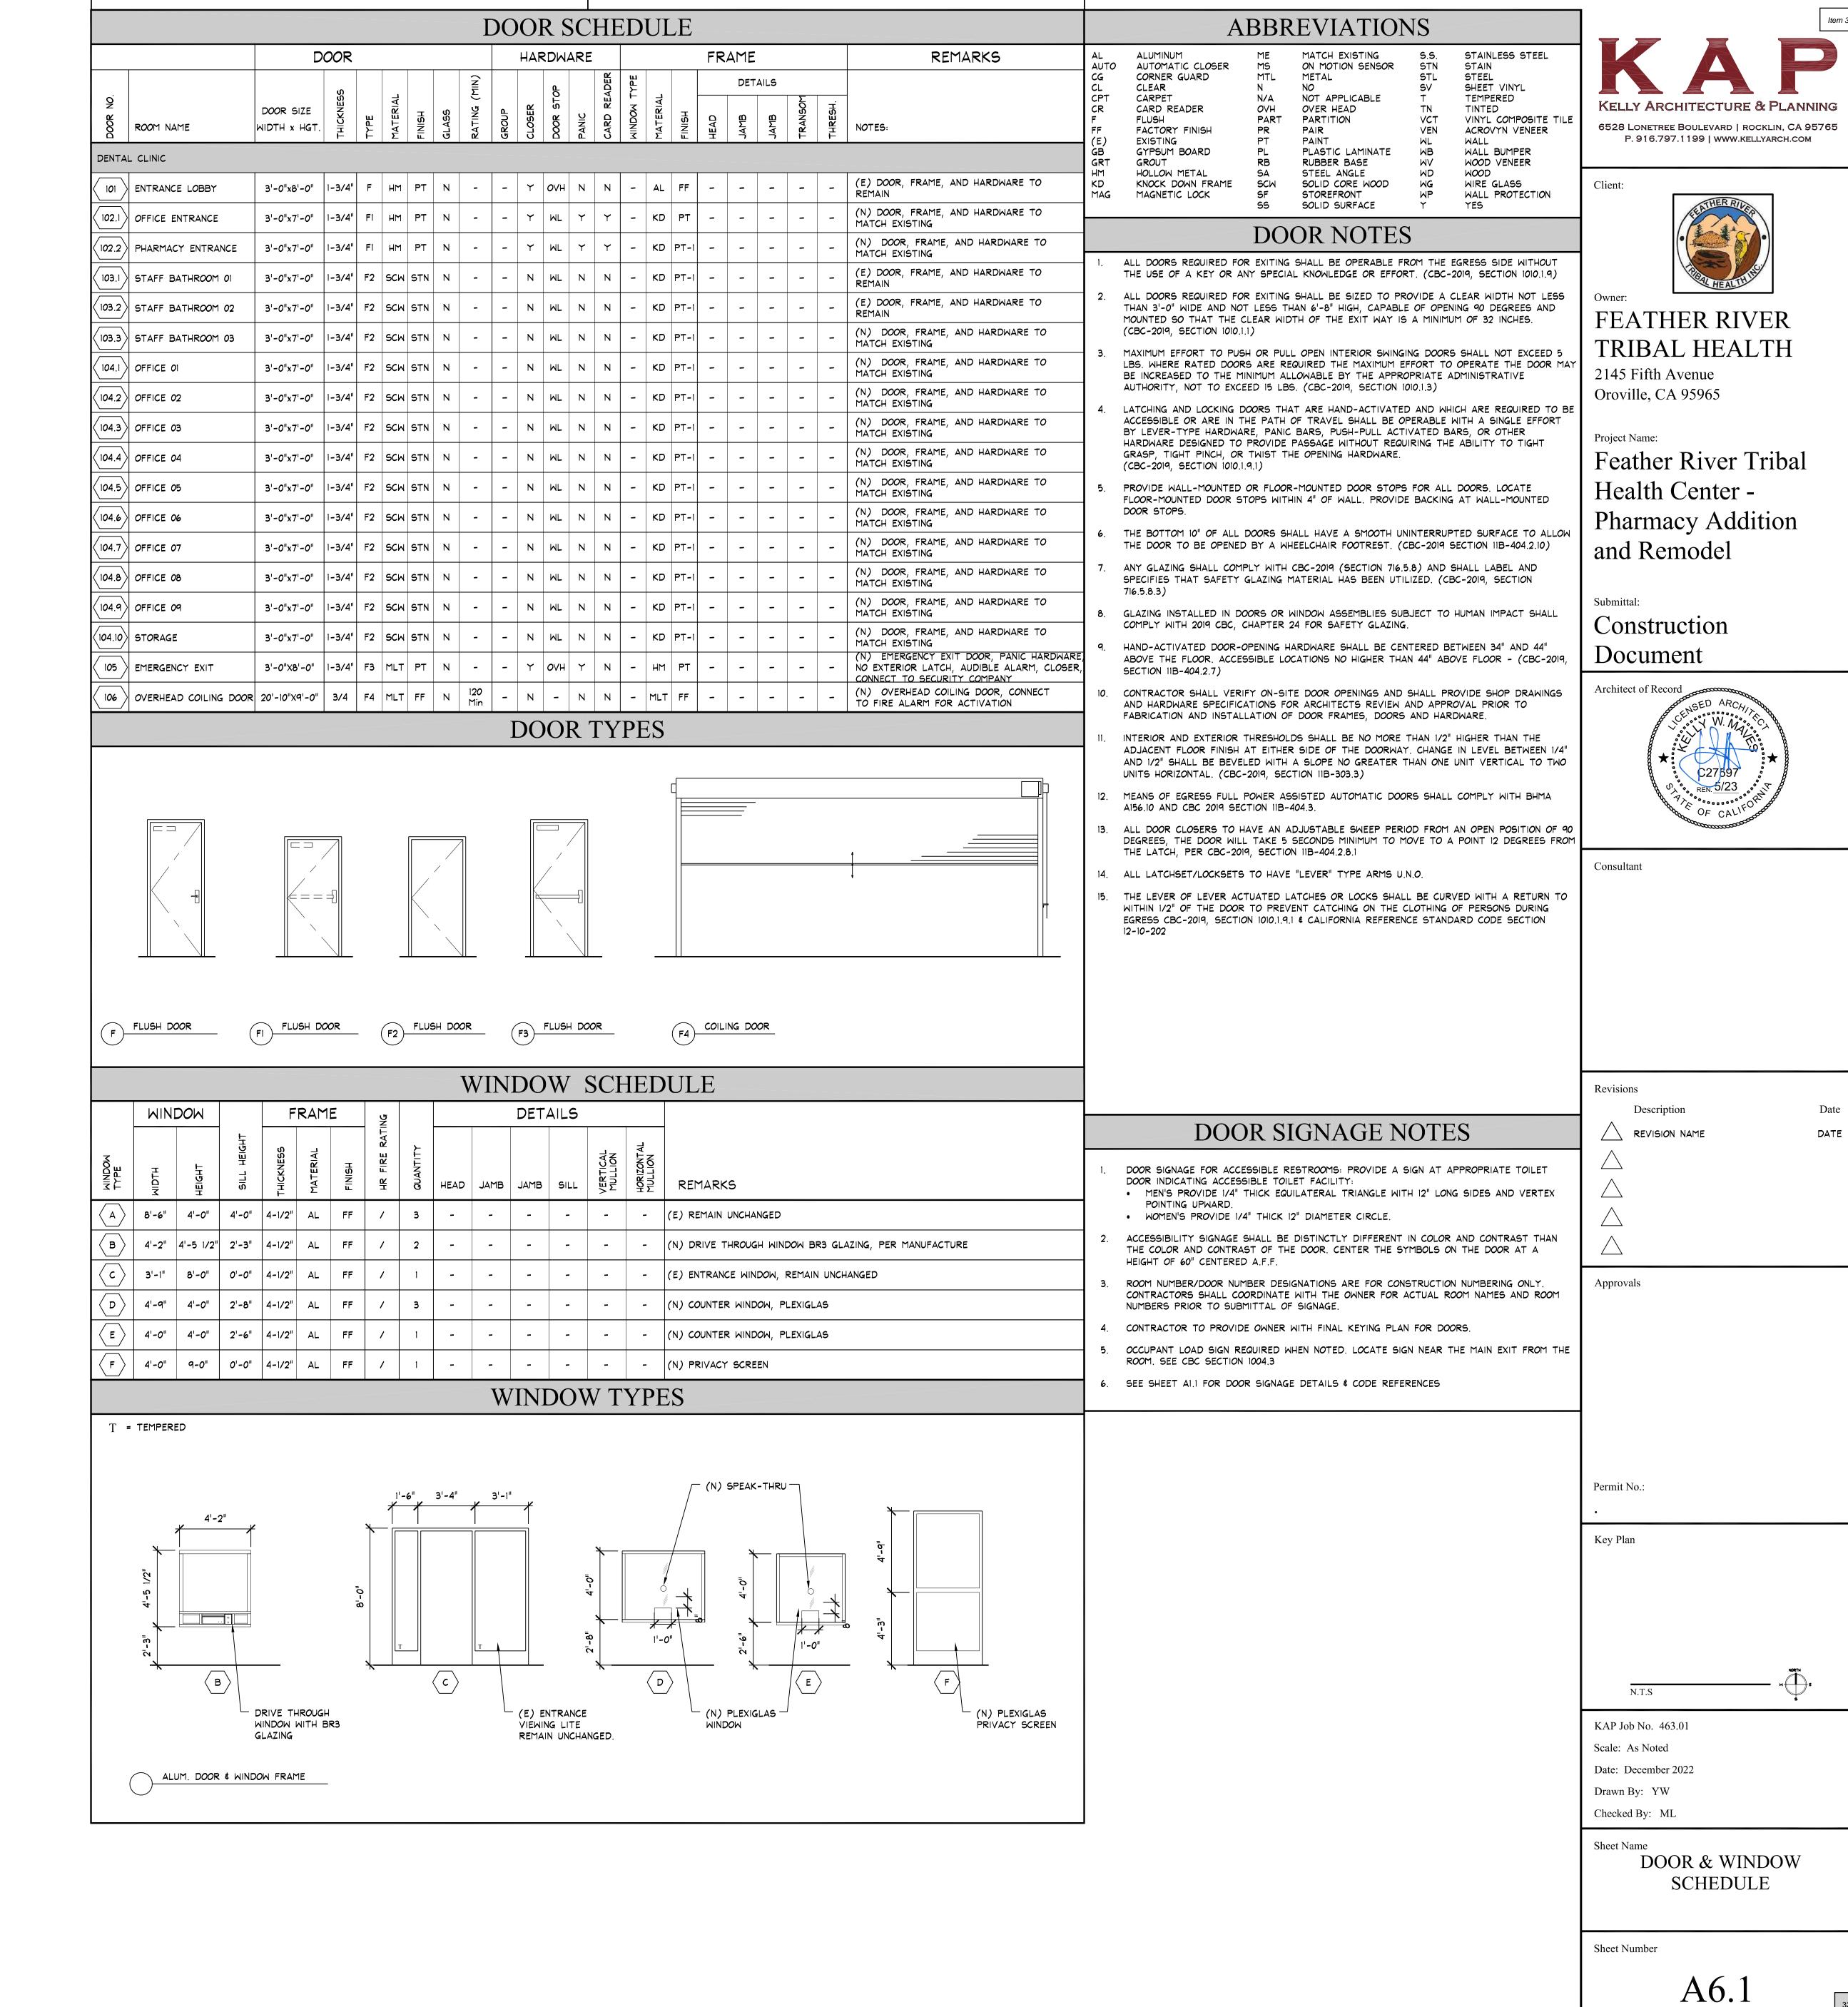
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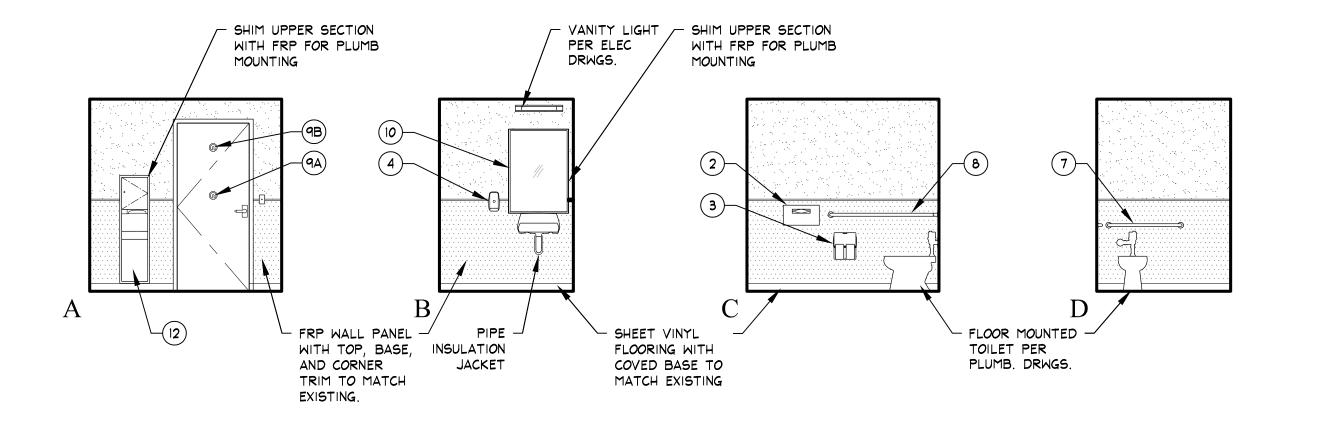
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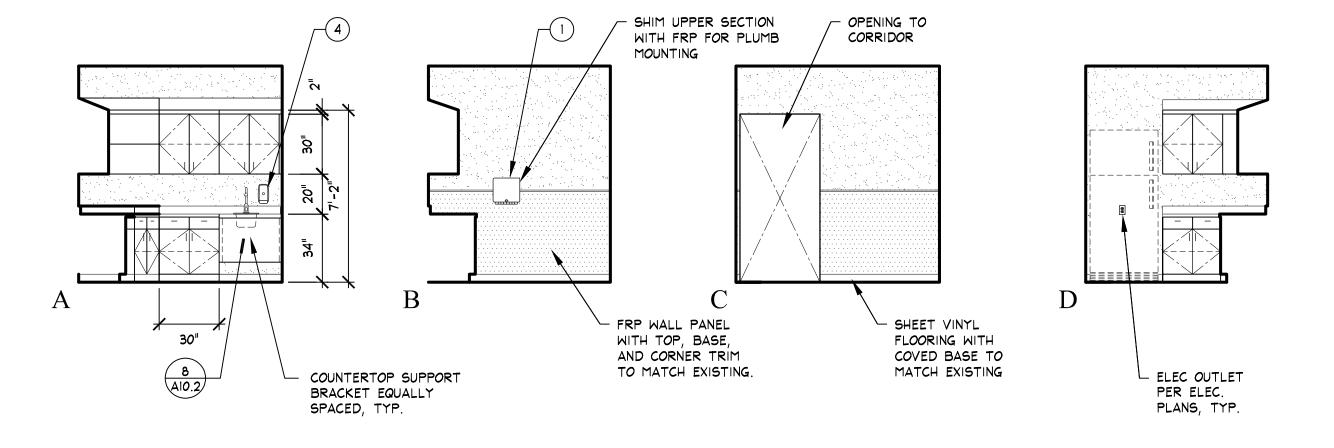


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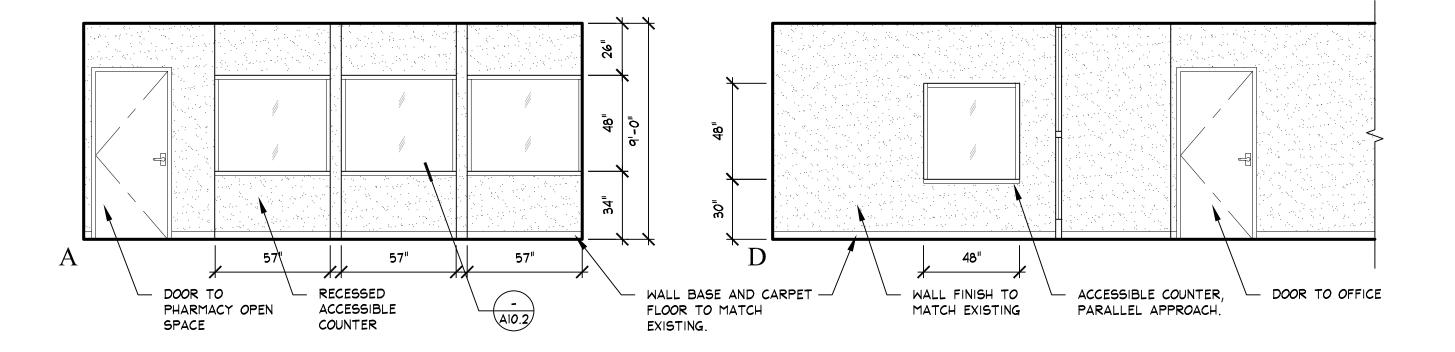
32







BREAKROOM



PHARMACY WAITING ROOM

# ELEVATION GENERAL NOTES

- ALL DIMENSIONS ON THIS SHEET ARE TO FACE OF FINISH, U.N.O.
- 2. THESE ELEVATIONS MAY NOT SHOW ALL ITEMS TO BE INSTALLED OR CORRECT LOCATIONS. SEE STRUCTURAL, MECHANICAL, PLUMBING, ELECTRICAL AND FIRE ALARM DRAWINGS FOR ADDITIONAL INFORMATION.

INTERIOR ELEVATION LEGEND

SEE FINISH SCHED. FOR ADDITIONAL INFORMATION

- 3. SEE SHEET AO.1 FOR TYPICAL MOUNTING HEIGHT AND ADA CLEARANCES AND CODE REFERENCES.
- 4. SEE SHEET AO.O FOR TYPICAL SYMBOLS LEGENDS.
- 5. ALL EQUIPMENTS TO MATCH EXISTING.

FRP WALL PANEL

EXISTING GYPSUM WALLBOARD

(E) / (N) WINDOW GLAZING WHERE OCCURS, SEE FLOOR PLAN

NEW GYPSUM WALLBOARD

FOR WINDOW TYPE

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2145 Fifth Avenue Oroville, CA 95965 ELECTRICAL OUTLET, SEE ELEC. PLANS FOR MORE INFORMATION

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# **EQUIPMENT NOTES**

- SEE MECHANICAL / PLUMBING DRAWINGS FOR UTILITY CONNECTIONS AND INFORMATION WITH APPLICABLE EQUIPMENT
- SEE STRUCTURAL DRAWINGS FOR ANCHORAGE DETAILS ON EQUIPMENT OVER 400 LBS OR THE CENTER OF MASS IS LOCATED ABOVE 48". FOR ALL OTHER EQUIPMENT ANCHOR PER THE MANUFACTURER'S RECOMMENDATIONS AND PRODUCT CUTSHEETS.

# ABBREVIATIONS

ALUMINUM ACRYLIC PAINT AUTOMATIC CLOSER	PT PL RB	PAINT PLASTIC LAMINATE RUBBER BASE	Y FRTH.F.F.I	YES FEATHER RIVER TRIBAL HEALTH FURNISHED/
CLEAR CARPET CARD READER	SA SC SF	STEEL ANGLE SOLID CORE WOOD STOREFRONT	FRTH.F.C.I	FRTH INSTALLED FEATHER RIVER TRIBAL HEALTH FURNISHED/
FLUSH FACTORY FINISH EXISTING	55 5.5. 5T	SOLID SURFACE STAINLESS STEEL STAIN	C.F.C.I.	CONTRACTOR INSTALLED CONTRACTOR
GYPSUM BOARD HOLLOW METAL KNOCK DOWN FRAME MAGNETIC LOCK	STL SV T TN	STEEL SHEET VINYL TEMPERED TINTED	V.F.V.I.	FURNISHED/ CONTRACTOR INSTALLED FEATHER RIVER TRIBAL
MATCH EXISTING METAL NO	VCT VEN WV	VINYL COMPOSITE TILE ACROVYN VENEER WOOD VENEER	V.II.V.II.	HEALTH VENDOR FURNISHED/ FRTH VENDER INSTALLED
NOT APPLICABLE PAIR	WD WG	WOOD WIRE GLASS		

ACCESSORY NOTES

- FOR TYPICAL RESTROOM INFORMATION, SEE RESTROOM DIMENSIONS AND MOUNTING HEIGHTS ON INTERIOR ACCESSIBILITY DETAILS SHEET A0.2.
- 2. CONTRACTOR TO PROVIDE NECESSARY BACKING FOR ALL ACCESSORIES. SEE BACKING DETAIL SHEET A10.2
- 3. INSTALL ACCESSORIES FOR MANUFACTURERS INSTALLATIONS UNLESS NOTED OTHERWISE. ITEMS NOT DETAILED SHALL BE FIELD REVIEWED BY FIELD INSPECTOR PRIOR TO INSTALLATION.

# ACCESSORIES SCHEDULE

ACCESS. NUMBER	DESCRIPTION	MODEL NUMBER	FRTH.F.F.I.	FRTH.F.C.I.	C.F.C.I.	BACKING	DETAIL NUMBER
1	PAPER TOWEL DISPENSER (MANUAL)	MATCH EXISTING					
2	TOILET SEAT COVER DISPENSER	MATCH EXISTING				0	
3	TOILET PAPER DISPENSER	MATCH EXISTING				•	
4	LIQUID SOAP DISPENSER	MATCH EXISTING					
5	HAND SANITIZER	MATCH EXISTING				•	
6							
7	GRAB BAR (36")	MATCH EXISTING					
8	GRAB BAR (42")	MATCH EXISTING			0	0	
<b>9</b> A	ROBE HOOK - ADA HEIGHT - 46" AFF	MATCH EXISTING			0		
9B)	ROBE HOOK - 70" AFF	MATCH EXISTING					
10	MIRROR WITH SS FRAME (30"X42")	MATCH EXISTING					
(12)	RECESSED PAPER TOWEL DISPENSER AND WASTE RECEPTACLE	MATCH EXISTING					

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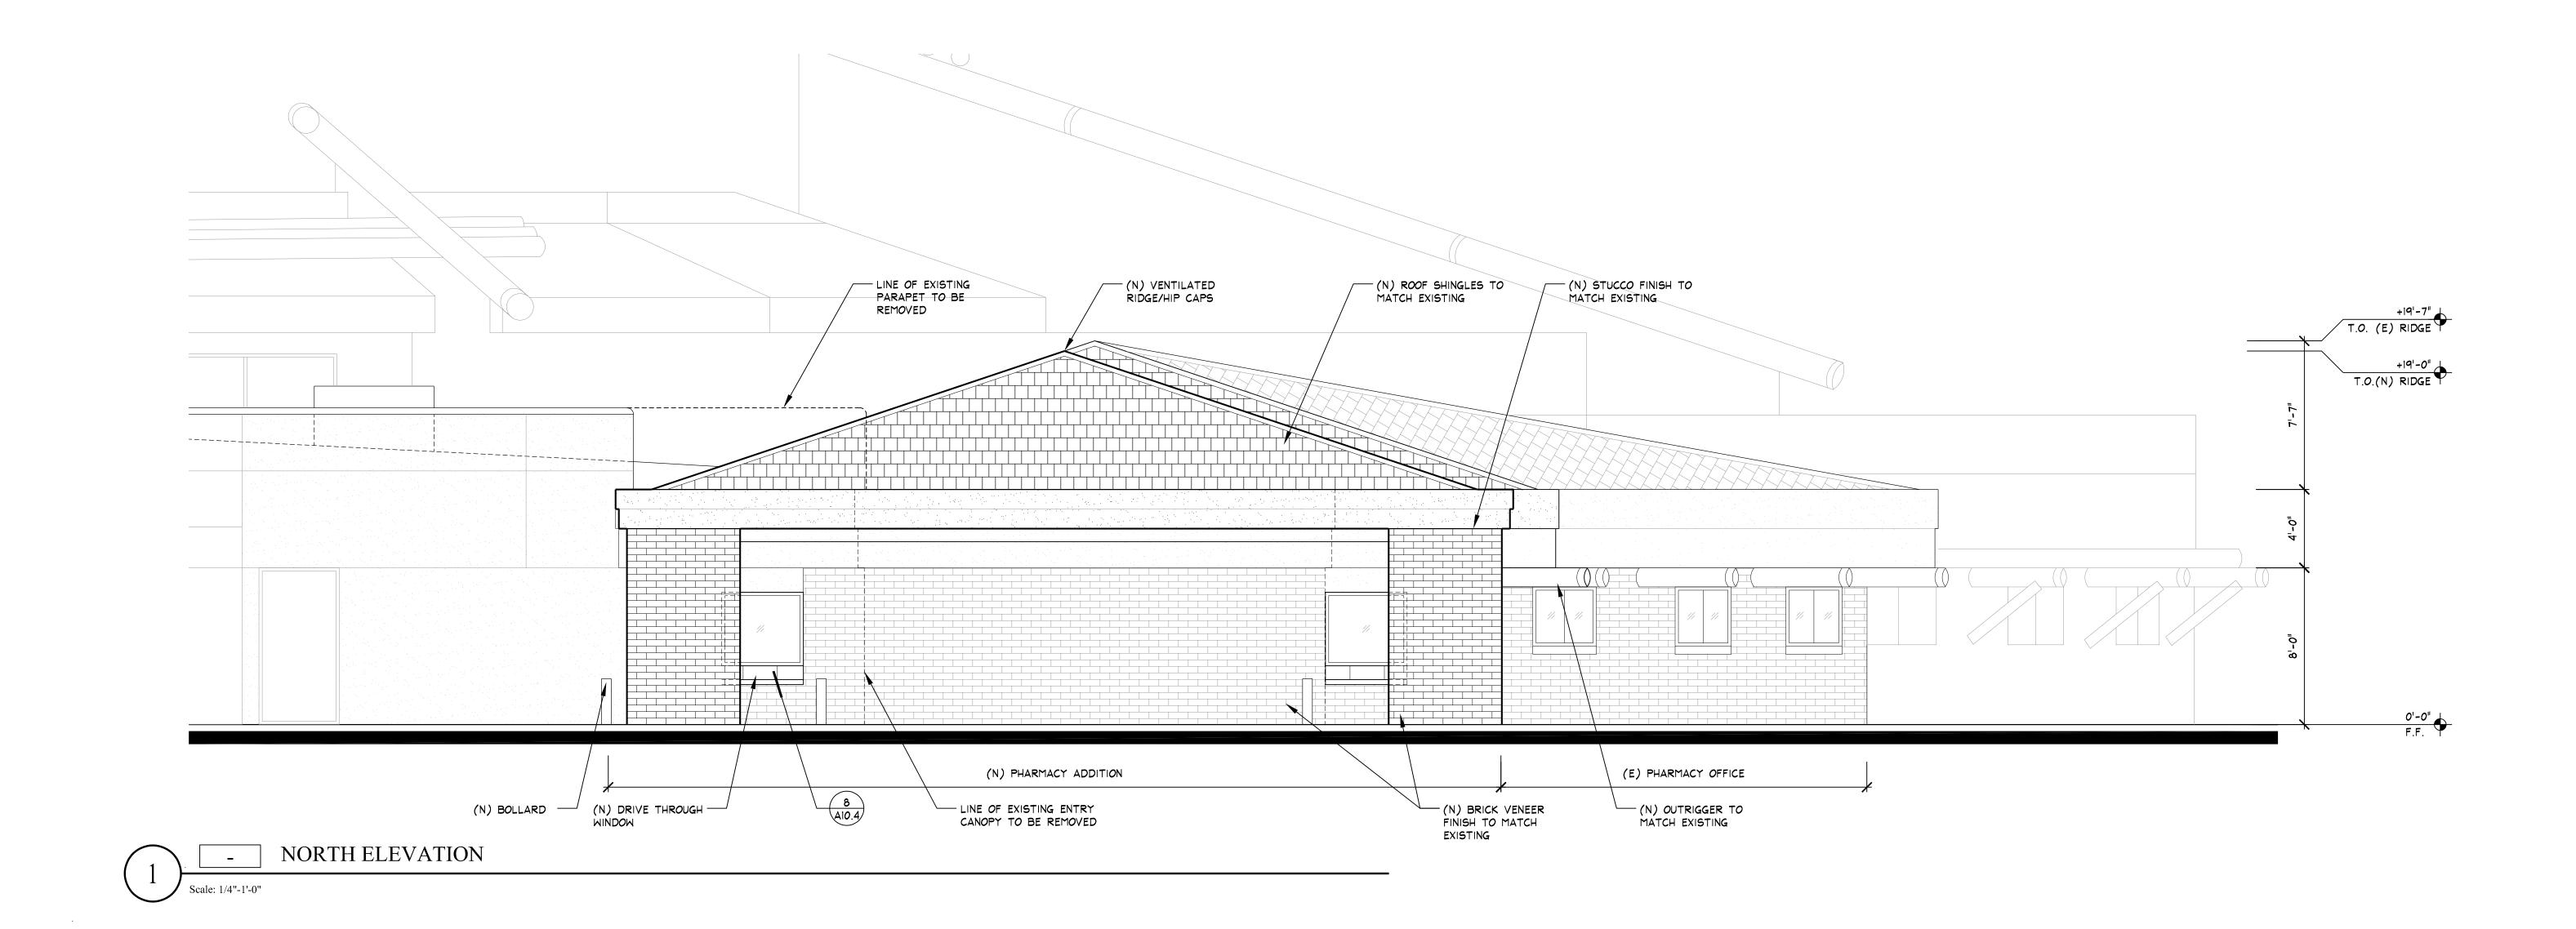
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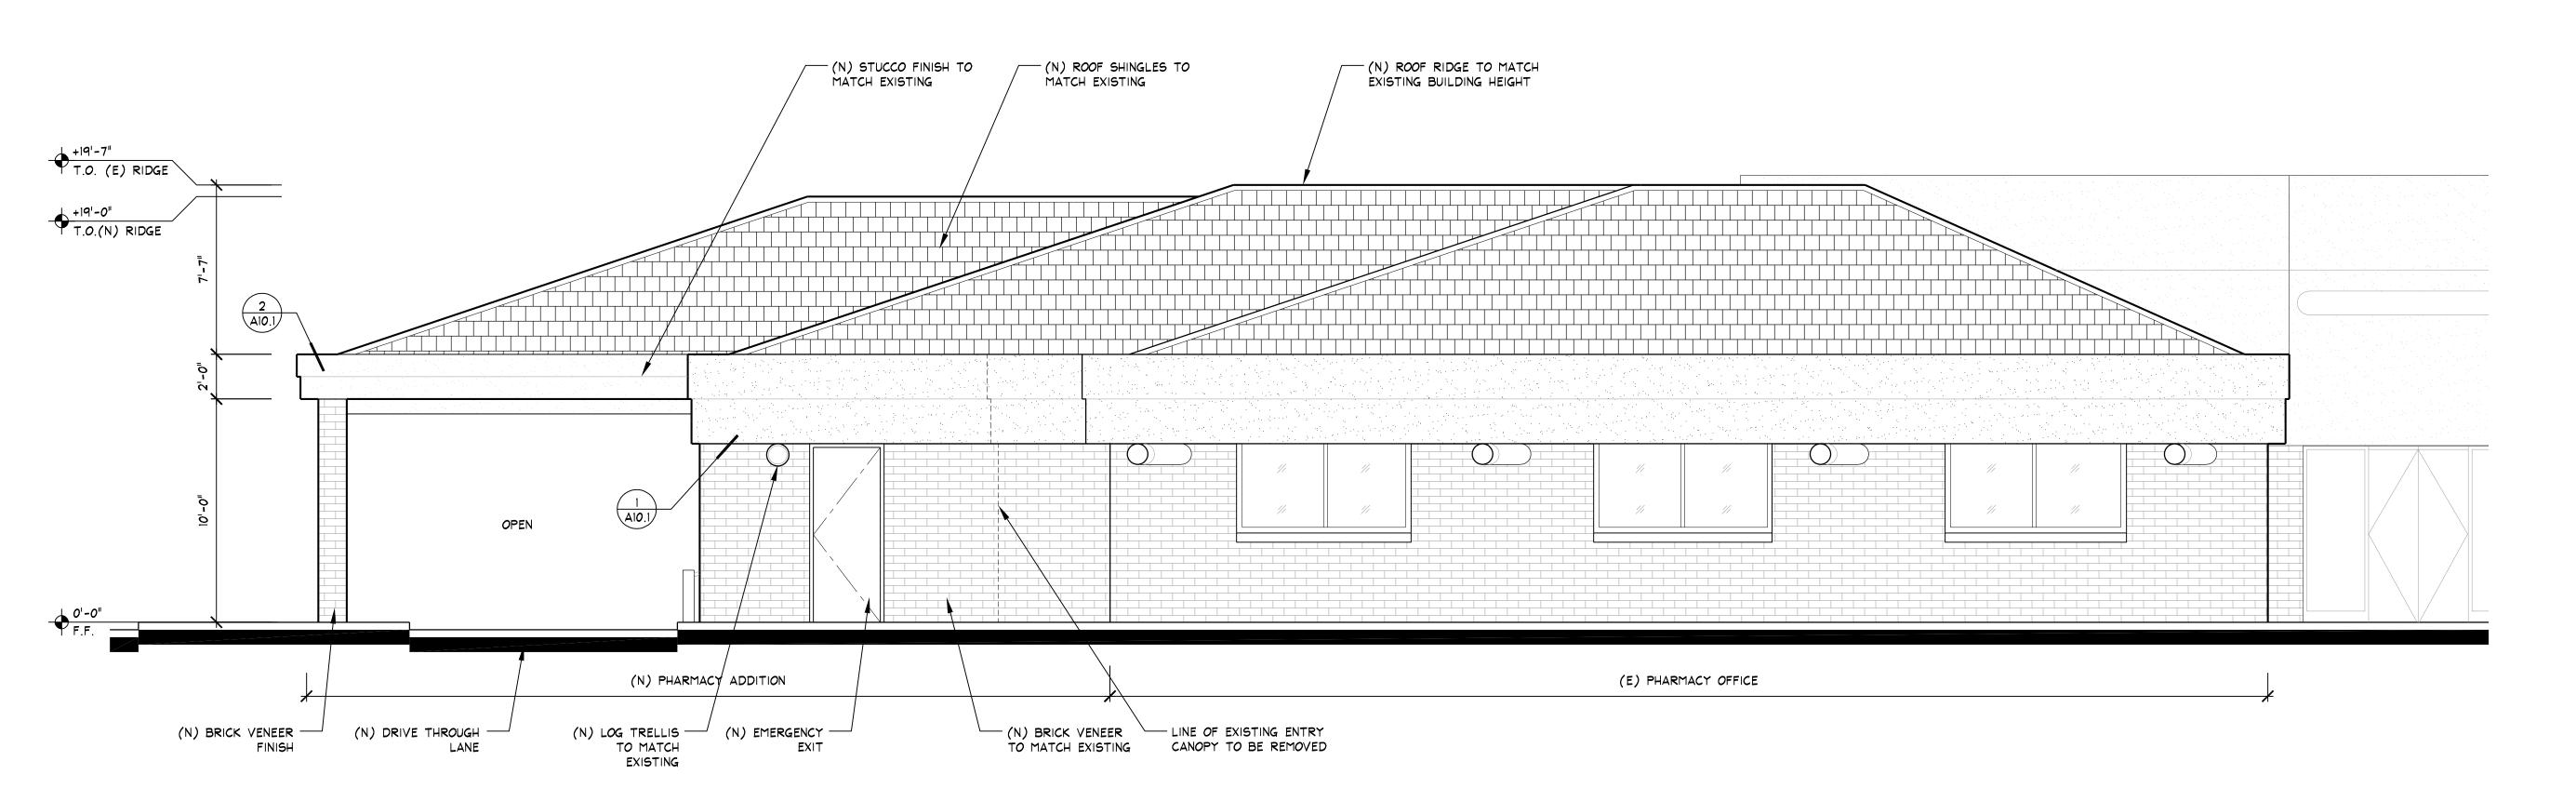
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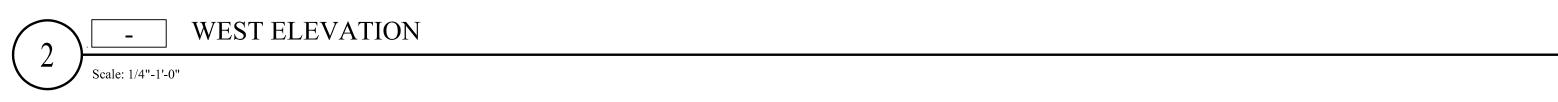
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Sheet Name INTERIOR ELEVATIONS

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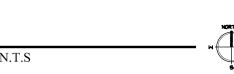
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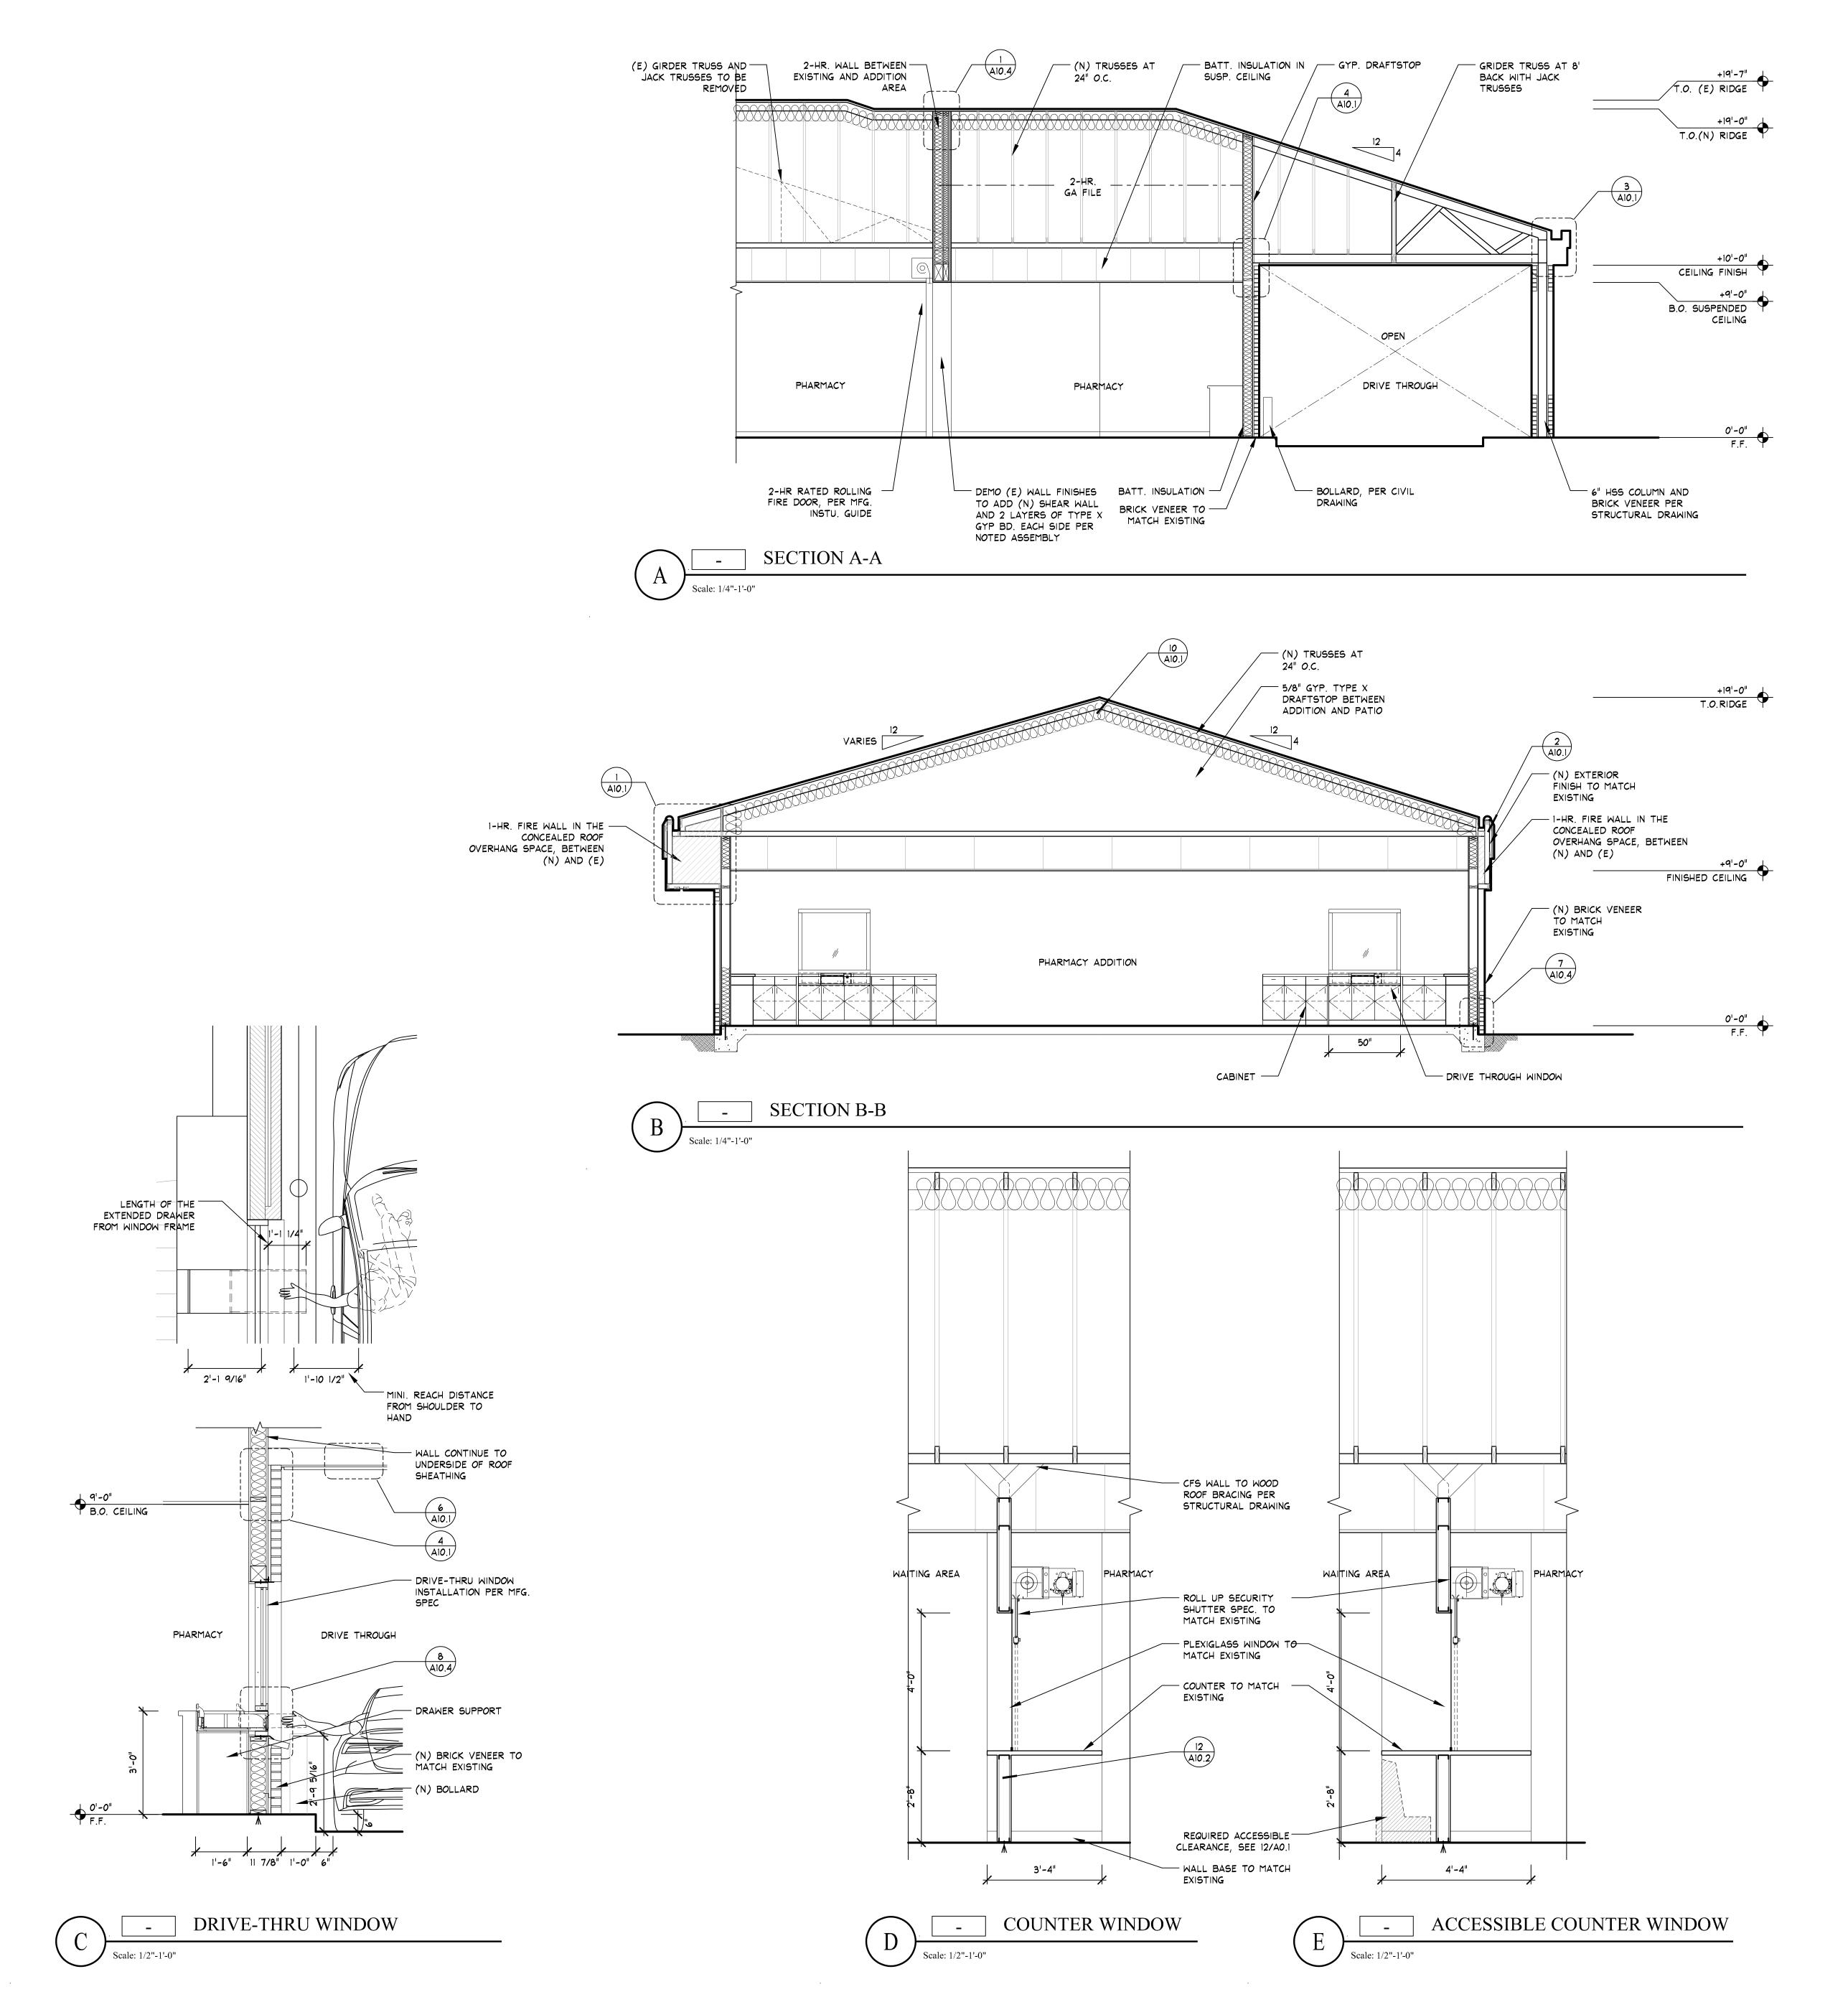
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**EXTERIOR ELEVATIONS** 

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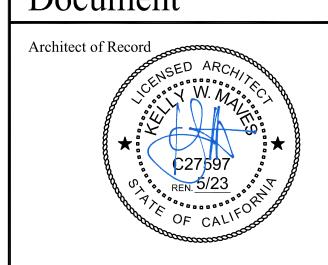
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Construction
Document




Consultant

Revisions		
	Description	Date
	REVISION NAME	DATE
Approvals		

Permit No.:

Key Plan

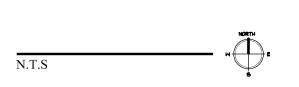

KAP Job No. 463.01

Scale: As Noted

Date: December 2022

Drawn By: YW

Checked By: ML


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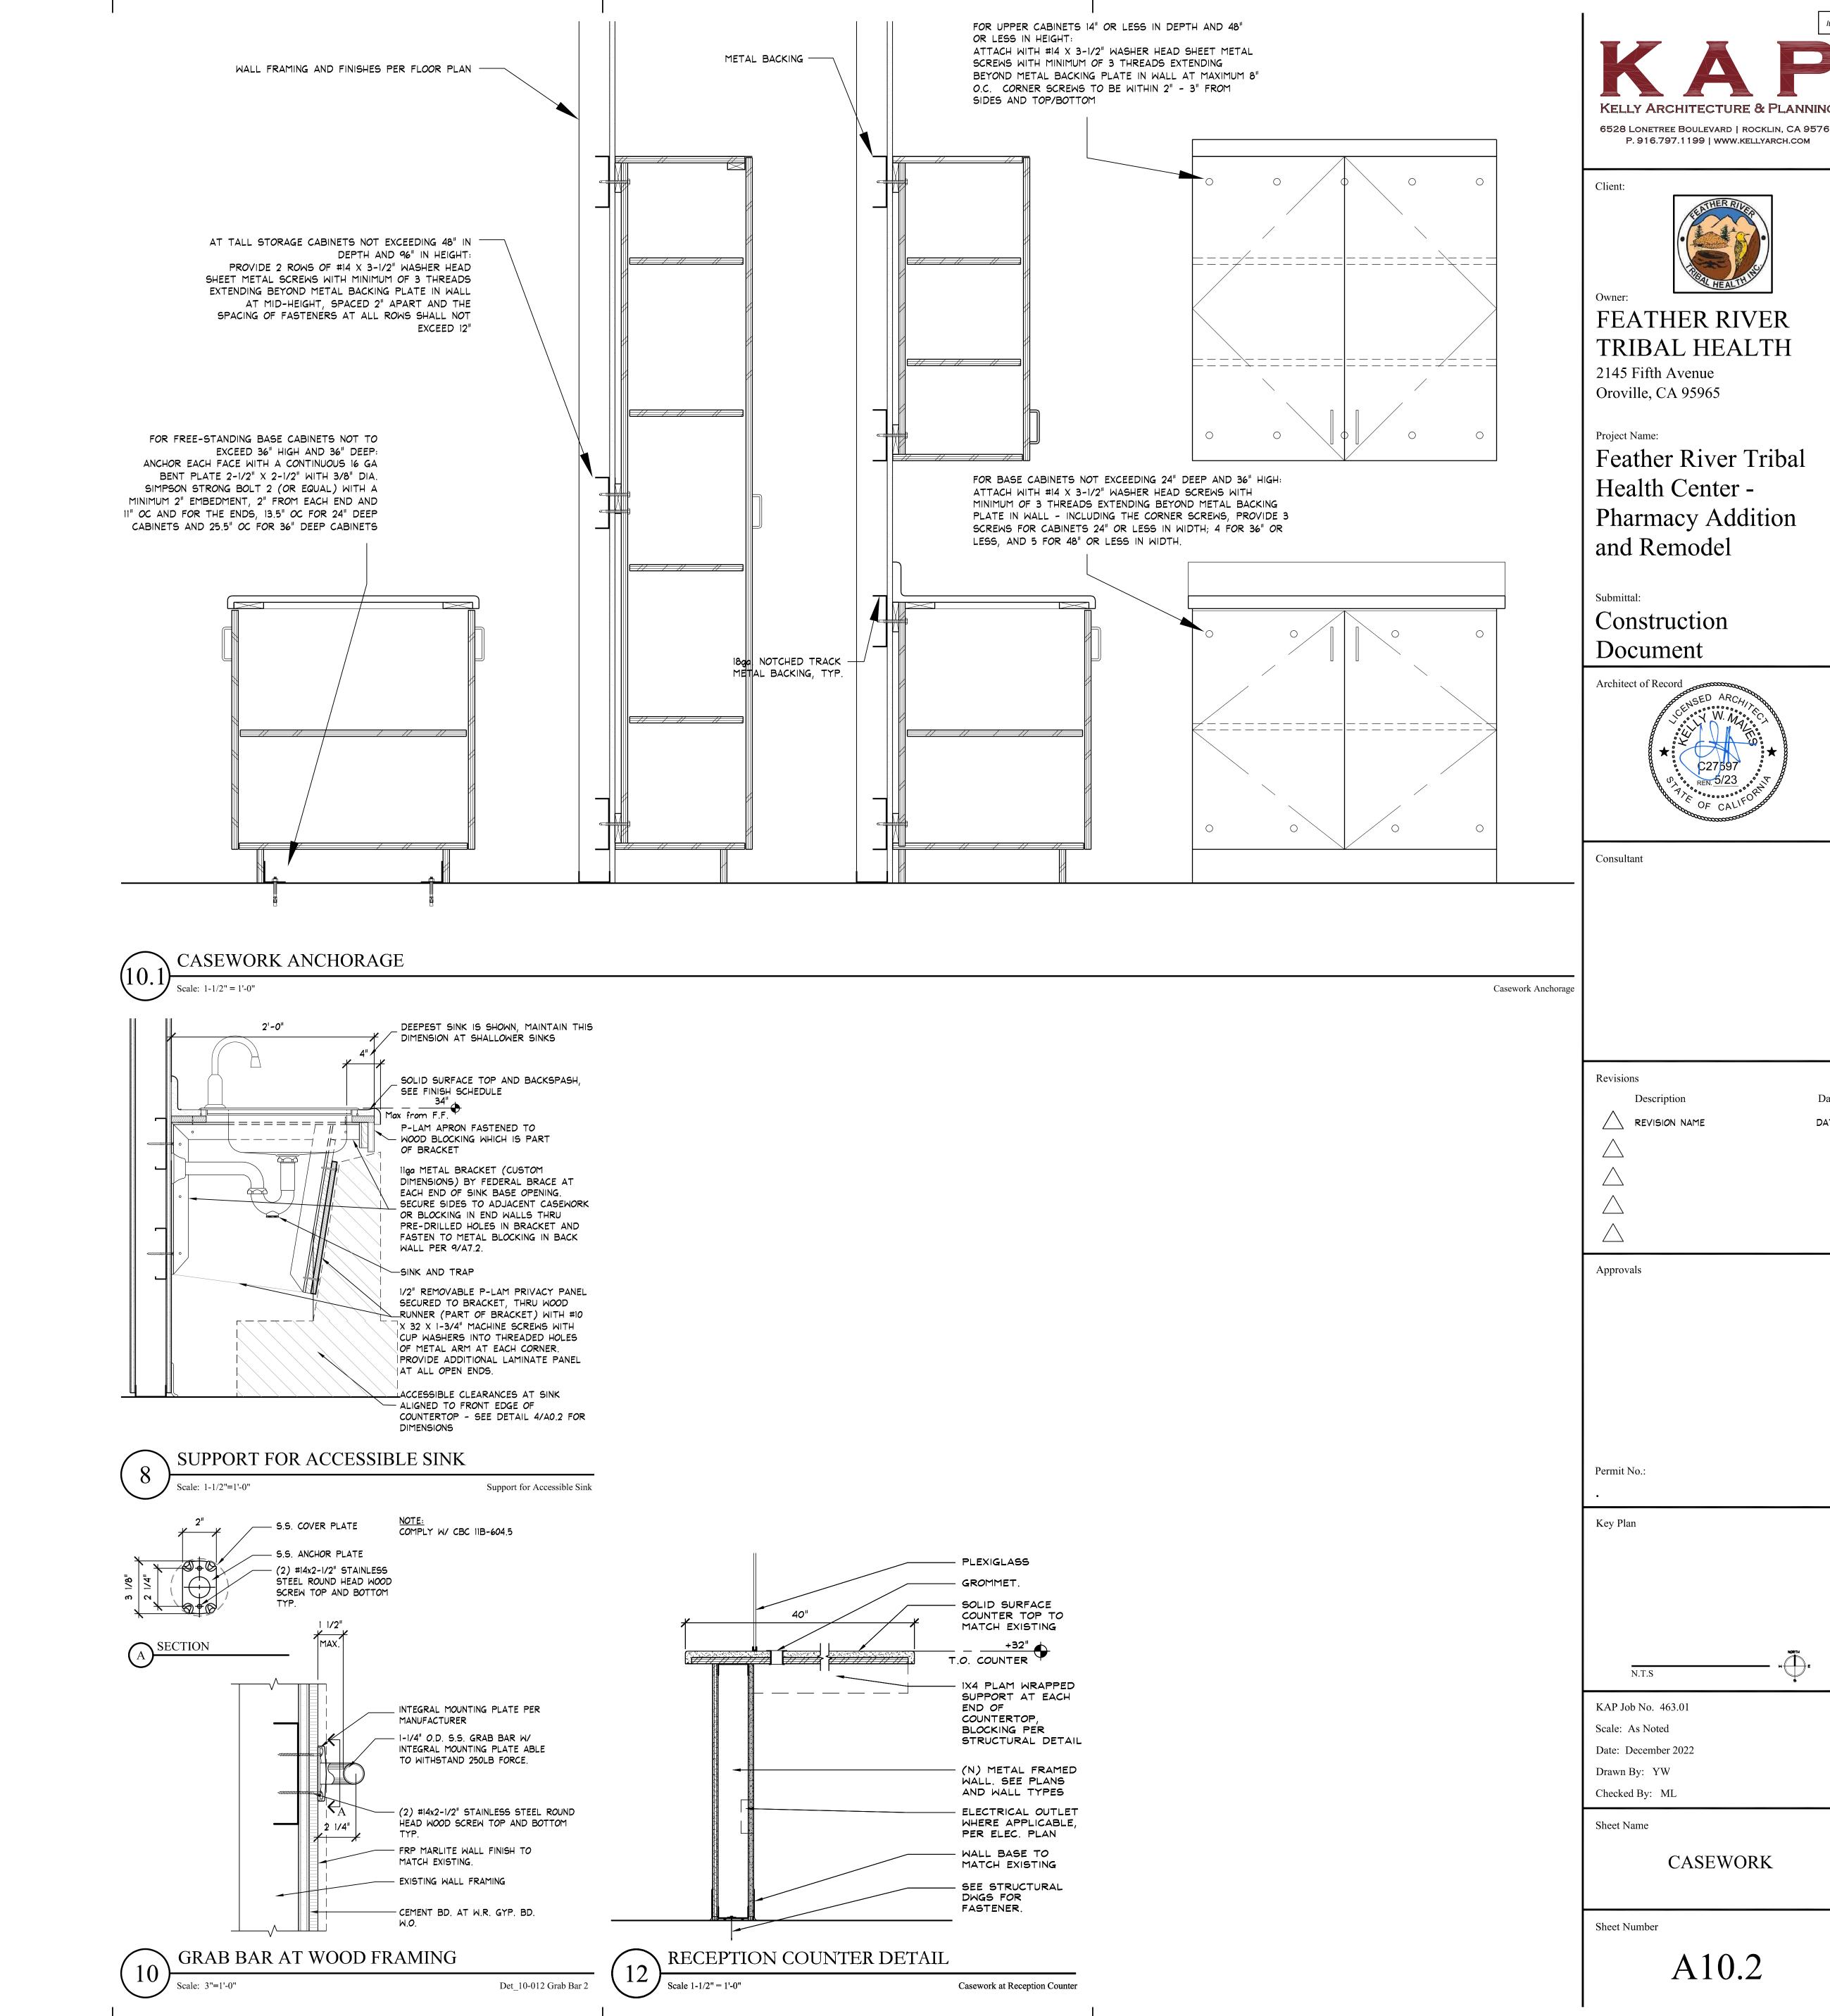
SECTIONS

Sheet Number

A9.1






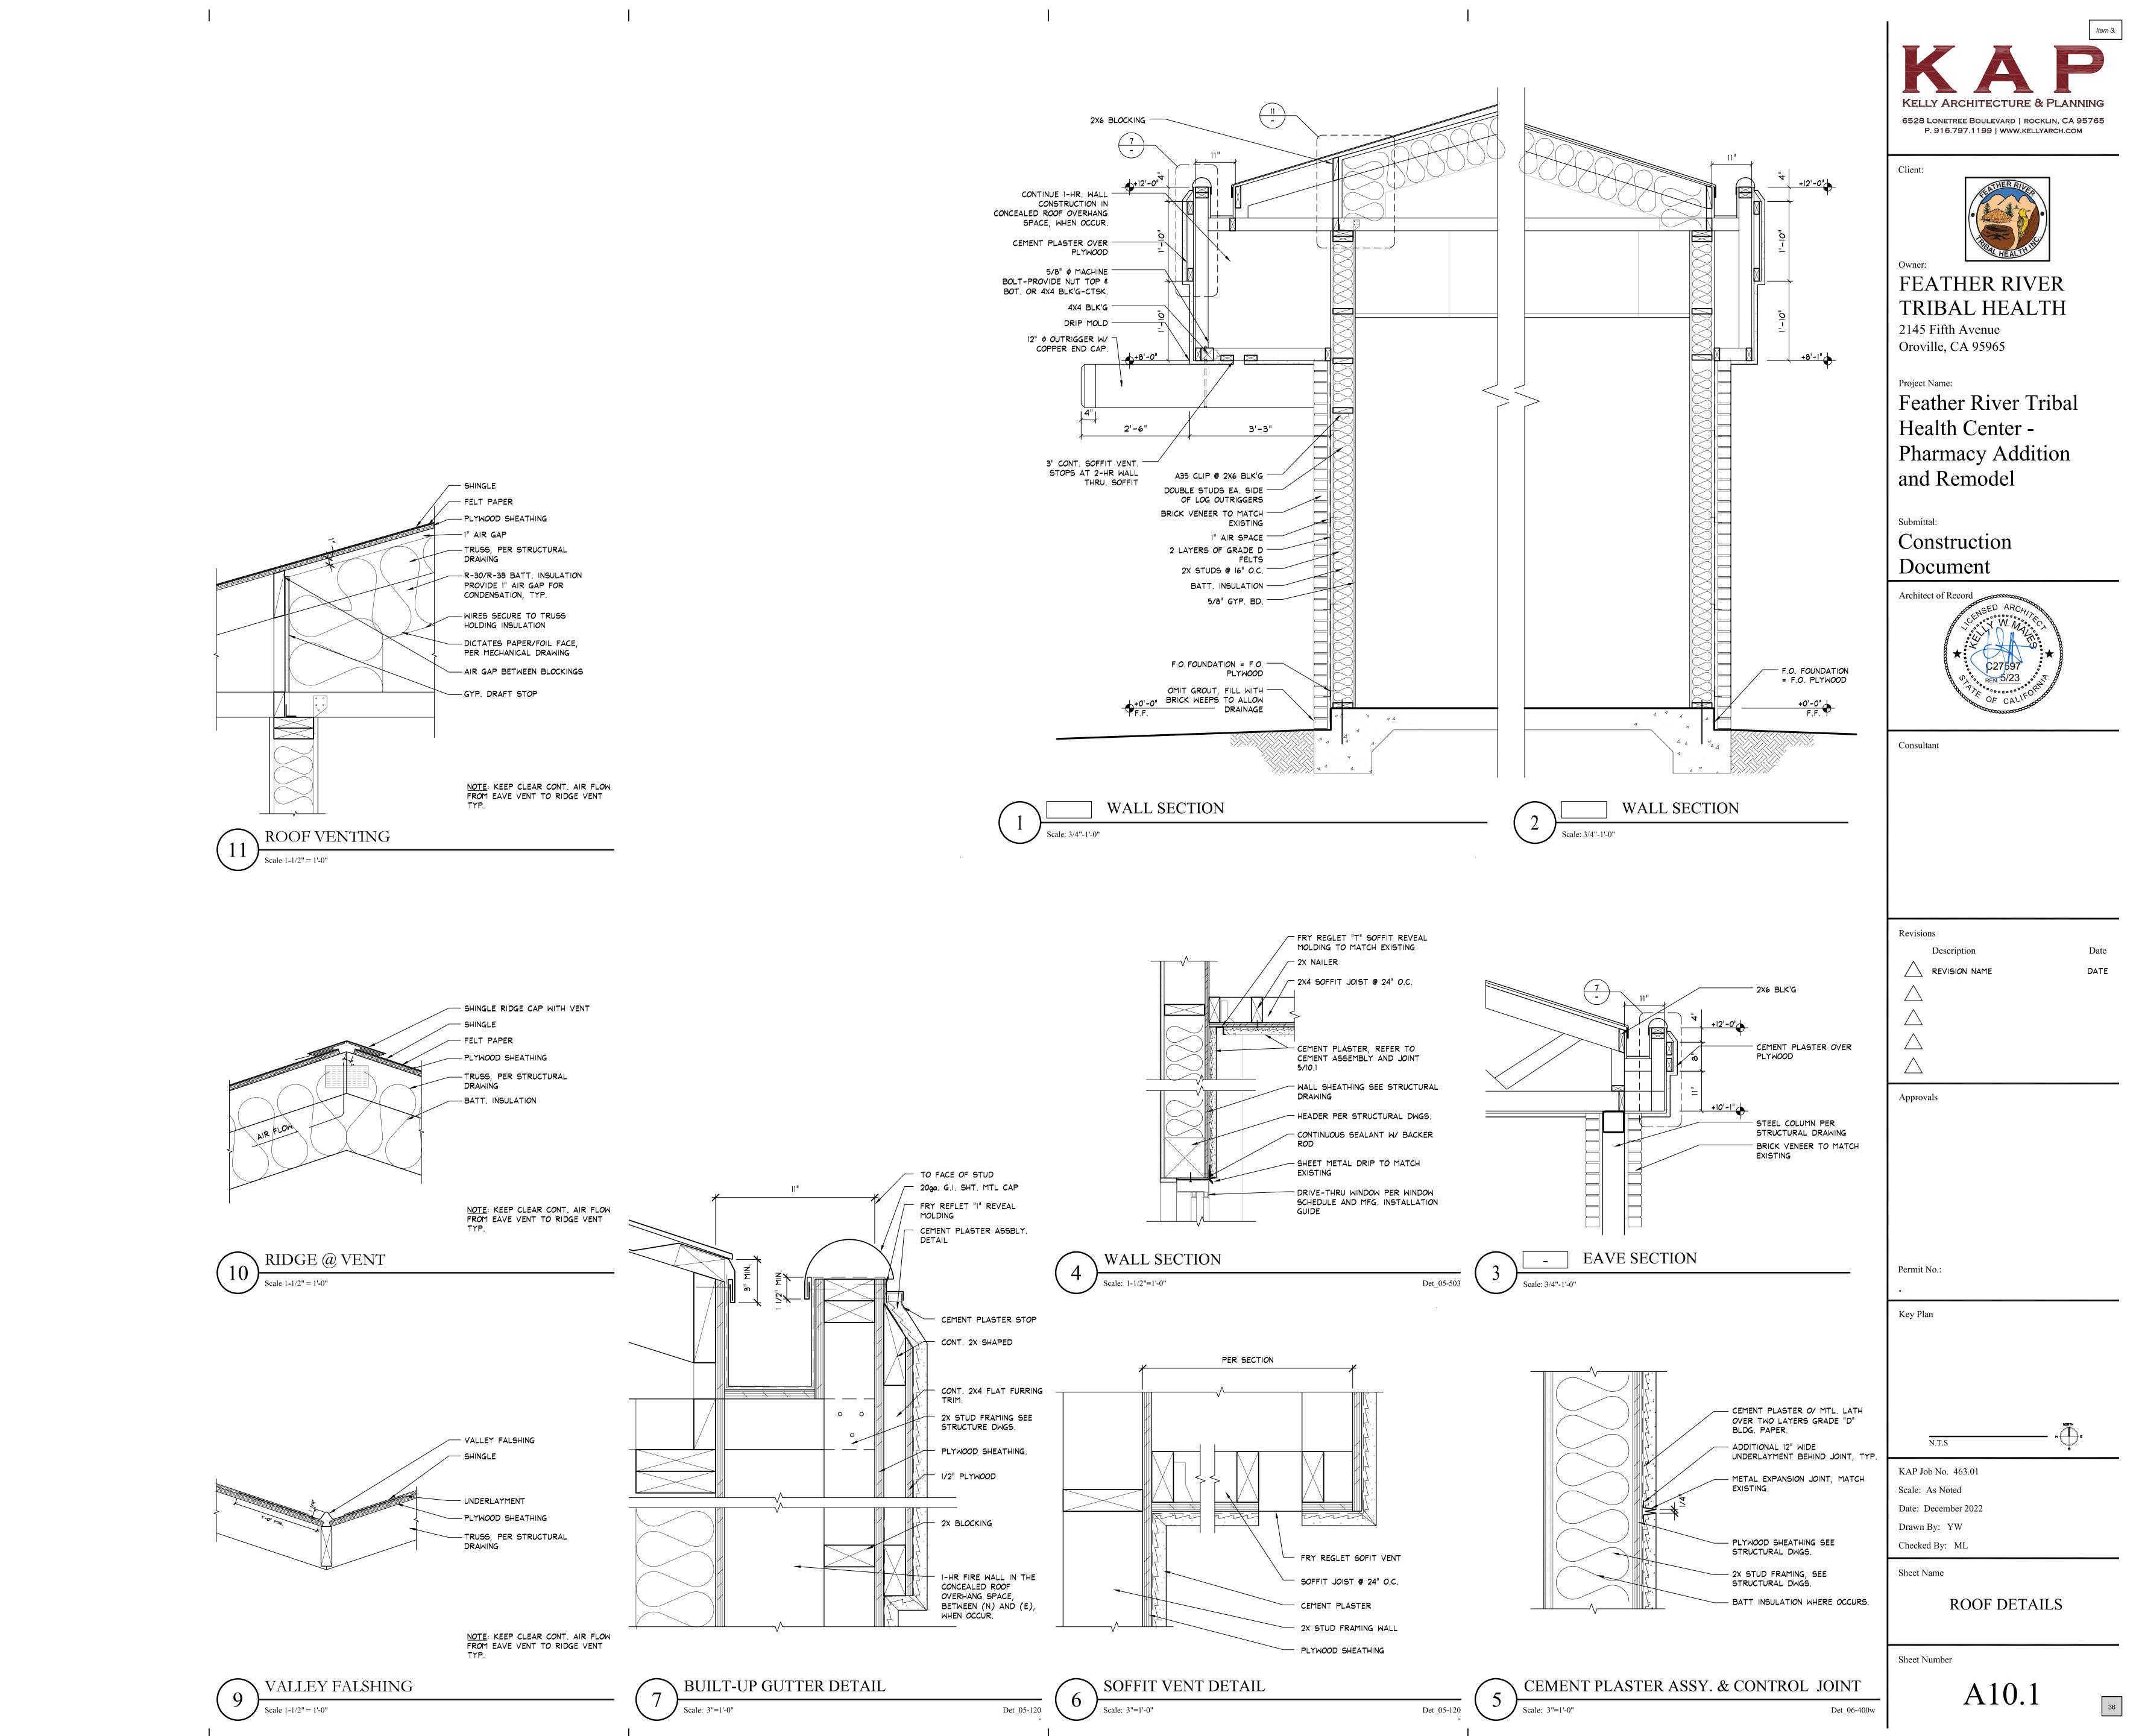


KELLY ARCHITECTURE & PLANNING 6528 LONETREE BOULEVARD | ROCKLIN, CA 95765

DATE



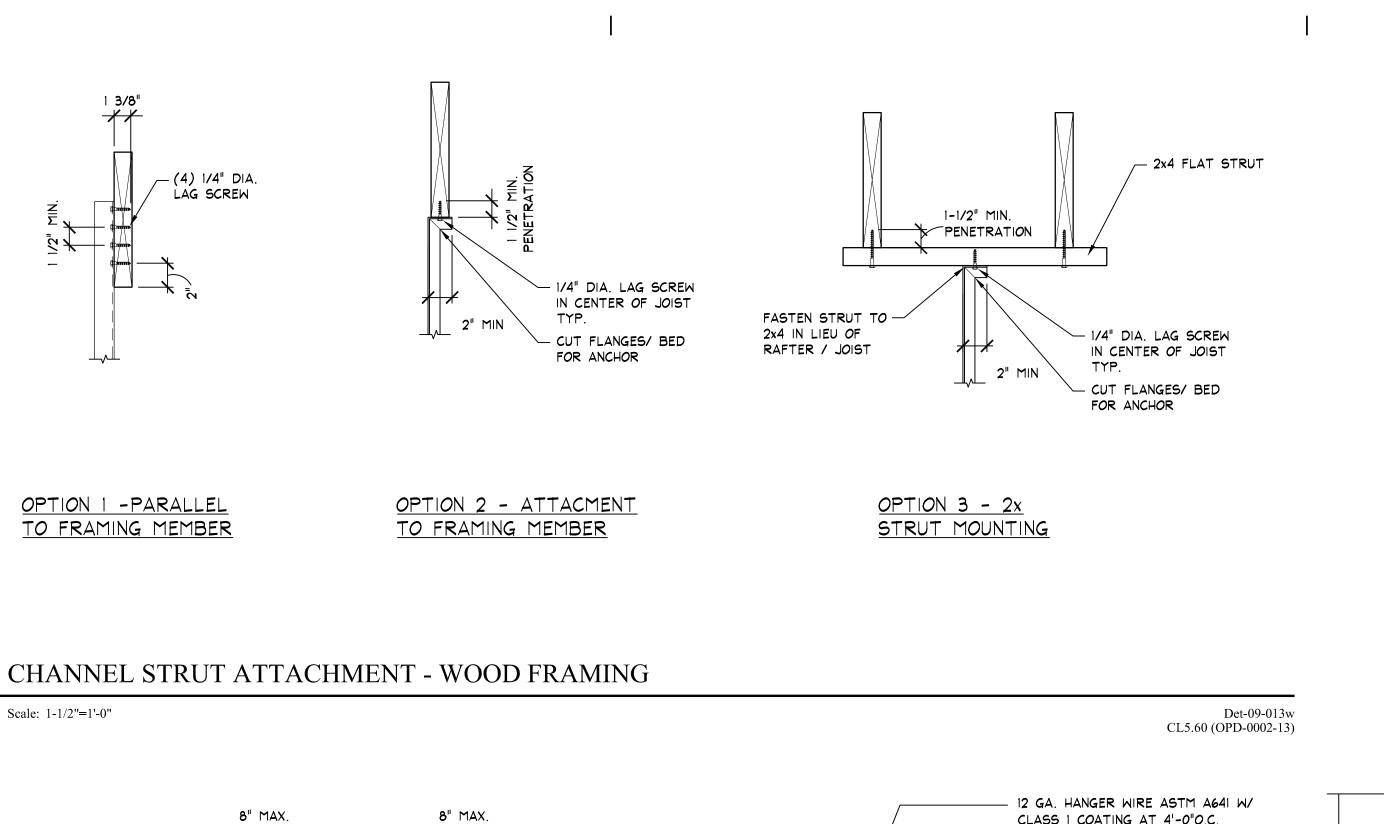

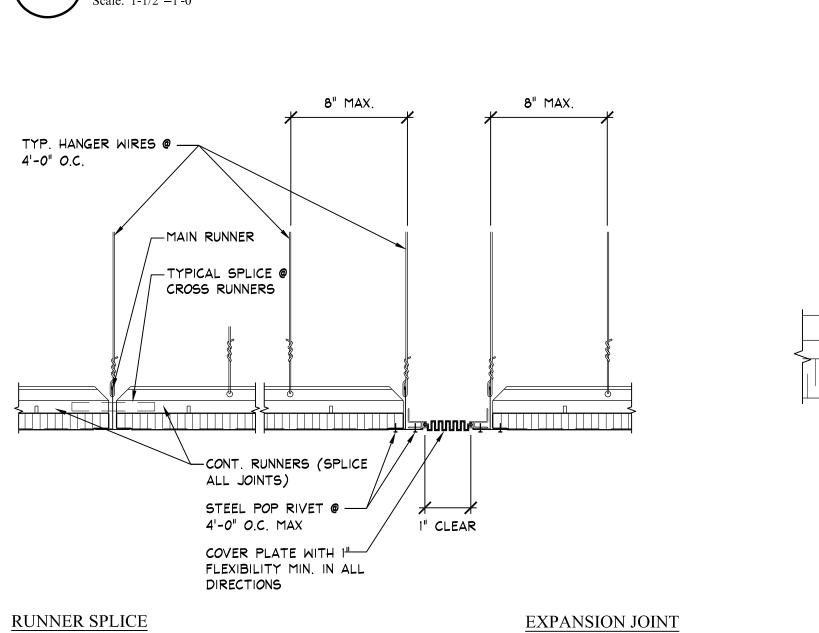

**EXPANSION JOINT (CEILING TO CEILING)** 


Det-09-008


- 3x BLOCKING FASTEN TO JOIST OR

8dXI-1/2" NAILS AT EACH SIDE/END.

TRUSS WITH A-35 CLIP AND (4)

Scale: 3'' = 1'-0''

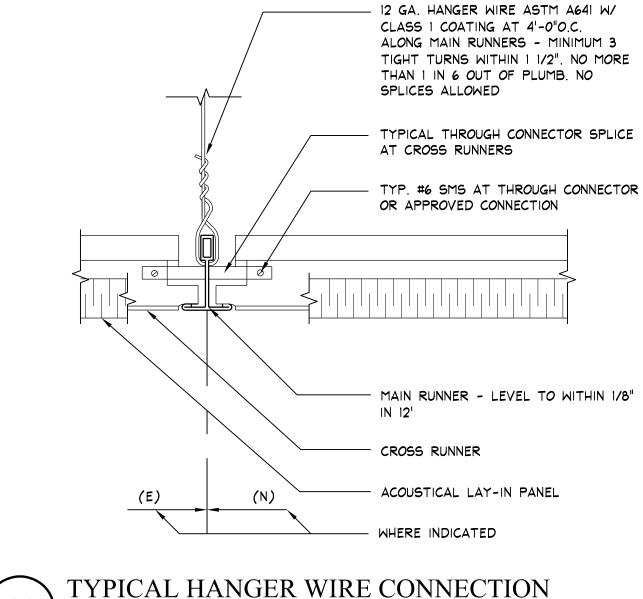

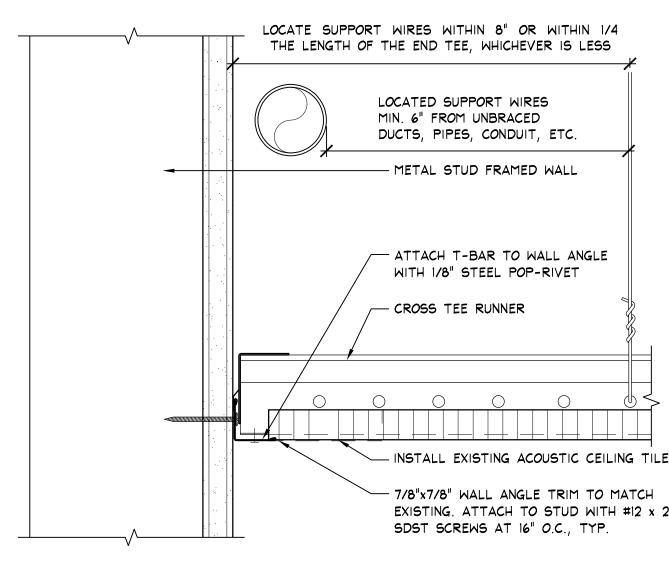


NOTE: SEE DETAIL 5/AIO.4 FOR ADDITIONAL

INFORMATION

WOOD STRUCTURE

4005137-33 (20 GA.)

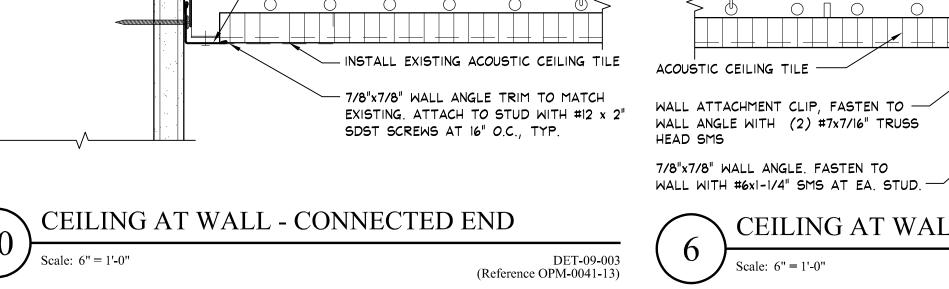

-(2) 12 GA. SLACK WIRE HANGERS


SYSTEM REQUIRED). PLACE ON

- (2) #8 SMS EACH SIDE, TYPICAL

DIAGONAL CORNERS, TYPICAL

FOR DEVICES THAT WEIGHT LESS

THAN 56 LBS (HEAVY DUTY GRID

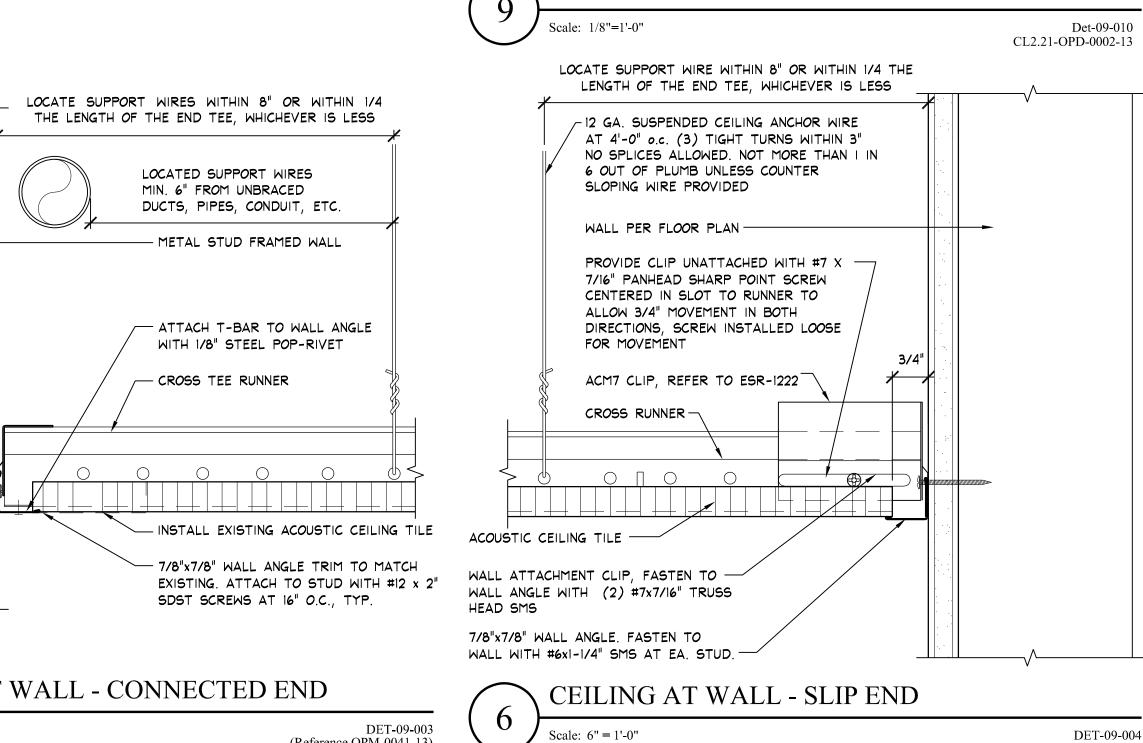

FOR LIGHTING AND MECHANICAL SUPPORT DETAIL AND INFORMATION, SEE

FREE JOINT

ATTACHED JOINT

8'-0" MAX.

4'-0" MAX, FROM

WALL EACH WAY

2'-0" (TYP)

- SUSPENDED CEILING SUPPORT WIRE AT

PERIMETER, 8" MAX. FROM WALL, ALL

COMPRESSION STRUT AT 12'-0" O.C.

LAY-IN ACOUSTIC CEILING TILES, TO

- SUSPENDED CEILING MAIN RUNNERS.

- SUSPENDED CEILING SYSTEM CROSS

RUNNER. SPAN BETWEEN MAIN RUNNERS,

MAIN RUNNER. SEE 12 19


ATTACH TO STRUCTURE WITH 12 GAUGE


HANGER WIRES AT 4'-0" O.C. ON EACH


EACH WAY, SEE /


MATCH EXISTING


SUSPENDED ACOUSTICAL CEILING LAYOUT

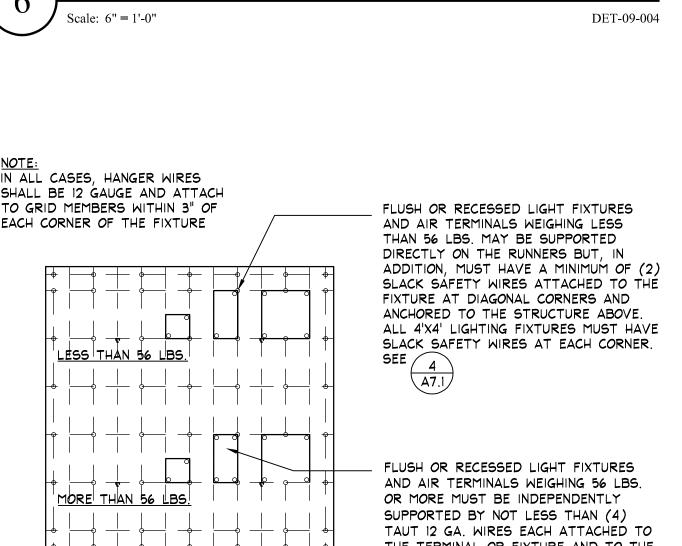


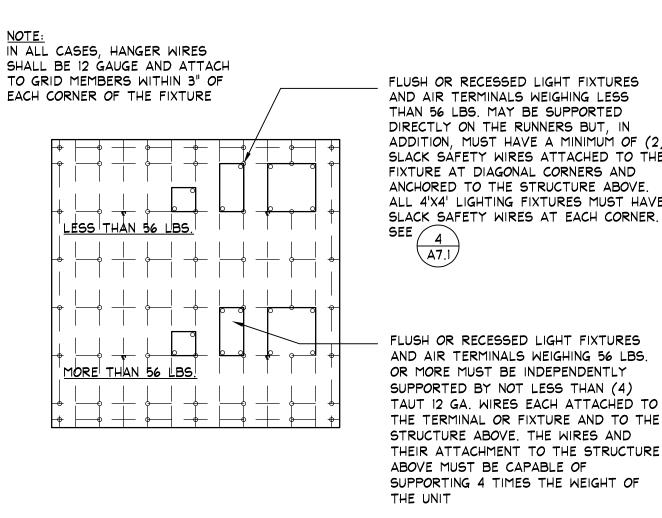


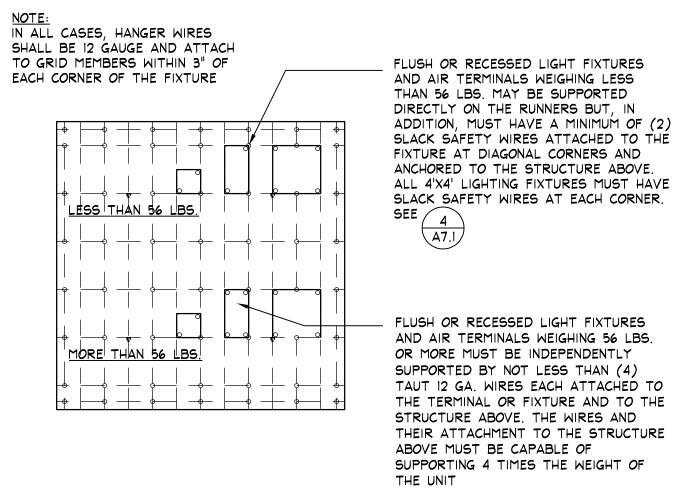


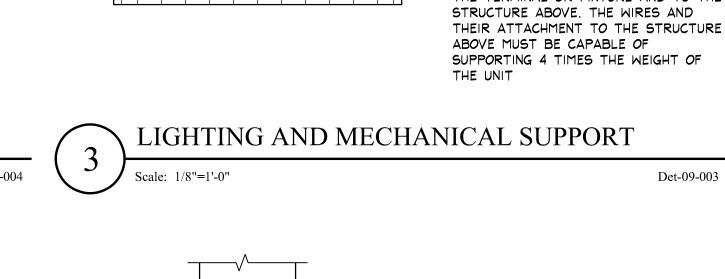

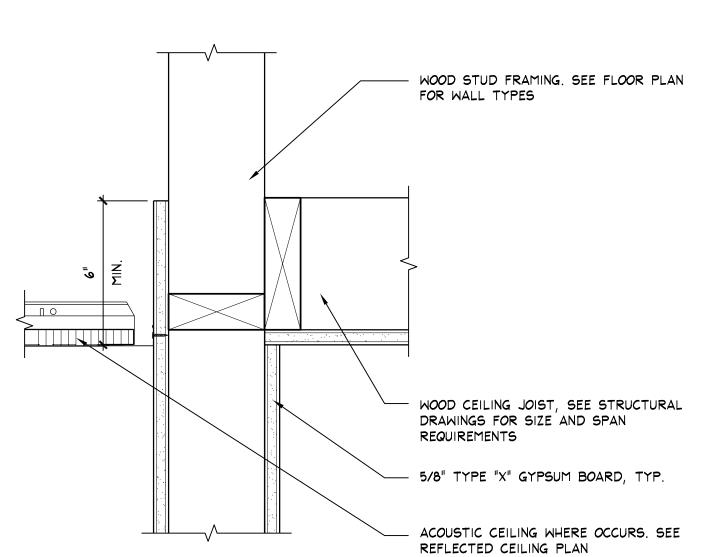

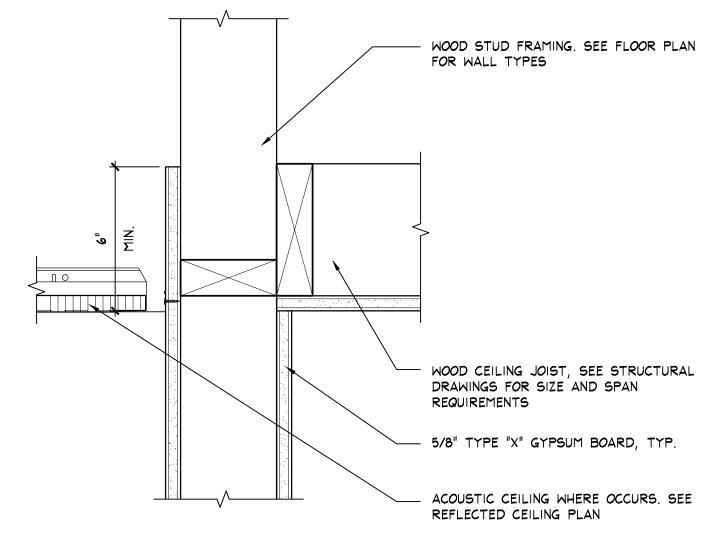

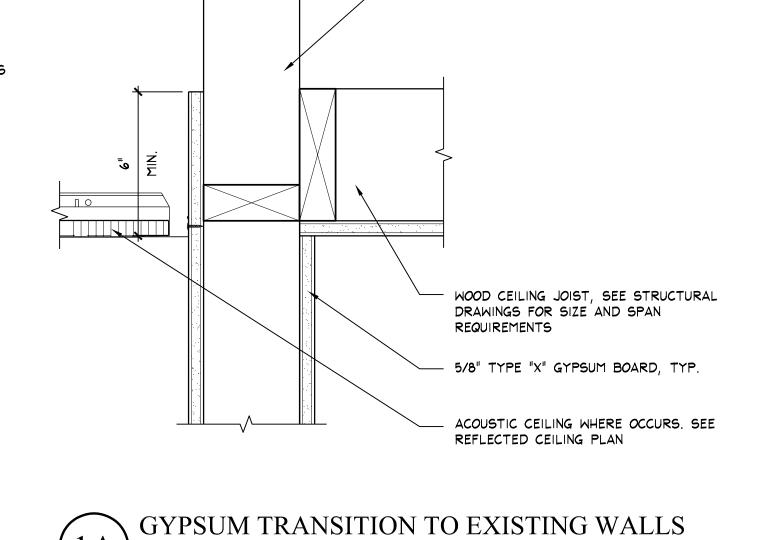

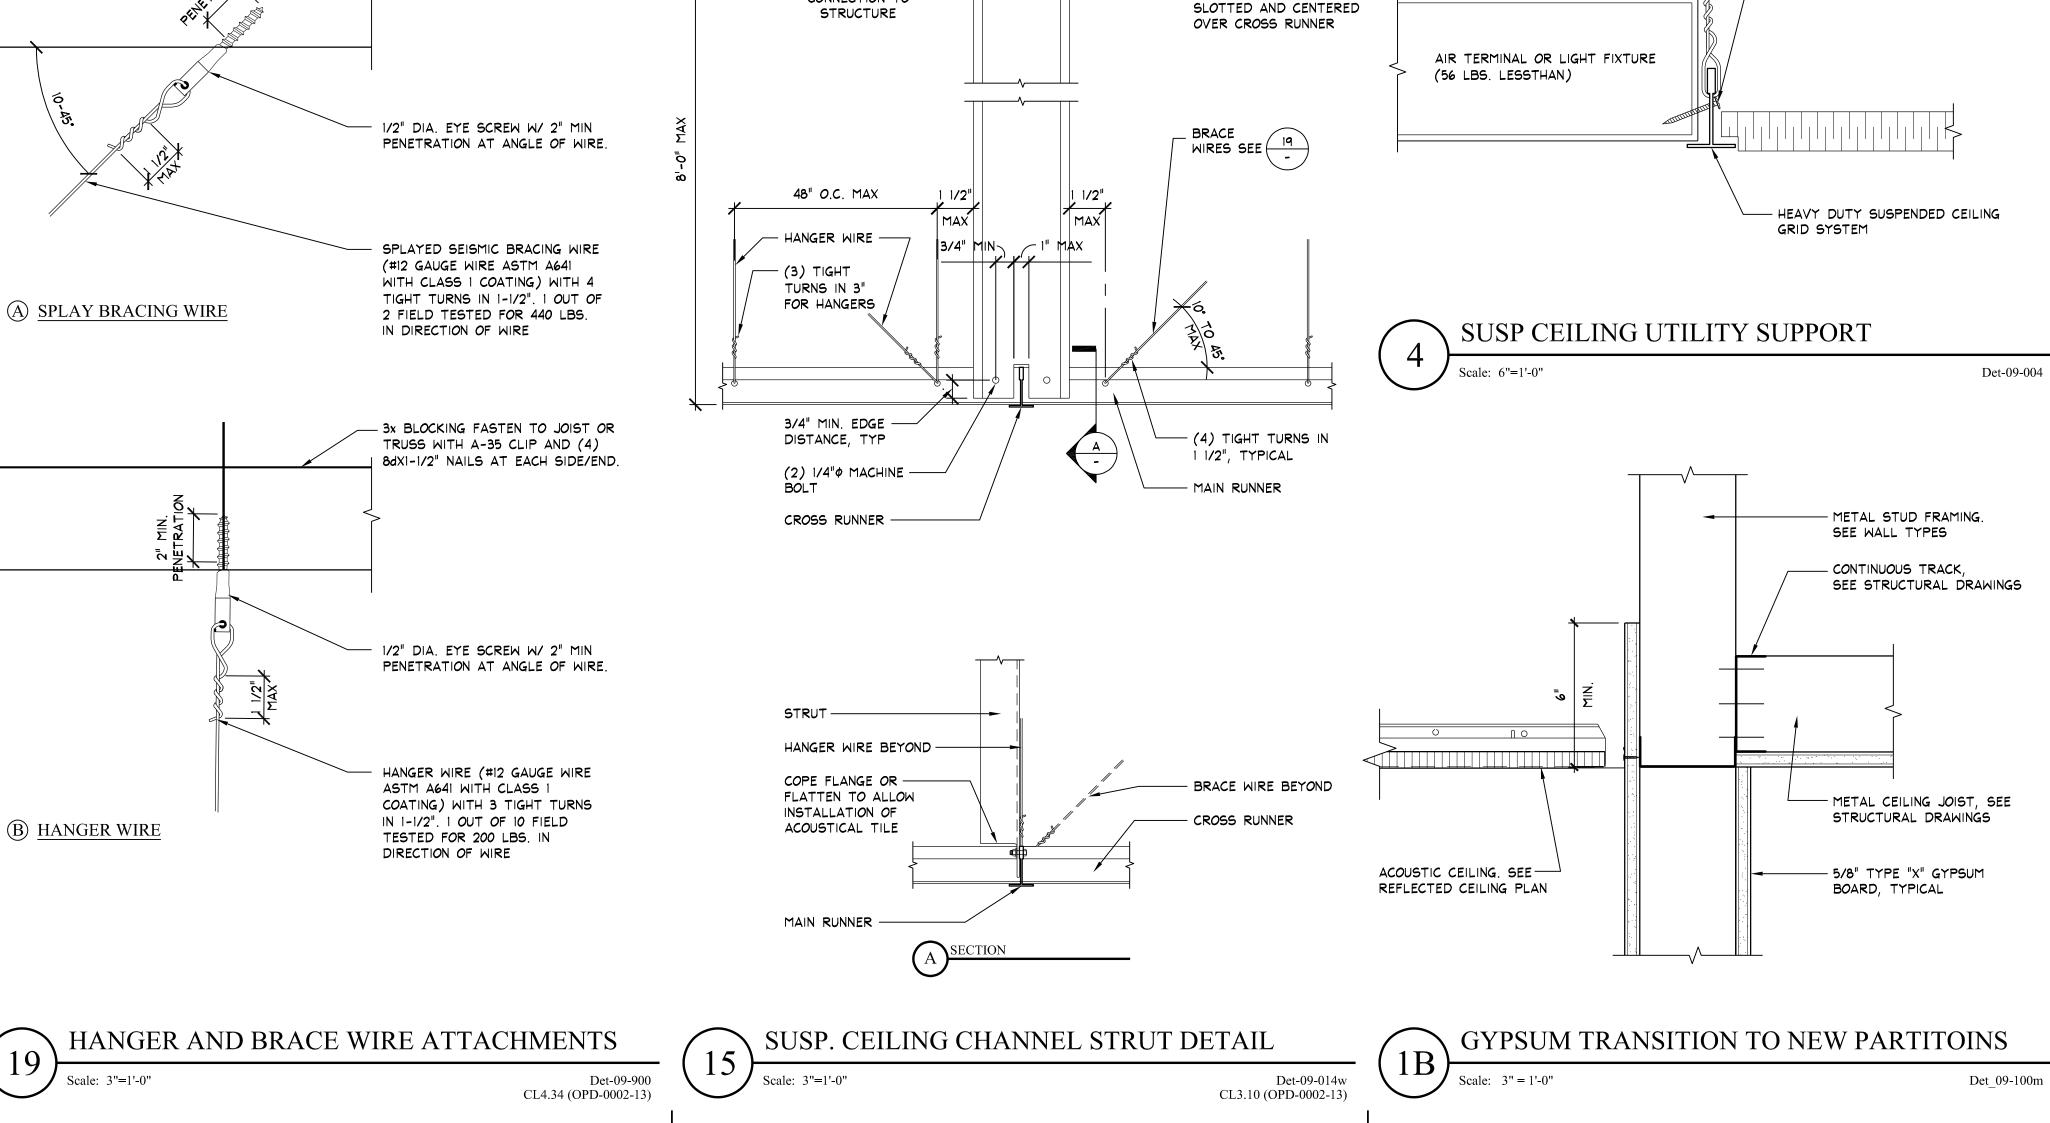

CONNECTION TO

Det 09-100m

Det 09-100w



FIXTURES, DOES NOT EXCEED FOUR (4) PSF. HEAVIER SYSTEMS, AND THOSE SUPPORTING #12 GAGE (MIN) HANGER WIRES MAY BE USED FOR UP TO AND INCLUDING 4 FT. BY 4 FT. KELLY ARCHITECTURE & PLANNING 6528 LONETREE BOULEVARD | ROCKLIN, CA 95765

Client:

CONNECTED TO THE ADJACENT WALL, PROVIDE INTERCONNECTION BETWEEN THE RUNNERS AT THE FREE END TO PREVENT LATERAL SPREADING. A METAL STRUT OR A #16 GAGE WIRE WITH

PERPENDICULAR DISTANCE FROM THE WALL TO THE FIRST PARALLEL RUNNER IS 8 INCHES OR LESS, THIS INTERLOCK IS NOT REQUIRED. 2145 Fifth Avenue PROVIDE BRACING ASSEMBLIES CONSISTING OF A COMPRESSION STRUT AND FOUR (4) #12 GAGE SPLAYED BRACING WIRES ORIENTED 90 DEGREES FROM EACH OTHER FOR ESSENTIAL

SERVICES BUILDINGS, PLACE BRACING ASSEMBLIES NOT MORE THAN 8 FT. BY 12 FT. ON A. PROVIDE BRACING ASSEMBLIES AT LOCATIONS NOT MORE THAN ONE HALF (1/2) THE

LATERAL LOADS FROM PARTITIONS, WILL REQUIRE SPECIAL DESIGN DETAILS.

PROVIDE #12 GAGE HANGER WIRES AT THE ENDS OF ALL MAIN AND CROSS RUNNERS WITHIN

THE END TEE, WHICHEVER IS LEAST, FOR THE PERIMETER OF THE CEILING AREA. PERIMETER

TYPICAL HANGER SPACING. PROVIDE ADDITIONAL HANGERS, STRUTS OR BRACES AS REQUIRED

AT ALL CEILING BREAKS, SOFFITS OR DISCONTINUOUS AREAS. HANGER WIRES THAT ARE MORE

CEILING GRID MEMBERS MAY BE ATTACHED TO NOT MORE THAT TWO (2) ADJACENT WALLS.

DIAGONALLY TO CEILING GRID SYSTEM RUNNERS, ONE END OF MAIN AND CROSS RUNNERS

6. AT THE PERIMETER OF THE CEILING AREA WHERE MAIN OR CROSS RUNNERS ARE NOT

A POSITIVE MECHANICAL CONNECTION TO THE RUNNER MA BE USED. WHERE THE

CEILING GRID MEMBERS SHALL BE AT LEAST 3/4 INCH CLEAR OF OTHER WALLS. IF WALLS RUN

EIGHT (8) INCHES OF THE SUPPORT OR WITHIN ONE-FOURTH (1/4) OF THE LENGTH OF

PROVIDE TRAPEZE OR OTHER SUPPLEMENTARY SUPPORT MEMBERS AT OBSTRUCTION TO

GRID SPACING AND SHALL BE ATTACHED TO MAIN RUNNERS.

WIRES ARE NOT REQUIRED WHEN LENGTH OF END TEE IS 8" OR LESS

THAN I IN 6 OUT OF PLUMB ARE TO HAVE COUNTER-SLOPING WIRES.

SHOULD BE FREE, AND A MINIMUM OF 3/4 INCH CLEAR OF WALL.

CEILING LATERAL FORCES

- SPACING GIVEN ABOVE, FROM EACH PERIMETER WALL AND AT THE EDGE OF VERTICAL CEILING OFFSETS.
- C. PROVIDE BRACING ASSEMBLIES AT LOCATIONS NOT MORE THAN ONE HALF (1/2) THE SPACING GIVEN ABOVE, FROM EACH PERIMETER WALL AND AT THE EDGE OF VERTICAL CEILING OFFSETS.
- D. THE SLOPE OF THESE WIRES SHALL NOT EXCEED 45 DEGREES FROM THE PLANE OF THE CEILING AND SHALL BE TAUT. SPLICES IN BRACING WIRES ARE NOT TO BE PERMITTED. F. EXCEPTION: LATERAL FORCE BRACING MAY BE OMITTED IN ROOMS WITH FLOOR AREAS LESS THAN 144 SQUARE FEET WHEN PERIMETER SUPPORT IS IN ACCORDANCE WITH ASTM E580 SECTIONS 5.22 AND 5.2.3 AND PERIMETER WALLS ARE DESIGNED TO CARRY THE
- 8. FASTEN HANGER WIRES WITH NOT LESS THAN THREE (3) TIGHT TURNS. FASTEN BRACING WIRES WITH FOUR (4) TIGHT TURNS. MAKE ALL TIGHT TURNS WITHIN A DISTANCE OF 1-1/2 INCHES. HANGER OR BRACING WIRE ANCHORS TO THE STRUCTURE SHOULD BE IN STALLED IN SUCH A MANNER THAT THE DIRECTION OF THE ANCHOR ALIGNS AS CLOSELY AS POSSIBLE WITH THE DIRECTION OF THE WIRE.
- SEPARATE ALL CEILING HANGER AND BRACING WIRES AT LEAST SIX (6) INCHES FROM ALL UNBRACED DUCTS, PIPES, CONDUIT, ETC.
- 10. WHEN DRILLED-IN CONCRETE ANCHORS OR SHOT-IN ANCHORS ARE USED IN REINFORCED CONCRETE FOR HANGER WIRES, I OUT OF 10 MUST BE FIELD TESTED FOR 200 LBS. IN TENSION. WHEN DRILLED-IN CONCRETE ANCHORS ARE USED FOR BRACING WIRES, 1 OUT OF 2 MUST BE FIELD TESTED FOR 440 LBS. IN TENSION. SHOT-IN ANCHORS IN CONCRETE ARE NOT PERMITTED FOR BRACING WIRES.
- II. ATTACH ALL LIGHT FIXTURES AND CEILING MOUNTED AIR TERMINALS, TO THE CEILING GRID RUNNERS TO RESIST A HORIZONTAL FORCE EQUAL TO THE WEIGHT OF THE FIXTURES. SCREWS OR APPROVED FASTENERS ARE REQUIRED.
- 12. FLUSH OR RECESSED LIGHT FIXTURES AND AIR TERMINALS, WEIGHING LESS THAN 56 LBS. MAY BE SUPPORTED DIRECTLY ON THE RUNNERS OF A HEAVY DUTY GRID SYSTEM BUT, IN ADDITION, THEY MUST HAVE A MINIMUM OF TWO (2) @12 GAGE SLACK SAFETY WIRES ATTACHED TO THE FIXTURE AT DIAGONAL CORNERS AND ANCHORED TO THE STRUCTURE ABOVE. ALL 4 FT. X 4 FT. LIGHT FIXTURES MUST HAVE SLACK SAFETY WIRES AT EACH CORNER.
- 13. ALL FLUSH OR RECESSED LIGHT FIXTURES AND AIR TERMINALS WEIGHING 56 LBS. OR MORE MUST BE INDEPENDENTLY SUPPORTED BY NOT LESS THAN FOUR (4) TAUT #12 GAGE WIRES, EACH ATTACHED TO THE FIXTURE AND TO THE STRUCTURE ABOVE REGARDLESS OF THE TYPE OF CEILING GRID SYSTEM USED. THE FOUR (4) TAUT #12 GAGE WIRES, INCLUDING THEIR ATTACHMENT TO THE STRUCTURE ABOVE, MUST BE CAPABLE OF SUPPORTING FOUR (4) TIMES THE WEIGHT OF THE UNIT.
- 14. SUPPORT SURFACE MOUNTED LIGHT FIXTURES BY AT LEAST TWO POSITIVE DEVICES WITH SURROUND THE CEILING RUNNER AND WHICH ARE EACH SUPPORTED FROM THE STRUCTURE ABOVE BY A #12 GAGE WIRE. SPRING CLIPS OR CLAMPS THAT CONNECT ONLY TO THE RUNNER ARE NOT ACCEPTABLE. PROVIDE ADDITION SUPPORTS WHEN LIGHT FIXTURES ARE 8 F. OR LONGER.
- 15. FOR FREE-STANDING BASE CABINETS NOT TO EXCEED 36" HIGH AND 36" DEEP: ANCHOR EACH FACE WITH A CONTINUOUS 16 GA BENT PLATE 2-1/2" X 2-1/2" WITH 3/8" DIA. SIMPSON STRONG BOLT 2 (OR EQUAL) WITH A MINIMUM 2" EMBEDMENT, 2" FROM EACH END AND 11" OC AND FOR THE ENDS, 13.5" OC FOR 24" DEEP CABINETS AND 25.5" OC FOR 36" DEEP CABINETS

P. 916.797.1199 | www.kellyarch.com

TRIBAL HEALTH

Oroville, CA 95965

Project Name: Feather River Tribal Health Center -Pharmacy Addition

Construction

and Remodel



Consultant

Revisions Description DATE REVISION NAME

Permit No.:

Approvals

Key Plan

KAP Job No. 463.01 Scale: As Noted Date: December 2022 Drawn By: YW


Checked By: ML

CEILING DETAILS

Sheet Number

Sheet Name

A10.3

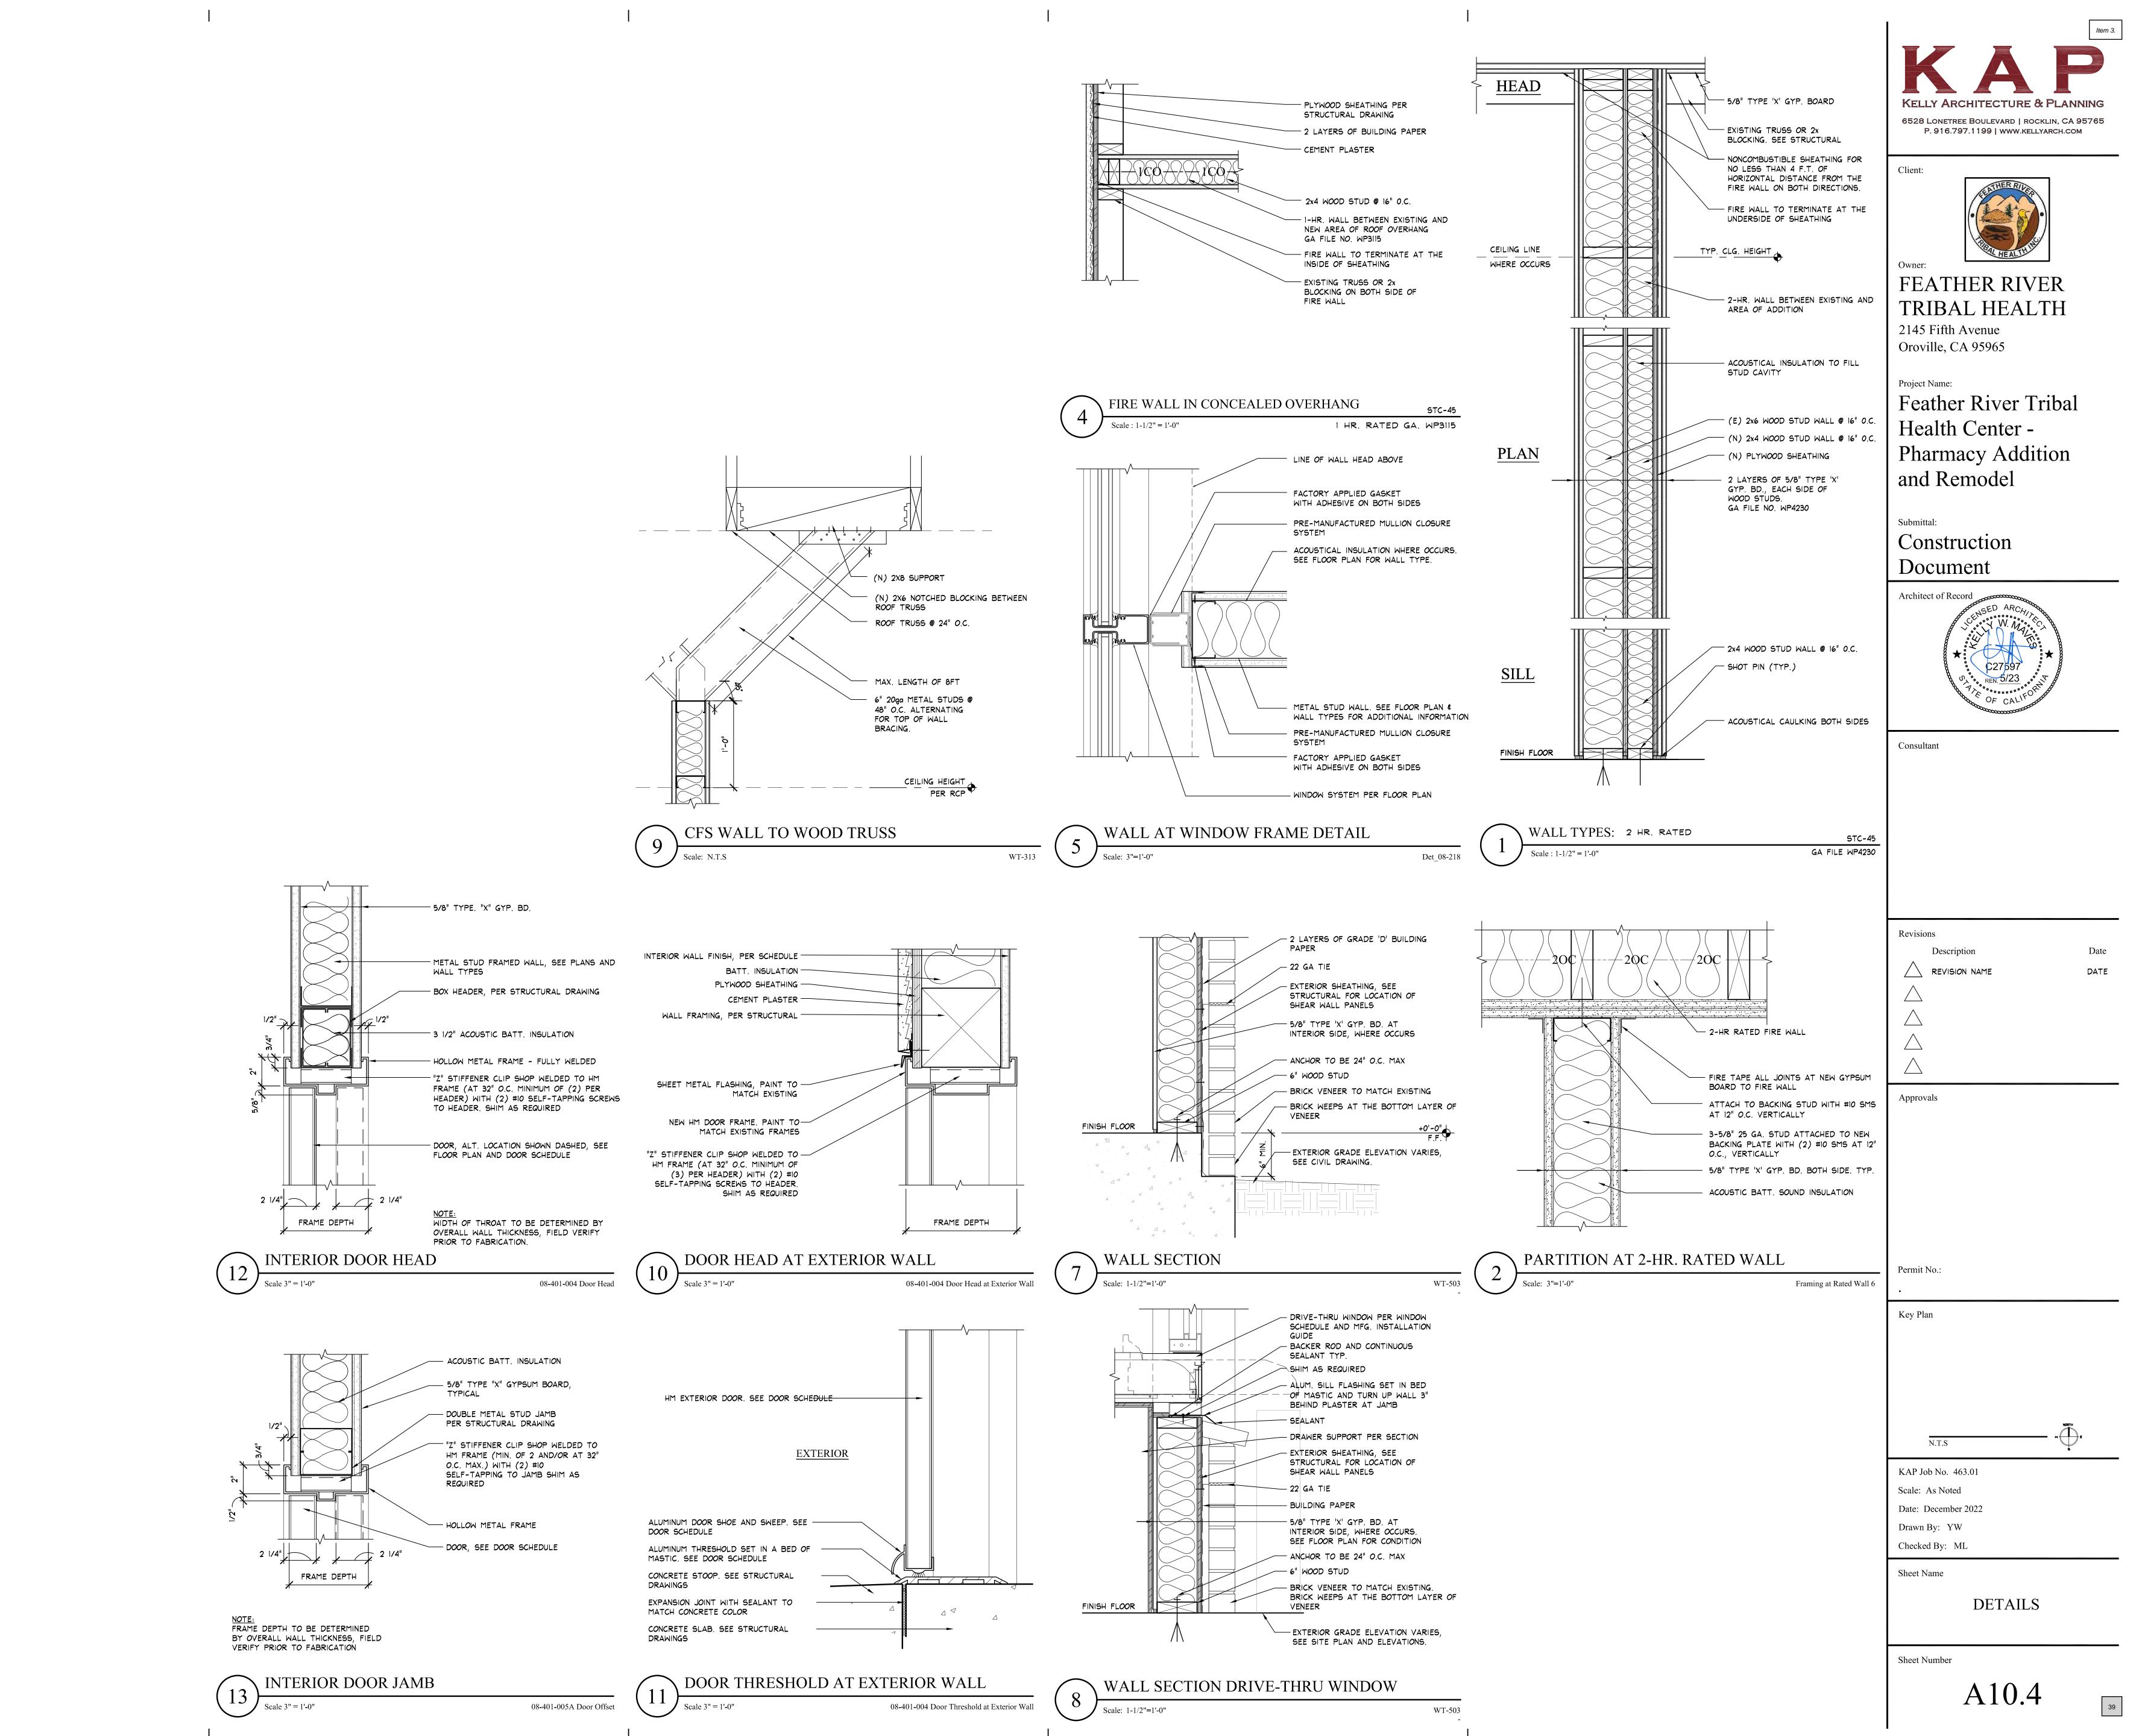

#### XIII. Wood Truss Notes:

Uniform Roof Design Loads For Trusses:

Top Chord 10 psf Dead Load 20 psf Live Load

10 psf DL **Bottom Chord** 0 psf (non concurrent Live Load)

- 1. Design and fabrication shall conform to the 2019 CBC.
- 2. Truss chords shall be Douglas fir No. 2. Truss Web shall be Douglas fir std or better.
- 3. 2x4 top chords typical 2x4 all other members UNO.
- 4. Plate material shall be ASTM A-446 Grade A or better.

5. Allowable stress increase for load duration shall be:

**Roof Snow** Floor Live

for web members.

- 6. Design and construction of connections shall be in accordance with published approval of ICC. Heel joint design shall consider the effects of eccentric loading in accordance with the Truss Plate Institute (TPI). Calculations for girder trusses shall include point loads from carried truss reactions.
- 7. Truss designer shall oversize plates for chord members to account for wood defects like knots, knot holes and greatly distorted grains. Maximum allowable defect size per member shall be 2 square inches. Not defects allowed under plates
- 8. Truss drawings, calculations and the latest ICC approved test data for truss metal plate connectors shall be submitted to the Architect and/or Structural Engineer for review prior to submittal to the Building Department. Any review comments made by the Architect/Structural Engineer shall be addressed prior to submittal to the Building Department for final review. Do not begin fabrication until Building Department has approved calculations and shop drawings.
- 9. Calculations shall be signed by a Civil or Structural Engineer registered in the State of California. It shall be the responsibility of the manufacturer to obtain Building Department approval prior to fabrication.
- 10. General contractor to provide temporary erection bracing and web bracing as required by truss manufacturer's design.
- 11. Built up girder trusses shall be laminated using 1/2 inch diameter bolts at 24"o.c. maximum through all members.
- 12. Gable end trusses shall have 2x verticals at 16" o.c. designed to resist out-of-plane wind loads typical unless noted otherwise.
- 13. Sheathed trusses over shear walls shall have 2x verticals at 16" o.c. typical unless noted otherwise. 14. Truss manufacturer to verify all dimension shown on Structural drawings with
- Architectural drawings and in field with wall layout prior to fabrication. Provide shop drawings. Include plan drawings showing truss locations and truss profiles with dimensions reviewed and approved by General Contractor
- 15. Truss designer to account for the weight of all mechanical equipment in the design of all trusses which support such units. See Mechanical drawings for weights and details.
- 16. Truss designer shall incorporate one 100# (50# DL & 50# non-concurrent LL) vertical load on the bottom chord of all trusses from one sprinkler line. Truss must be designed to carry the load at any point.
- 17. Fire sprinkler installer shall use connectors with ICC approval.
- 18. See Plumbing drawings for piping to be supported by roof trusses.
- 19. Structural design of beams, posts and foundations supporting roof trusses have been based on framing configuration shown of plans. Deviation to the framing configuration shown will require additional design coordination and potential revisions to framing and foundations. Any required revision to these drawings will be performed on a time and materials basis and will be charged to the Contractor.
- 20. Truss manufacturer shall provide truss to truss and truss to structure hanger connections as required. All connections shall be designed and details by truss manufacturer. See General Note sheet for material grades used.
- 21. Truss manufacturer shall design and detail all connections required to maintain the stability of the trusses for all loading conditions.
- 22. Trusses exposed to moisture to be sealed to prevent decay.

### **XIV. Abbreviations:**

ADDNL	ADDITIONAL	GC	GENERAL CONTRACTOR
AB	ANCHOR BOLT	GLB	GLU-LAM BEAM
ARCH	ARCHITECTURAL	HA	HEADED ANCHOR
ATR	ALL THREAD ROD	Н	HIGH
BETW	BETWEEN	HSB	HIGH STRENGTH BOLT
BEV	BEVELLED	HSS	HOLLOW STRUCTURAL STEEL
BLKG	WOOD BLOCKING	HORIZ	HORIZONTAL
BM	BEAM	LLH	LONG LEG HORIZONTAL
BOT	воттом	LLV	LONG LEG VERTICAL
BRG	BEARING	LS	LAG SCREW
CLR	CLEAR	MANUF	MANUFACTURER
CL	CENTERLINE	MAX	MAXIMUM
OC	ON CENTER	MB	MACHINE BOLT
CMU	CONCRETE MASONRY UNIT	MECH	MECHANICAL
COL	COLUMN	MFRD	MANUFACTURED
CONC	CONCRETE	MIN	MINIMUM
CONSTR JT	CONSTRUCTION JOINT	(N)	NEW
CONT	CONTINUOUS	NTS	NOT TO SCALE
CJ	CONTROL JOINT	OC	ON CENTER
db	BAR DIAMETER	ОН	OPPOSITE HAND
DIA	DIAMETER	OPNG	OPENING
DIM	DIMENSION	PL	PLATE
DN	DOWN	PMSMF	PRE MFD SPECIAL MOMENT FRAME
DO	DITTO (REPEAT)	RDWD	REDWOOD
DT	DRAG TRUSS	REQD	REQUIRED
(E)	EXISTING		REQUIREMENTS
EA	EACH	SST	SIMPSON STRONG-TIE
EE	EACH END	SAD	SEE ARCHITECTURAL DWGS
EF	EACH FACE	SIM	SIMILAR
EJ	EXPANSION JOINT	SOG	SLAB ON GRADE
EL (ELEV)	ELEVATION	SHTG	APA RATED SHEATHING
EWEF	EACH WAY EACH FACE	SSDS	STANLESS STEEL DECK SCREW
EQ	EQUAL	STGR	STAGGERED
EQUIP	EQUIPMENT	STIFF	STIFFENER
EN	EDGE NAILING	SQ	SQUARE
ES	EDGE SCREW	SYMM	SYMMETRICAL
EW	EACH WAY	T&B	TOP AND BOTTOM
FB	FACE OF BLOCK	TOC	TOP OF CONCRETE
FC	FACE OF CONCRETE	TOF	TOP OF FTG, TOP OF FRMG
FD	FLOOR DRAIN	TOS	TOP OF STEEL
FOF	FACE OF FRAMING	TOW	TOP OF WALL
FF	FINISHED FLOOR	TYP	TYPICAL
FG	FINISHED GRADE	UNO	UNLESS NOTED OTHERWISE
FOM	FACE OF MASONRY	VERT	VERTICAL
FOS	FACE OF STUD	VIF	VERIFY IN FIELD
FN	FIELD NAILING	W	WIDE
FTG	FOOTING	WP	WORKING POINT
GA	GAGE	WBS	WEB STIFFENER
		WS	WOOD SCREW
GALV	GALVANIZED	\/\/ <b>&gt;</b>	W()()()() \( \text{REW}

#### XI. Wood Notes:

- 1. All structural wood shall conform with the following specifications UNO: Douglas Fir - Coast Region - WCLIB grading rules #17. For timber 3x and larger, no more than 20% of the cross section shall
  - include heart centers. Redwood - California Redwood, RIS. Glued Laminated Beams - Standard Spec. for Structural Glued Laminated Timber AITC 117. Submit Shop Drawings prior to
  - fabrication of glued laminated members. Use Architectural appearance grade for exposed beams and coat with a clear exterior grade sealer.
  - Simple span beams shall be combination 24F-V4 UNO. Continuous spans and cantilevers shall be combination 24F-V8. **Engineered Lumber**
  - Timberstrand laminated strand lumber (LSL) ICC Report ESR-1387. Paralam parallel strand lumber (PSL) - ICC Report ESR-1387. Microlam laminated veneer lumber (LVL) - ICC Report ESR-1387. Sheathing - US Product Standard PS 1-95 and PS 2-92. Struct 1 APA rated sheathing w/ exterior glue at walls, floors, & roof uno Pressure Treated Douglas Fir - Standard Specifications Ground
- Contact DN, by AWPB. 2. All wood in direct contact with earth or concrete shall be pressure treated, except ledgers, which do not need to be pressure treated.
- 3. Field cuts and bolt holes in pressure treated wood shall be protected in accordance with AWPA standard M4. 4. Bearing and shear walls shall have double top plates, lapped at wall and
- partition intersection with (3) 16d nails. Splice upper and lower plates as in "Typical Stud Wall & Opening Framing Detail" on Typical Detail Sheet
- Provide solid blocking between joists and raters at all supports.
- 6. Provide blocking at all ceiling levels. 7. Joists under and parallel to partitions shall be doubled and nailed
- 8. The moisture content of 2x material at time of delivery shall be less than 19%. The moisture content of lumber 3x and larger at time of delivery shall be less than 30%.
- 9. Holes for bolts in wood shall be bored with a bit of the same nominal diameter as the bolt plus 1/16".
- 10. Holes for lag screws shall be first bored into the same diameter and depth as the unthreaded shank, and the rest to 50% of the shank
- 11. Lag screws and wood screws shall be screwed and not driven into place.
- Soap may be used to lubricate screws. 12. All bolts and lag screws shall be provided with metal washers under heads and nuts which bear on wood. Applies also to inserted expanding fasteners. Red Head, etc.
- 13. All bolts and lag screws shall be tightened on installation and retightened before closing in or at completion of the job.
- 14. No upset threaded bolts allowed.
- 15. Lay all structural sheathing on roof and floors with long dimension perpendicular to supports unless noted otherwise.
- 16. Block sheathing joints with 2 x 4 flat blocking where noted on roof or floor framing plans and with blocking same size at studs at walls. Use
- plyclips at midspan of unsupported roof sheathing edges. 17. Framing hardware shown on the plans is Simpson Strong - Tie. Use framing hardware as manufactured by Simpson Company or Equivalent.
- Prior to installation of any non-Simpson hardware, the contractor shall submit a list of all detail references where a hardware substitution is proposed, the designation for the Simpson item and non-Simpson proposed equivalent and an ICC report for each substitution item.
- 18. Provide Simpson Strong Tie LU hangers at joists and HU hangers at sloped or skewed joists and beams, UNO. Provide Maximum hanger depth and nailing, UNO.
- 19. Notify Structural Engineer after wall, floor, and roof shtg nailing has been completed and a minimum of 48 hours prior to concealing shtg.
- 20. Use of machine nailing is subject to a satisfactory job site demonstration for each project and approved by the project Architect or Structural Engineer and the governing agency. The approval is subject to continued satisfactory performance. Machine nailing will not be approved in 5/16" sheathing. If nail heads penetrate the outer ply by more than would be normal for a hammer or if minimum allowable edge distances are not maintained, the performance will be deemed unsatisfactory.
- 21. All nails shall be common wire full round head nails. 16d sinker nails may be substituted for 16d common nails at rough 2x framing UNO. Pneumatically driven nails meeting size requirements are acceptable. Nail must not be overdriven. All nailing not noted or detailed otherwise shall be per 13|S1.2. Nail length to be sufficient to meet CBC penetration requirements. Nails into pressure treated material to be galvanized.

### XII. Cold-Formed Steel:

- 1. All Structural Cold-Formed steel framing members, including but not limited to studs, tracks, bridging, joists and bracing of the type shown on the plans and specifications shall be based on the Steel Stud Manufactures Associations product technical information publication and ICC Reports.
- 2. All 43 mils and lighter components shall be made from steel having a minimum 33,000 psi yield strength conforming to ASTM A-446 Grade A or ASTM A-653 Grade 33. All 54 mils through 97 mils components shall be made from steel having a minimum 50,000 psi yield strength conforming to ASTM A-446 Grade D or ASTM A-653 Grade 50 Class 1
- 3. Cold-Formed sections shall be galvanized per ASTM A-525.
- 4. Structural Cold-Formed framing components shall be squarely cut or as required to fit neatly against abutting members.
- 5. Studs shall be seated squarely in the tracks with the stud flanges abutting the base of the track web. Both stud flanges at each end shall be securely attached by welding or screwing to the flanges of a track or other means to restrain rotation and horizontal displacement. The distance to web cutouts and the end of the stud shall not be less than 10 inches unless a web stiffener has been approved. Studs with sheathing on one or neither sides requires bridging to provide rotational restraint at 12 ft. on center unless detailed otherwise. Only manufacturer web cut-outs are allowed, no other web or flange holes are permitted without prior approval.
- 6. Tracks shall be of the same gauge as the studs unless noted otherwise. 7. Each stud or ceiling member, not in ICC Report ER-4943P, shall be identified by the Manufacturer Name, Yield Strength if over 33,000 psi, minimum base metal thickness and the report number embossed
- 8. Screws used for Cold-Formed steel connections shall be #10 SMS
- 9. All Metal Stud components to be per SSMA Product Technical Guide (ICC ESR-3064P).

on stamped on the web of each section at a maximum of 48 inches on

#### VIII. Structural Steel:

- Structural steel shall be fabricated and erected in accordance with the latest editions of AISC specifications for structural steel buildings and code of standard practice for steel buildings and bridges.
- 2. Welding shall be done by a process approved by the engineer and the
- building department. Welders shall be certified. 3. A sequence of field welding shall be planned to minimize locked-in
- stresses distortion
- 4. Welding shall conform to AWS D1.1 latest edition.
- 5. Electrodes: AWSD 1.1 E70xx series as required for intended use. 6. Lengths of welds shown are effective lengths as specified in AWS D1.1
- where length of weld is not shown it shall be full length of joint. All butt welds shall be full penetration unless noted otherwise. Where minimum AISC fillet weld thickness requirements exceed welds
- on details, provide minimum AISC weld.
- All welding shall be performed in accordance with CBC 1704.3.1.
- 9. Holes for bolts shall be the same nominal diameter of the bolt plus 1/16" unless noted otherwise. Use standard AISC gage and pitch for bolts except as noted otherwise.
- 10. Holes for anchor bolts embedded in concrete shall be the same nominal diameter of the bolt plus 5/16" unless noted otherwise.
- 11. After fabrication all steel shall be cleaned free of rust, loose mill scale and oil and given one shop coat of rust inhibitive primer. After erection, all welds, high-strength bolts, and damaged areas shall be given a field touch-up coat of the primer used for the shop coat. Omit paint on part of steel to be embedded in concrete or field welded.
- 12. Metal decking shall be per plans manufactured by ASC Steel Deck per ICC ESR-2408
- 13. Fabrication, erection and materials shall conform with the AISC Specifications and the 2019 CBC.
- 14. Holes for bolts shall be same diameter as bolt plus 1/16"
- 15. Use standard AISC gage and pitch for bolts except as noted. 16. All interior steel & hardware to be primed & painted.
- 17. Exposed steel must be primed & painted for exterior freeze/thaw conditions. Color is per Architect, minimum requirements are as noted below unless otherwise approved by Architect and Owner: a. Primer: Tnemec 94-H20 installed to 2.5 to 3.5 mils dft. Clean steel per SP6/NACE3 prior to application.

b. Paint: Tnemec 1075 @ 3.0 to 4.0 mils dft.

### IX. Reinforcing Steel:

- 1. All reinforcing steel shall conform to ASTM A615 Grade 60 for #4 & larger and Grade 40 for #3 & smaller UNO. Reinforcing to be welded shall conform to ASTM A706.
- Welded wire fabric shall conform to ASTM A185. Minimum lap at splices shall be 12 inches.
- 3. All concrete shall be reinforced unless specifically noted "not reinforced" in the drawings. If reinforcing bars are not shown or noted. Provide same reinforcement as for similar conditions elsewhere in the work, or as directed by the architect/engineer.
- 4. Reinforcement bars shall not be spliced except as detailed and located on
- 5. Anchor bolts, dowels and other embedded items shall be accurately set in place before concrete is poured.
- 6. Reinforcement bars shall be accurately placed and firmly supported. Using ties and support bars in addition to reinforcement shown where firm and accurate placing is necessary as specified in the ACI standards. Dowels should be provided to match all reinforcement at construction joints unless otherwise noted.
- No reinforcement welding shall be done unless shown on the drawings or approved by the engineer (tack welding included). Welding of reinforcement is only permitted for reinforcing steel having a carbon
- equivalent less than 0.65% according to AWS D1.4 specifications. 8. All dimensions shown for location of reinforcing are to the face of bars and denote clear coverage unless otherwise noted.
- 9. Minimum concrete coverage of reinforcing steel shall be as follows unless otherwise noted on plans: Concrete cast against earth Formed concrete exposed to earth or weather:
  - #5 bar and smaller, post tension strands #6 - #18 bars Formed concrete not exposed to earth or weather: Bars in slabs and walls and joists #6 bars and smaller 1 ½" #7 - #18 bars 1½" Bars in beams and columns

### X. Testing & Inspection:

- Test and inspection shall be provided by a qualified testing agency as required below and shall conform to the requirements of the 2019 CBC sections 1701, 1704 & 1705.3. PERIODIC INSPECTIONS:
- TESTS: ☐ Fill compaction ☐ Special grading, excavation & ☐ Reinforcing steel ☐ Pile/pier installation □ Concrete
- ☐ Structural steel □ Post Installed Anchors □ Masonry ☐ Grout & mortar
- CONTINUOUS INSPECTIONS: ☑ Epoxy & expansion anchors ☐ Shop welding penetration
- □Field welding penetration
- ☐ High strength bolting, bolts
- ☑ Reinforcement placement ☐ Concrete placement ☐ Shop welding uno □ Field welding uno ☐ High strength bolting uno ☐ Masonry placement & grouting ☐ Shear stud installation
- □ Shotcrete groove welds, fillet welds >5/16", SAnchor bolt size & placement ■ Roof, floor, & wall shtg nailing ≤4"OC
- ☐ Straps & framing connectors groove welds, fillet welds >5/16", DTop pl & ledger splice nailing
  - pretensioned w/ turn of nut or calibrated wrench method

#### V. General Notes:

- All materials and workmanship shall confirm to the drawings, General Notes and Specifications.
- 2. During the construction period the contractor shall be responsible for the safety of the structure. The contractor shall retain a registered Civil Engineer to design all temporary shoring, bracing and guys required during construction is accordance with all National, State and Local Safety Ordinances.
- All applicable requirements of the local Construction and General Industry Safety Orders, the Occupational Safety and Health Act and the Construction Safety Act shall be met.
- 4. All erection procedures shall conform to OSHA standards. Any deviation must be approved by OSHA prior to erection.
- The Contractor shall be solely responsible for all excavation procedures including lagging, shoring and protection of adjacent property, structures, streets and utilities in accordance with all National. State and Local Safety Ordinances.
- The Contractor shall be responsible for contacting all utility agencies as to the location of all underground facilities for the protection of and repair of damage to them. Call "Underground Service Alert" forty-eight hours before digging.
- 7. The Contractor shall be responsible for coordinating the work of all trades and shall check all dimensions. All discrepancies shall be called to the attention of the Architect and Structural Engineer and shall be resolved before proceeding with the work.
- 8. Shop drawings required by the specifications shall be submitted to the Structural Engineer for review prior to fabrication. 9. All details designed as Standard or Typical shall apply to all applicable
- conditions in addition to other specifically referenced detail and sections. 10. Drawings indicate General and Typical Details of Construction. Where conditions are not specifically indicated but are of similar character to details shown, similar detail of construction shall be used subject to
- review by the Engineer. 11. See Civil, Mechanical, Plumbing and Electrical drawings for size and location of all openings required for ducts, pipes and all pipe sleeves, electrical conduits and other items to be embedded in concrete or otherwise incorporated in structural works.
- 12. Architectural and Civil Plans are considered a part of the structural design drawings and are to be used to define detail configurations including, but not limited to relative location of members, elevations, location of all opening, etc.
- 13. All necessary permits, licenses, approvals, fees, notices, etc., shall be obtained prior to beginning construction.
- 14. No conduit, pipes or ducts shall be embedded into structural members unless so shown on the plans or approved by the Structural Engineer.
- 15. Refer to Architectural Plans for floor depressions, openings, slopes, drawing, curbs, pad, embedded items, non-bearing partitions, stair hangers, etc. Refer to Mechanical and Electrical Plans for sleeves, openings, and hangers for pipes, ducts and equipment.
- 16. Verify all dimensions and conditions on the job prior to construction

#### VI. Foundation:

- 1. The foundation design is based on minimum values from CBC 2019,
  - D + L Bearing Pressure = 1500 psf = 2000 psfD + L + Lateral
- 2. Unless otherwise indicated. Foundation work shall be performed in accordance with the geotechnical report and all applicable local codes.
- 3. Foundation excavations shall be examined by a soils engineer prior to placement of reinforcing steel or concrete.
- 4. Unexpected soil conditions: foundation design is based upon soil conditions normally encountered in work on lots suitable for construction of these types of structures. Where soil conditions are encountered that are suspect with regard to the suitability or capacity of soil to support the structure in the opinion of the contractor or building inspector, notify the architect in a timely fashion, the architect may then recommend to the owner employing the services of a geotechnical engineer to provide specific recommendations for further foundation preparation.
- Form footings as necessary.
- 6. Bottom of footing shall be stepped if necessary to provide level bearing. 7. Foundation excavations shall be cleaned of any loosened soils and

standing water before placing steel or concrete.

- 8. All foundation to bear on native or engineered fill compacted to 90% proctor dry density per ASTM D-1557.
- 9. Geotechnical Engineer shall review Foundation Plan & Site conditions during pier installation per Geotechnical Report.

- VII. Concrete: 1. All structural concrete unless otherwise noted shall have a density of 150 pcf aggregates shall conform to ASTM C33 with proven shrinkage
- characteristics of less than 0.05%. 2. All structural light weight concrete shall have a density of 115 pcf Maximum and 100 pcf minimum. Aggregates shall conform to ASTM
- 3. All concrete shall develop minimum compressive strengths at the end of
- 4. All cement shall conform to ASTM C150 type II.

5. Concrete mix designs shall be prepared by an independent laboratory and

- reviewed by the structural engineer Admixtures shall comply with ASTM C494 and be of a type that increases the workability of the concrete. But shall not be considered to reduce the specified minimum cement content (calcium chloride shall not be
- Placement of concrete shall be in conformance with the ACI 301. 8. Control joints shall be located formed as shown on the drawings. Slab control joints shall be placed at points of low stress as well as located to minimize effects of shrinkage. Key and dowel slab construction joints as shown on the plans. All construction joints shall be cleaned thoroughly and all laitance shall be removed from the surface. All vertical joints shall be thoroughly wetted and slushed with a coat of neat cement or bonding
- agent immediately before pouring new concrete. 9. Set floor screeds to required elevations during concrete pouring to compensate for form settlement.
- 10. Grout: pre-manufactured mix with minimum compressive strength at the end of 28 days of 5000 psi with minimum water consistent with placing
- 11. Air content: conform to ACI 301 section 4.2.2.4. Horizontal exterior surfaces in contact with the soil or the weather require entrained air. Tolerance is ±1-1/2 % air content shall be measured at point of

#### I. Intent Of Drawings:

- These structural plans address the renovation and addition to an existing medical clinic.
- Typical Details and General Notes on these drawings apply to new construction only except where specifically detailed or noted otherwise.
- Resolve any conflicts on the drawings with the Architects and Structural Engineer before proceeding with construction. Dimensions take precedence over scale of drawings. However, any significant conflicts should be resolved as noted above
- 4. These drawings represent the finished structure but do not indicate the means or methods or sequences of construction. The contractor is responsible for all temporary bracing, shoring and contractor is responsible for determining and enforcing all construction load limits on the structure.

#### **II. Design Criteria:**

Authority Having Jurisdiction & Risk Category

City of Oroville Commercial Risk Category Project Location Latitude degrees N 121.5626 Longitude degrees W Codes & Standards 2019 California Building Code CBC 2019 IBC 2018 2018 International Building Code Minimum Design Loads for Buildings and Other Structures ASCE 7-16 ACI 318-14 ACI Building Code Requirements for Structural Concrete NDS 2018 National Design Specifications for Wood Construction ASCE 7 Ch. 26 Wind Design Source Data

Basic Wind Speed 94 mph hazards.atcouncil.org Google Earth Exposure CBC Table 16-A Wind Importance Factor, Iw 1.0 Topographic Factor, Kzt Google Earth Seismic Design ASCE 7 Ch. 11 Value Source Data Soil Site Class **CBC Default** 0.628 Short a, Ss www.seismicmaps.org Long a, S1 0.271 www.seismicmaps.org Site Coeff., Fa 1.298 **CBC Default** 1.5 Site Coeff., Fv www.seismicmaps.org Short a, damped, Sds 0.543 1.00 ASCE 7 Ch. 12 Seismic Design Category

6.50

Light Framed Wood Wall

ASCE 7 Ch. 11

Source Data

ACI 318-19

ASCE 7

ASCE 7

#### **III. Structural Materials:** Concrete

Response Factor, R

LFRS Type

Roof Live(Reducible)

Design Loads

Concrete			710/310 13
ltem	f'c (psi)	w/c Ratio	Finish
Foundations	3,000	0.55	N/A
Slab on Grade	4,000	0.50	Patterned SAD
All Mixes Use Type II Cen	nent		
Reinforcing Steel			ACI 318-19
Item	Fy (ksi)	Reference	Finish
Standard Rebar	60	A 615	Black
Sawn Lumber			NDS 2018
Item	Species-Grade	Reference	Finish
2x & 4x Framing, Posts	DF No. 1		Std
Sills on Concrete	DF No. 2		PTDF
LVL	1.9E, Fb 2600 psi		Std
PSL	2.0E, Fb 2900 psi		Std
Fasteners into Untreated	Lumber	A F1667	Bright
Fasteners into Exterior Tr	eated Lumber	A B695	HDG
Connectors into Lumber		Simpson	G60 minimum
Hot Rolled Steel Frai	ming		AISC 360-16
ltem	Fy (ksi)	Reference	Finish
Shapes & Plates	36	A 36	Primer Std
Rectangular HSS	46	A 500 Gr. B	Primer Std
Machine Bolts	-	A 307	Primer Std
Anchor Bolts	36	F 1554 Gr. 36	HDG
Welding Electrodes	E70xx	AWS D1.1	Same as Base
Cold Formed Steel F	raming		SSMA
Item	Fy (ksi)	Reference	Finish
Studs & Tracks for Walls	50	ASTM C955	G90
CFS Box Section	50	ASTM C955	G90
18ga T (Track) Shapes	33	ESR-3064P	G90

### **IV. Structural Sheets:**

S6.1 ROOF FRAMING DETAILS

	S0.1	STRUCTURAL NOTES
	S1.1	TYPICAL CONCRETE DETAILS
	S1.2	TYPICAL FRAMING DETAILS
	S1.3	TYPICAL COLD FORMED STEEL DETAILS
	S1.4	TYPICAL COLD-FORMED STEEL DETAILS CONTINUED
	S1.5	TYPICAL STEEL FRAMING DETAILS
	S2.1	FOUNDATION PLAN
	S2.2	ROOF FRAMING PLAN
	S3.1	ELEVATION & SECTION
	S4.1	FOUNDATION DETAILS
	S5.1	STEEL FRAMING DETAILS
1		

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FEATHER RIVER TRIBAL HEALTH 2145 Fifth Avenue

Oroville, CA 95965

Project Name: Feather River Tribal Health Center -Pharmacy Addition

Construction Document

and Remodel

Architect of Record





✓ \ REVISION NAME DATE Approvals

Permit No.:

Key Plan

KAP Job No. 463.01 Scale: As Noted Date: 27 December 2022 Drawn By: ANR


Checked By: JMI


Sheet Name

STRUCTURAL NOTES

Sheet Number

SO.1

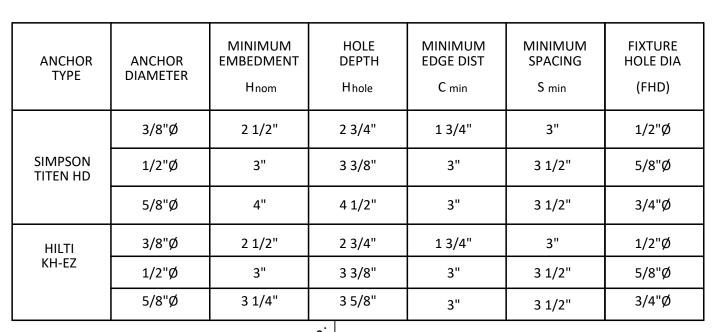

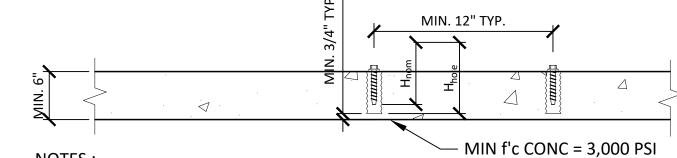


- 1. Install anchors per manufacturer's information and ICC Report instructions and in conformance with project details. 2. Acceptable anchors are: Simpson Titen HD, ICC ESR-2713 and Hilti KH-EZ, ICC
- ESR-3027 or approved equal. 3. Contractor to verify minimum edge distances, spacing and thickness are in
- accordance with details prior to installing anchor. 4. When drilling holes in existing concrete, use care and caution to avoid cutting or
- damaging the existing reinforcing bars. Maintain a reasonable clearance between reinforcement and the drilled-in anchor. CORE DRILLED HOLES NOT PERMITTED.
- 5. The special inspector must be on the job site continuously during anchor installation to verify anchor type, anchor dimensions, hole cleanliness, embedment depth, concrete type, concrete compressive strength, drill bit diameter, hole depth, edge distances(s), anchor spacing(s), concrete thickness, and full advancement of anchor.

%"ø

### **HD Screw Anchor To Conc**

	Sc	cale: NTS				
	SCREW	' ANCHOR IN M	IN 2,000 PSI S	SOLID GROUT	ED CMU	
ANCHOR MATERIAL	ANCHOR DIAMETER	NOMINAL (MIN) EMBEDMENT		GE ANCE	SPA	CING
		H <sub>nom</sub>	Ccrit	C <sub>min</sub>	Scrit	Smin
	⅓"ø	2½"	4"	11/4"	4"	2"
SIMPSON	¾"Ø	2¾"	12"	4"	6"	3"
CARBON STEEL	½"ø	3½"	12"	4"	8"	4"
JILL	%"ø	4½"	12"	4"	10"	5"
	¾"Ø	5½"	12"	4"	12"	6"
	¾"Ø	2¾"	12"	4"	8"	4"
SIMPSON STAINLESS	½"ø	3½"	12"	4"	8"	4"

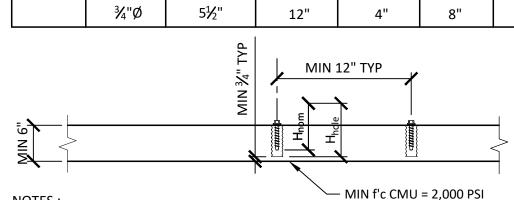


4½"

- 1. Install anchors per manufacturer's information and ICC Report instructions and in conformance with project details. Refer to ICC ESR-1056.
- 3. Contractor to verify minimum edge distances, spacing and thickness are in accordance with details prior to installing anchor.
- 4. When drilling holes in existing concrete, use care and caution to avoid cutting or damaging the existing reinforcing bars. Maintain a reasonable clearance between reinforcement and the drilled-in anchor. CORE DRILLED HOLES NOT PERMITTED. 5. GC to Verify FHD w/ diameter of anchor prior to construction.


### Screw Anchor In CMU

Scale: NTS

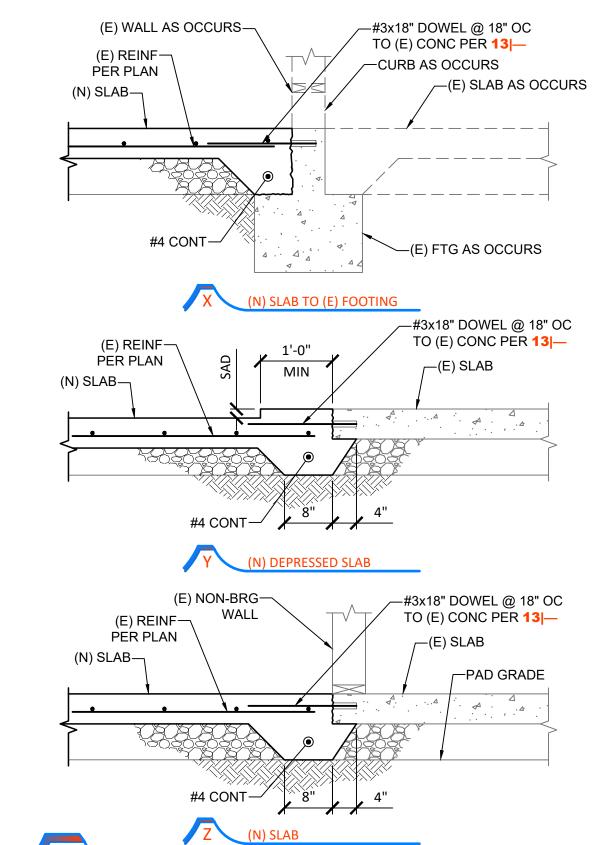

(N) Pipe to (E) Slab


Scale: 3/4" = 1'-0"

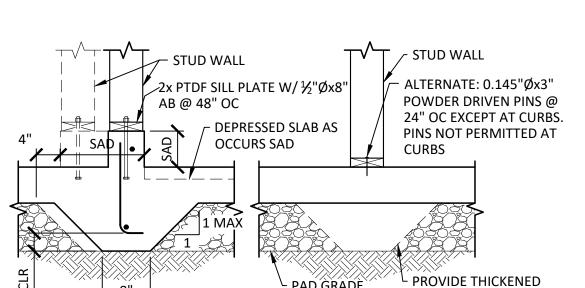

SEE 7 — OTHERWISE


SLAB WHERE AB'S ARE

# Scale: NTS = 1'-0"

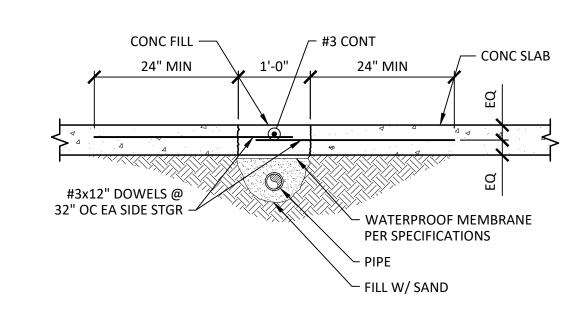


Scale: 3/4" =1'-0"

			ADHESIVE IN 2,500 PSI M			
ANCHOR TYPE	ANCHOR		MIN EMBED UNO	MIN EDGE DISTANCE	MIN SPACING	MIN CONC
ITPL	THRD ROD	RE BAR				
			H ef	C min	S min	h min
SIMPSON SET-XP	¾"Ø	#3	3"	1¾"	3"	47/8"
	½"ø	#4	3"	1¾"	3"	5½"
	%"Ø	#5	4"	1¾"	3"	71/8"
JLI XI	¾"Ø	#6	5"	1¾"	3"	83/4"
	%"ø	#7	6"	1¾"	3"	103/8"
	1"Ø	#8	7"	1¾"	3"	12"
	¾"Ø	#3	3"	17/8"	11/8"	41/4"
HILTI	½"ø	#4	3"	2½"	2½"	41/4"
IT-HY 200	%"ø	#5	4"	31/8"	31/8"	51/4"
	¾"Ø	#6	5"	3¾"	3¾"	6½"
	%"ø	#7	6"	43/8"	43/8"	7¾"
	1"Ø	#8	7"	5"	5"	9"

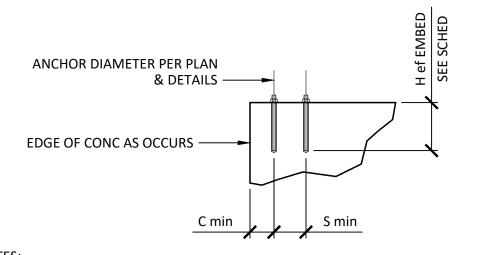


- 1. Install adhesive anchors per manufacturer's information and ICC Report. Special inspection is required per CBC and the requirements of the ICC reports. Acceptable adhesives are: Simpson SET-XP, ICC No. ESR-2508: Hilti HIT HY 200, ICC No. ESR-3187. An approved equal may be substituted unless specifically noted otherwise on drawings.
- Threaded rods to be A36, A307 Grade C threaded rod, or F1554 Grade 36 threaded rod. Rebar to be A615. Contractor to verify minimum edge distances, spacing and thickness are in
- accordance with schedule prior to installing anchor. Values are absolute minimums for installation. Capacity reduction may be required per CBC and ICC reports. When drilling holes in existing reinforced concrete, use care and caution to avoid cutting or damaging the existing reinforcing bars. Maintain a reasonable clearance between reinforcement and the drilled-in anchor. CORE DRILLED HOLES NOT
- 6. The special inspector must be on the jobsite continuously during anchor installation to verify anchor type, anchor dimensions, hole cleanliness, embedment depth, concrete type, concrete compressive strength, drill bit diameter, hole depth, edge distance(s), anchor spacing(s), concrete thickness, and adhesive injection.

# Adhesive Anchor In Concrete

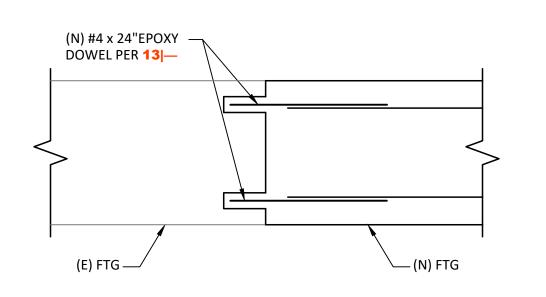

(N) Footing To (E) Footing

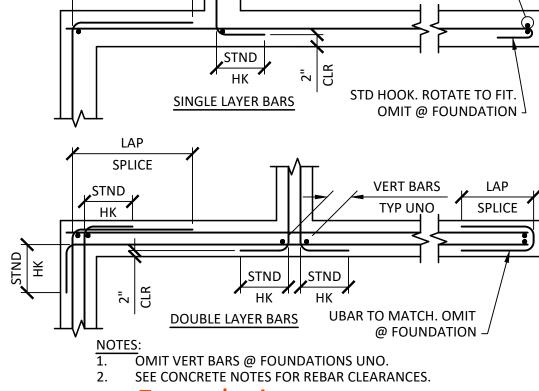

SPLICE

REINF CONT THRU

OR LAP PER 2|—

PLACEMENT OF CONC.

(N) STUD WALL — ►

2x PTDF SILL W/ -

OC (2 MIN)

STUD WITDH

#4 @ 16" OC (2 MIN) GROUT -

**EXCEPT EMBED AS NOTED** 

TO (E) CONC PER X

Scale: 3/4" = 1'-0"

KEY FORM BEVELED 2x4 -

SAWCUT AS SOON AS POSSIBLE WITHOUT

SPALLING, NO MORE THAN 4 HOURS AFTER

INITIAL SET OR PROVIDE PLASTIC CONTROL

JOINT. FILL JOINT W/ FLEXIBLE SEALANT

TYP SLAB ON GRADE

➤ TYP REINF CONT THRU

COMPOUND.

AT THICKENED SLAB PROVIDE JOINT PER A

Scale: NTS CONC SLAB ON GRADE, SEE PLAN

DOWEL TO MATCH

SLAB REINF'G ¬

Slab On Grade Joints

1'-6" MIN

1'-6" MIN

#4 CONT —

OPTIONAL CONSTRUCTION
JOINT
Depressed Slab

VAPOR BARRIER CONT, TYP

LAP SPLICE TYP

½"Øx16" ROD @ 18" OC

#4 CONT -

%"Øx8" AB'S @ 48"

(N) CURB TO MATCH —

LOCATION OF JOINTS TO BE SUBMITTED TO

ARCHITECT/ENGINEER FOR REVIEW PRIOR TO HOLDOWN POST, OR COL

**Footing Construction Joint** 

**ROUGHEN SURFACE** 

TO ¼" AMPLITUDE &

APPLY ONE COAT

**BONDING AGENT** 

(2) VERT BARS UNO -

– ROUGHEN JOINT BY SAND

KEY FROM BEVELED 2x8. DO


NOT LOCATE WITHIN 4'-0" OF

BLASTING TO EXPOSE

AGGREGATE TO ⅓"

AMPLITUDE

Foundation & Wall Reinforcing

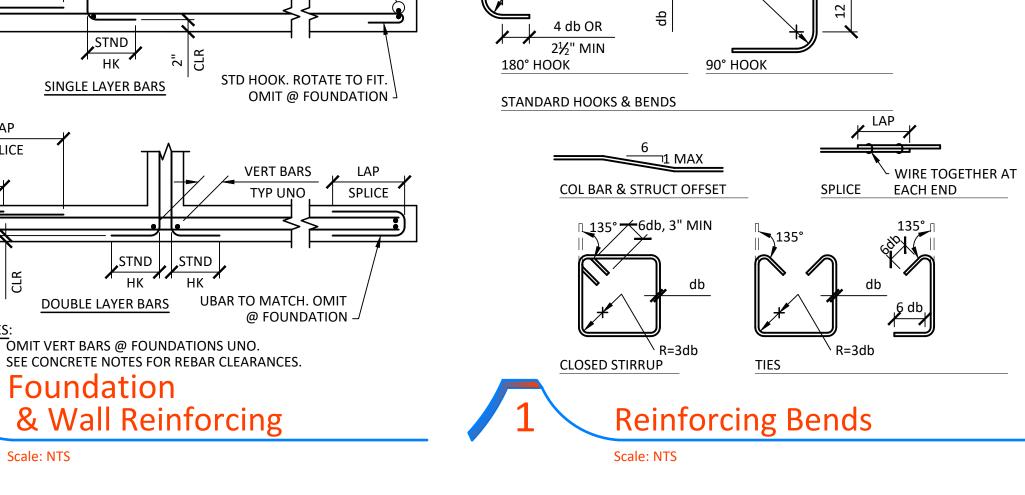

- R=3 db FOR #3 TO #8


R=4 db FOR #9 TO #11

MINIMUM BAR LAPS FOR REINFORCING STEEL CONCRETE STRENGTH: 3000 PSI OR GREATER SIZE LAP LENGTH SIZE LAP LENGTH SIZE LAP LENGTH #3 18" #6 46" #9 86" #4 24" #7 56" #10 102" #5 34" #8 70" #11 120" NOTES:


1. LAP LENGTH BASED ON CLASS B TOP BAR.

- MINIMUM BAR SPACING SHALL BE THE GREATER OF 4x BAR DIAMETER OR 4".
- AND END IN A STANDARD 90° OR 180° HOOK UNLESS DETAILED OTHERWISE.


#### STAGGER SPLICES WHERE POSSIBLE. ALL REINFORCING BARS SHALL EXTEND AS FAR AS POSSIBLE Document 5. INCREASE LAP LENGTH 30% FOR LIGHT-WEIGHT CONCRETE.

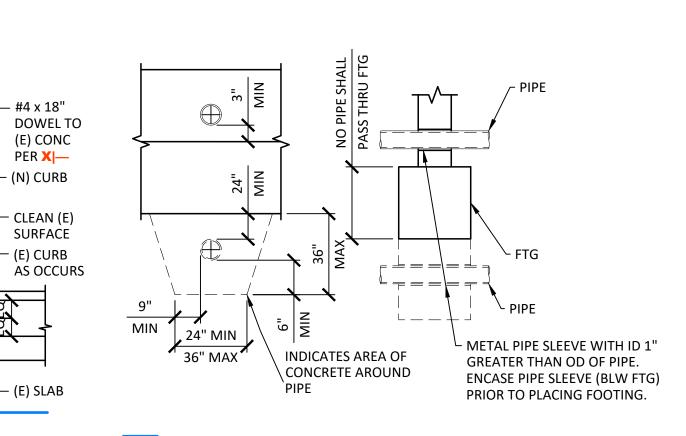

# Pipe Perpendicular To Footing

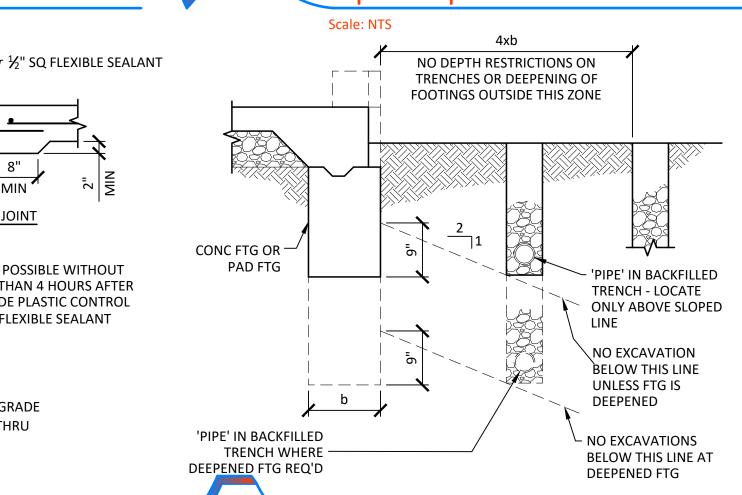

Frenching Adjacent To Footing

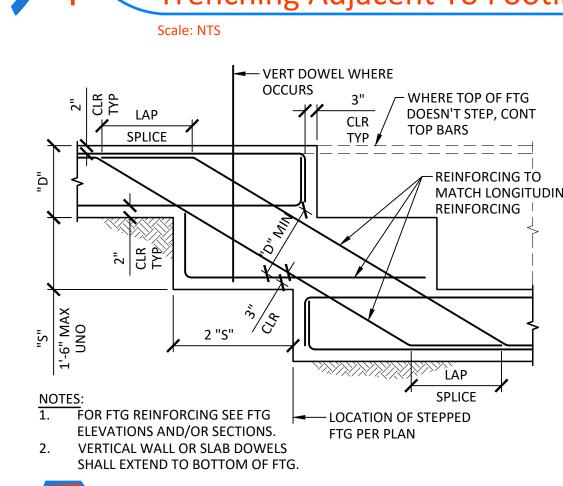

**Stepped Footing** 

MATCH LONGITUDINAL

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Client: .\FRTH logo.PNG


FEATHER RIVER TRIBAL HEALTH 2145 Fifth Avenue Oroville, CA 95965

Project Name: Feather River Tribal Health Center -Pharmacy Addition and Remodel

Submittal: Construction

Architect of Record



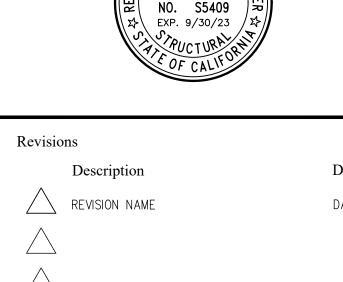

Approvals

Permit No.:

Key Plan


KAP Job No. 463.01 Scale: As Noted Date: 27 December 2022 Drawn By: ANR

Checked By: JMI Sheet Name TYPICAL CONCRETE

Sheet Number


**S1.1** 


**DETAILS** 

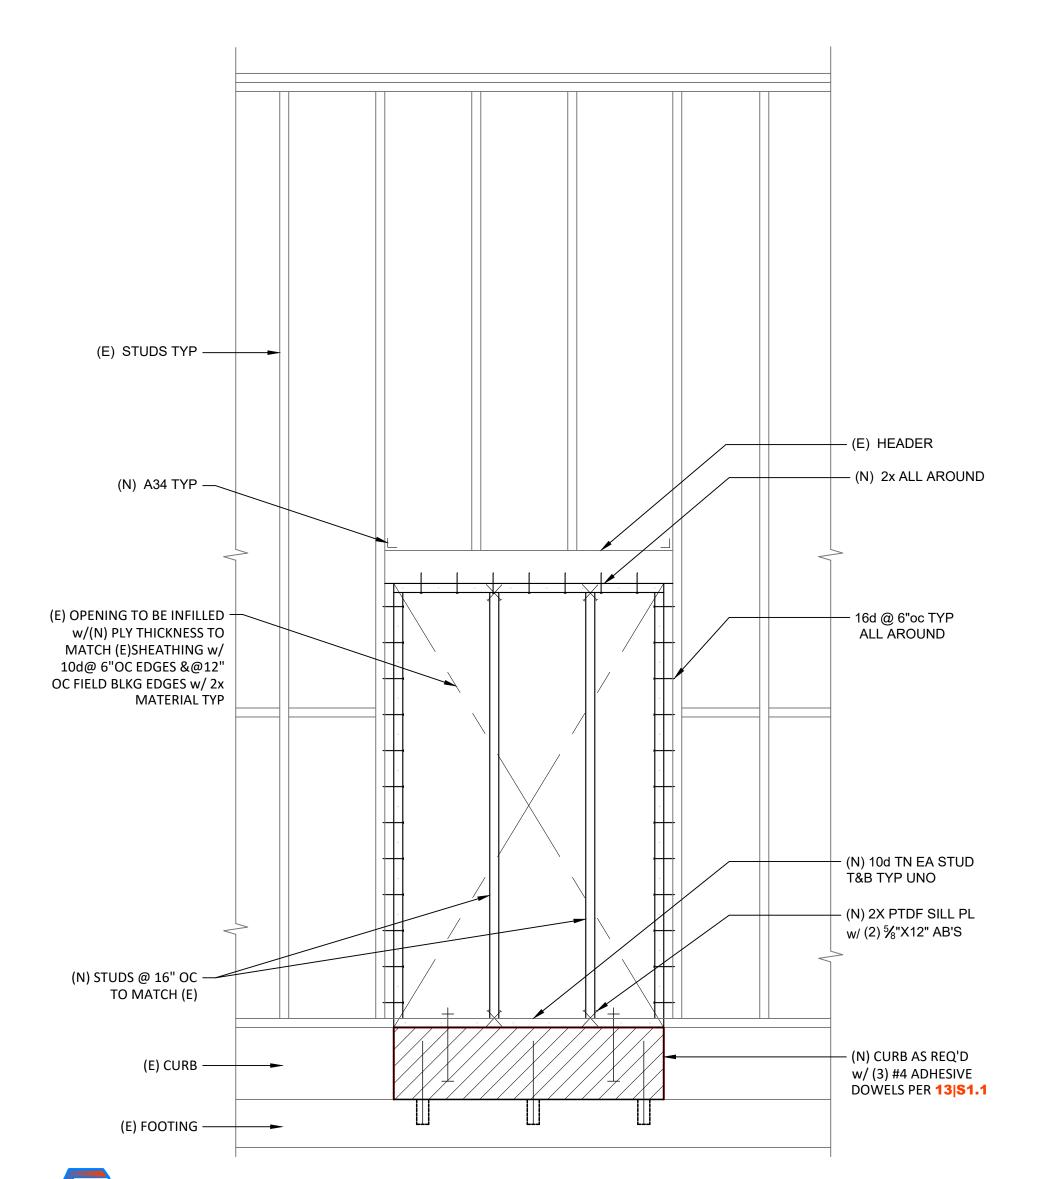


# I) Wood Infill @ (E) Wood Wall

18 (N) Wood Infill @ (E) Wood Wall

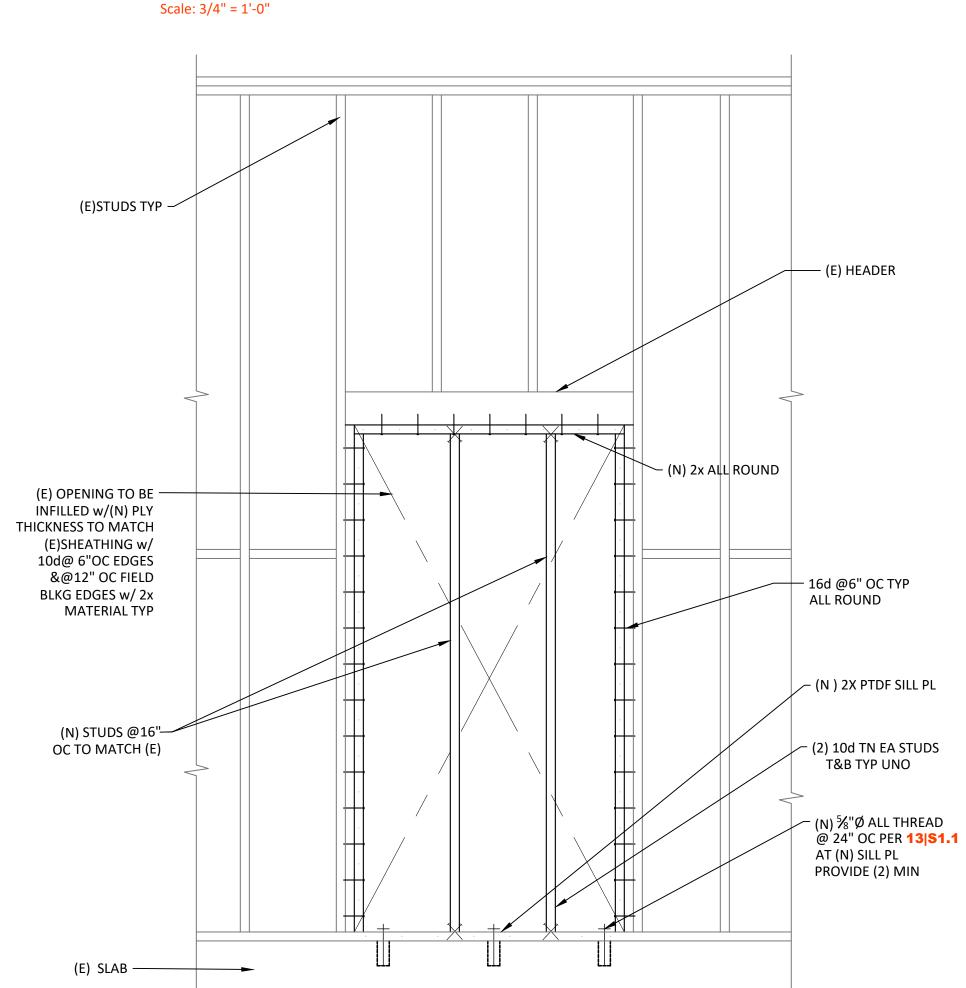


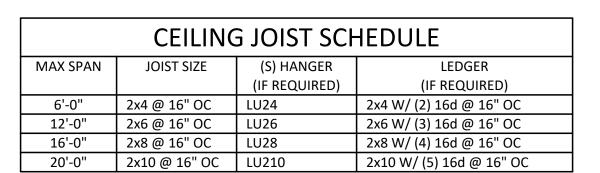

CEILING JOIST SCHEDULE IS BASED ON LL=10 PSF. PROVIDE FULL DEPTH BLKG @ 8'-0" OC MAX @ 2x10 JOISTS

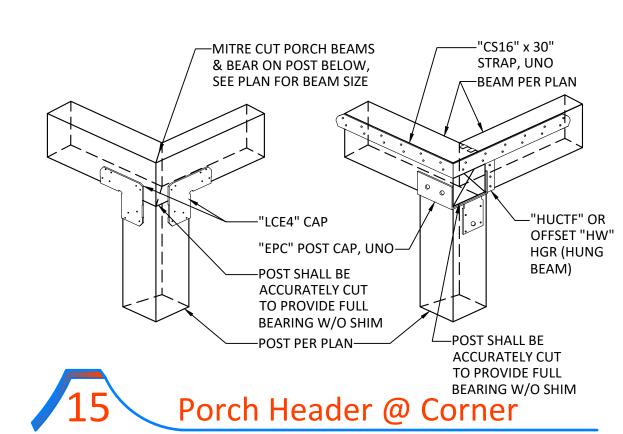

Scale: 3/4" = 1'-0"

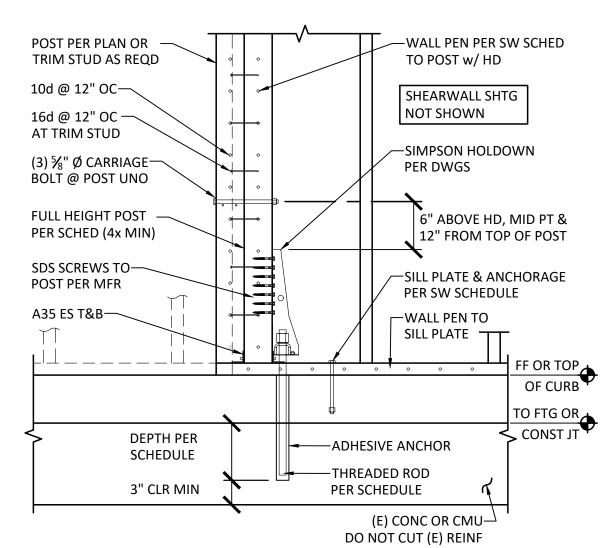

PLAN MARK	HOLDOWN	THRD ROD	DEPTH	TEST LOAD	MIN FTG WIDTH	MIN POST SIZE UNO ON PLANS
2R	HDU2	%"Ø	12"	5000	12"	4x
4R	HDU4	%"Ø	12"	6000	12"	4x
5R	HDU5	%"Ø	12"	7000	12"	4x
8R	HDU8	%"Ø	15"	8000	18"	6x6
11R	HDU11	1"Ø	15"	12000	18"	6x6

- NOTES:


  1. Install adhesive anchors per manufacturer's information and ICC report. Special inspection is required per section 1704 and the requirements of the ICC reports. 2. Acceptable adhesives are: Simpson SET-XP, ICC No. ESR-2508; Hilti HIT-RE500-SD, ICC No. ESR-2322. An approved equal may be substituted unless specifically noted otherwise on drawings.
- 3. Threaded rods to be A36 or A307 Grade C threaded rod. Rebar to be A615. 4. Contractor to verify minimum edge distances, spacing and thickness are in accordance
- with schedule prior to installing anchor. 5. When drilling holes in existing concrete, use care and caution to avoid cutting or
- damaging the existing reinforcing bars. Maintain a reasonable clearance between reinforcement and the drilled-in anchor. CORE DRILLED HOLES NOT PERMITTED. 6. The special inspector must be on the jobsite continuously during anchor installation to verify anchor type, anchor dimensions, hole cleanliness, embedment depth, concrete type, concrete compressive strength, drill bit diameter, hole depth, edge distanceSST,



Adhesive Hold-Down

Scale: 1" =1'-0"


anchor spacingSST, concrete thickness, and adhesive injection.

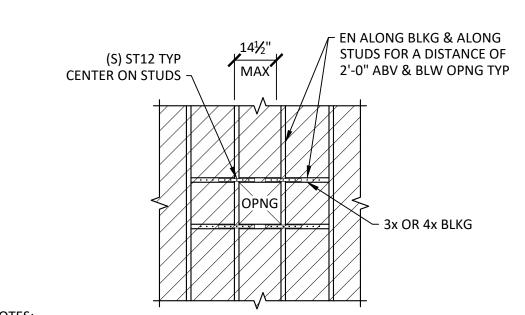


NOTES:

1. DO NOT CUT STUDS UNLESS SPECIFICALLY DETAILED.

1. DO NOT CUT STUDS UNLESS SPECIFICALLY DETAILED. MAX VERT DIMENSION = 2x HORIZONTAL DIMENSION IF OPENINGS LINE UP HORIZONTALLY, NO MORE THAN ONE OPENING IN EVERY TEN STUD SPACES IS PERMITTED

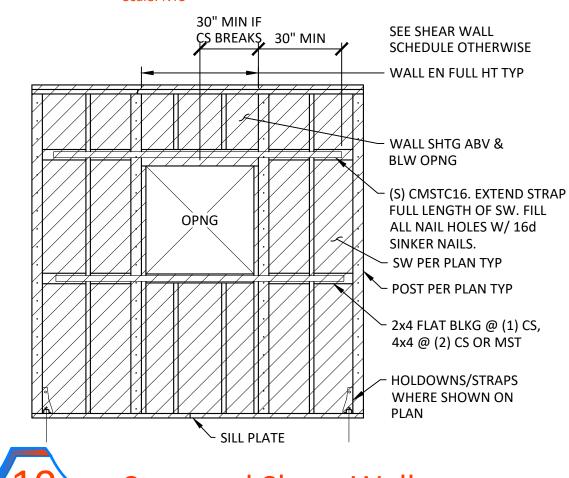

# **Strapped Shear Walls**

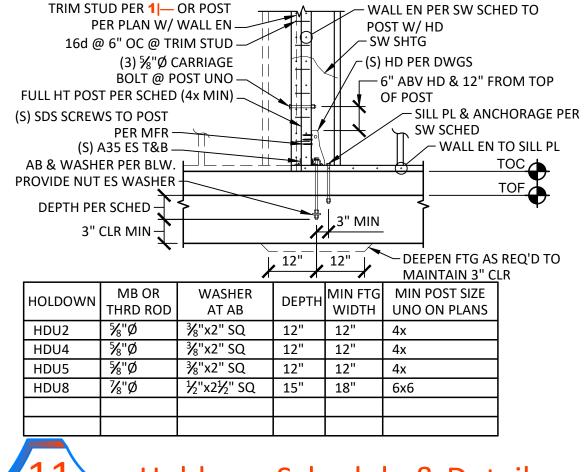

	Scale: NTS	
	TOP PLATE SC	HEDULE
MARK	LAP SPLICE (CASE 1)	STRAP SPLICE (CASE 2)
A	(12) 16d PER 4'-0" MIN LAP	MSTC28
В	(20) 16d PER 4'-0" MIN LAP	MSTC40
C	(30) 16d PER 6'-0" MIN LAP	MSTC66
D	(36) 16d PER 6'-0" MIN LAP	MSTC40 EA SIDE
<b>F</b>	(44) 1C4 DED 0' O" MIN LAD	MCTCCC FA CIDE

(44) 16d PER 8'-0" MIN LAP MSTC66 EA SIDE 1. AT LAP SPLICES, SPACE NAILS @ 3" OC MIN (MAX 12" OC). STAGGER @ 2½" GAGE.


1.711 2711 31 21023, 31 7102 1171123	6 3 00 mm (mm 12 00): 3 model 6 272 0 mode.	
<ol><li>USE STRAP SPLICE WHERE BM</li></ol>	1 INTERSECTS TOP PL.	
3. NAILS TO MATCH LAP SPLICE	ES OF SPLICE (16d @ 12" OC MIN).	
4. USE SPLICE UNO.	_TOP PL'SSPLICE BO	TH
LAP	EQ # NAILS EE PL'S OVER	
	STUD	
	<del></del>	1
1"		<b>T</b>
CASE 1	2x BLKG W/ EN & 16d / CASE 2 └ STRAP *	
	@ EN SPCG TO PL'S $\overline{}$	
717\ Ton	PI Solice Schedule & De	ב†נ

# Top PL Splice Schedule & Details


	FASTEN	ING SCHI	EDULE
	CONNECTION	FASTENING	LOCATION
	IOIST OR RAFTER TO BEARING SUPPORT	(2) 10d ES	TOENAIL
2. E	BRIDGING TO JOIST	(2) 8d	TOENAIL EA END
3. \$	SILL PLATE TO JOIST OR BLKG	16d @ 12" OC	TYPICAL FACE NAIL
4. 1	TOP PLATE TO STUD	(2) 16d	END NAIL
5. 5	STUD TO SILL PLATE	(2) 10d ES	TOENAIL
		(3) 16d	END NAIL
6. [	DOUBLE STUDS	16d @ 16" OC	FACE NAIL
7. [	DOUBLE TOP PLATES	16d @ 12" OC	TYPICAL FACE NAIL
		(12) 16d	LAP SPLICE
_	BLKG BTWN JOISTS OR RAFTERS TO TOP PLATE	(3) 10d	TOENAIL
9. F	RIM JOIST TO TOP PLATE	10d @ 6" OC	TOENAIL
	TOP PLATES, LAPS & NTERSECTIONS	(3) 16d	FACE NAIL
	CONTINUOUS HEADER, TWO PIECES	16d	12" OC ALONG EDGE
12. (	CEILING JOISTS TO PLATE	(3) 10d	TOENAIL
13. (	CONTINUOUS HDR TO STUD	(4) 10d	TOENAIL
14. E	BUILT-UP CORNER STUDS	16d	16" OC
15. E	BUILT-UP GIRDER & BEAMS	20d @ 32" OC	FACE NAIL @ T&B STAGGERED ON OPPOSITE SIDES
		(2) 20d	FACE NAIL @ ENDS @ EA SPLI

Fastening Schedule


ALL NAILS INTO PRESSURE TREATED MATERIAL TO BE HOT-DIPPED GALVANIZED

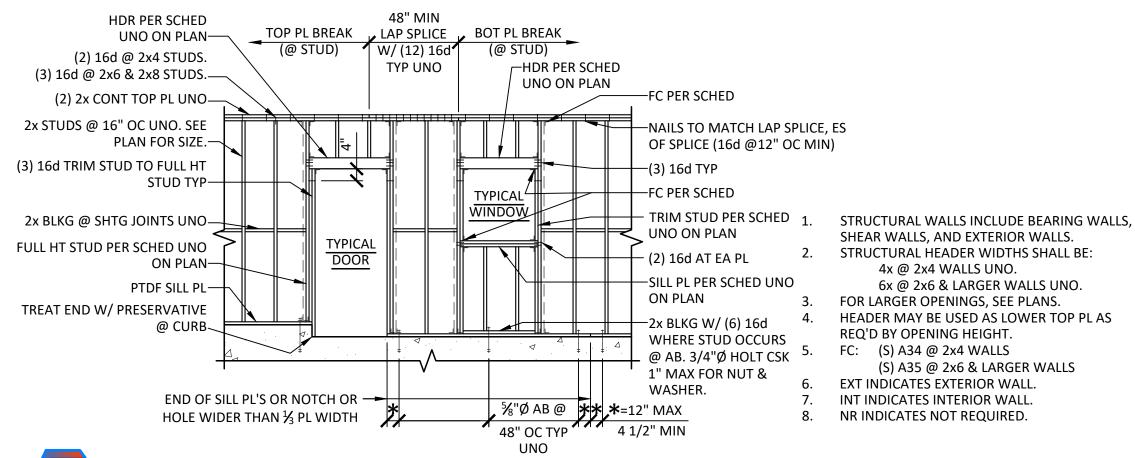

# Studwall & Opening Framing

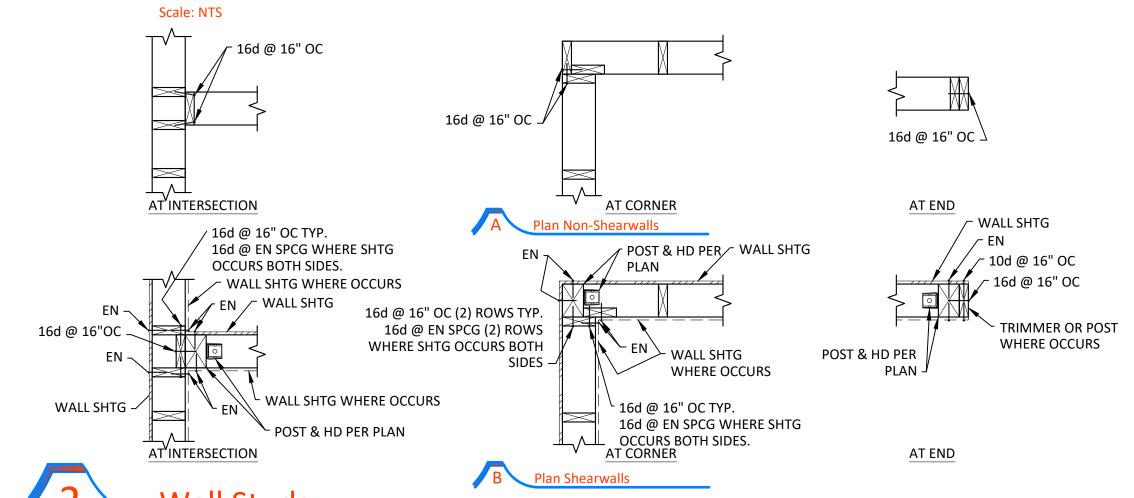



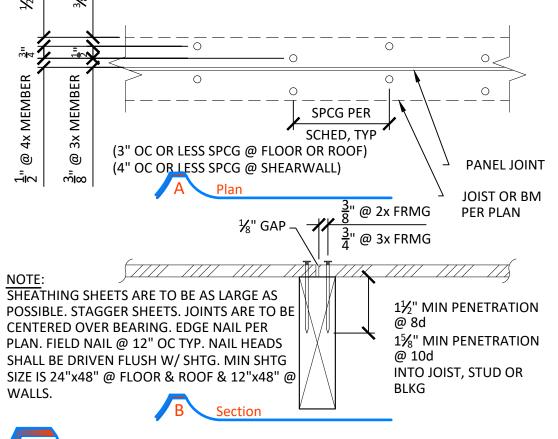


# **Close Spaced Nails**


	0	PENI	NG FR	AMING S	SCHI	EDU	LE	
OPENING	FULL H	T STUD	TRIN	л STUDS	SILI	_ PL	FC	
SPAN	EXT	INT	STRUCT	NON-STRUCT	EXT	INT	EXT	INT
4'-0"	(1) 2x	(1) 2x	(1) 2x	(1) 2x	(1) 2x	(1) 2x	NR	NR
6'-0"	(2) 2x	(1) 2x	(1) 2x	(1) 2x	(1) 2x	(1) 2x	(1) FC	NR
8'-0"	(2) 2x	(1) 2x	(2) 2x	(1) 2x	(2) 2x	(1) 2x	(1) FC	(1) F
12'-0"	(3) 2x	(2) 2x	(2) 2x	(1) 2x	(3) 2x	(2) 2x	(2) FC (ES)	(1) F

HEA	DER SCH	EDULE
OPENING	HEAD	ERS
SPAN	STRUCT	NON-STRUCT
4'-0"	8" DEEP	2x4
6'-0"	10" DEEP	2x6
8'-0"	12" DEEP	2x8


Scale: NTS

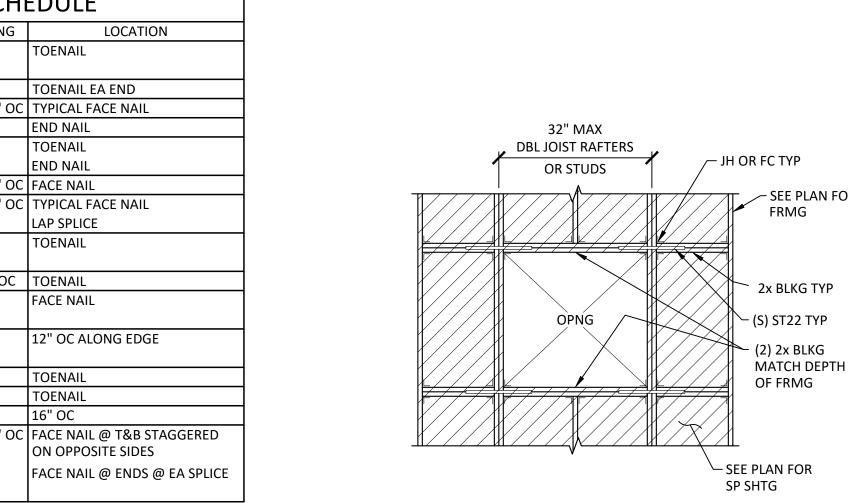


Opening In Roof Or Floor Diaphragm

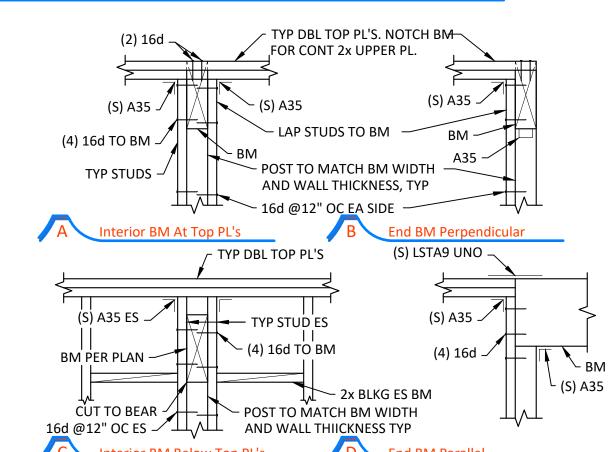

# Beam In & Thru Stud Wall

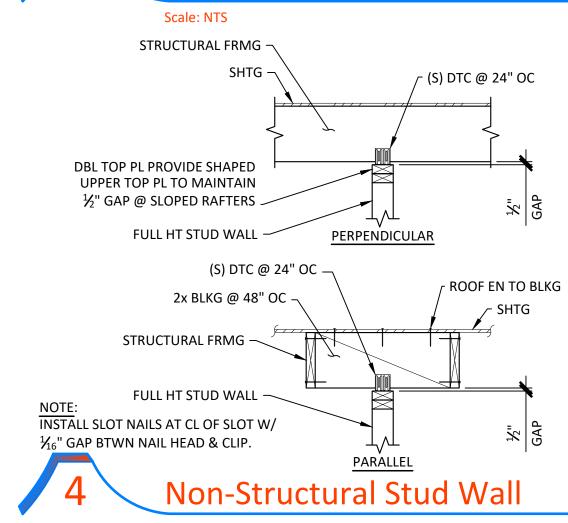

Scale: NTS

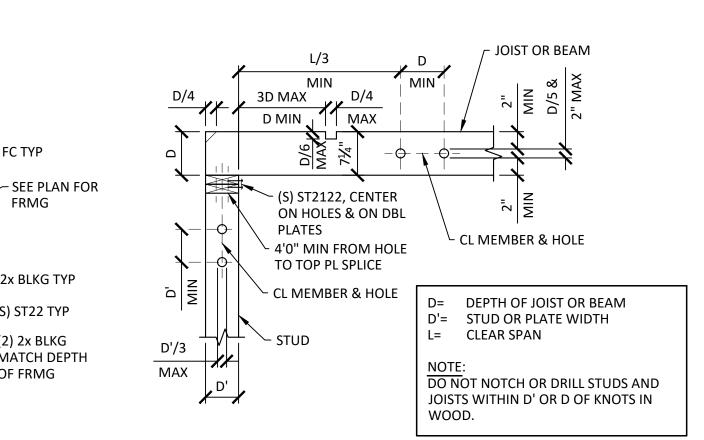

Holes and Notches In Wood Studs, Joists, Beams, and Plates Sheet Number

Scale: NTS



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Client:

FEATHER RIVER TRIBAL HEALTH 2145 Fifth Avenue

Oroville, CA 95965

Project Name: Feather River Tribal Health Center -Pharmacy Addition and Remodel

Submittal: Construction Document



Revisions Description REVISION NAME

럹 NO. S5409 │♡

\☆\ EXP. 9/30/23 /☆

Key Plan

Permit No.:


Approvals


KAP Job No. 463.01 Scale: As Noted Date: 27 December 2022 Drawn By: ANR Checked By: JMI

Sheet Name TYPICAL FRAMING

**DETAILS** 


**S1.2** 

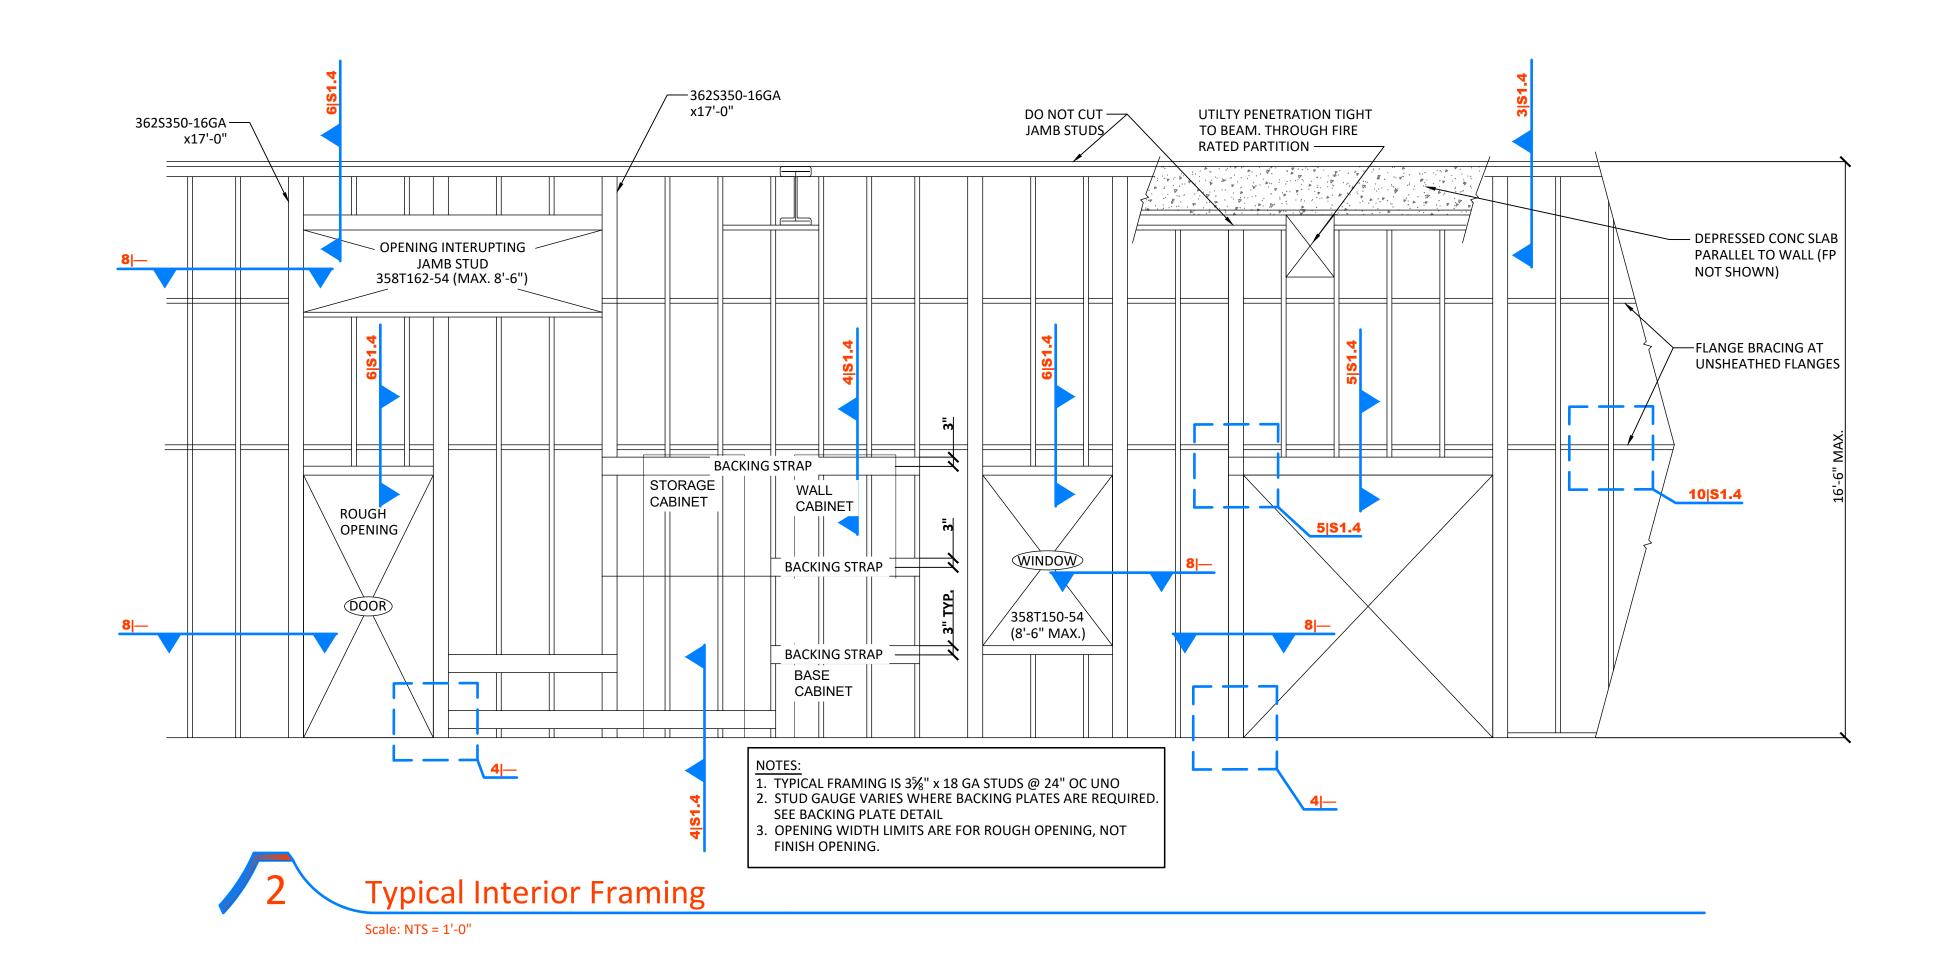

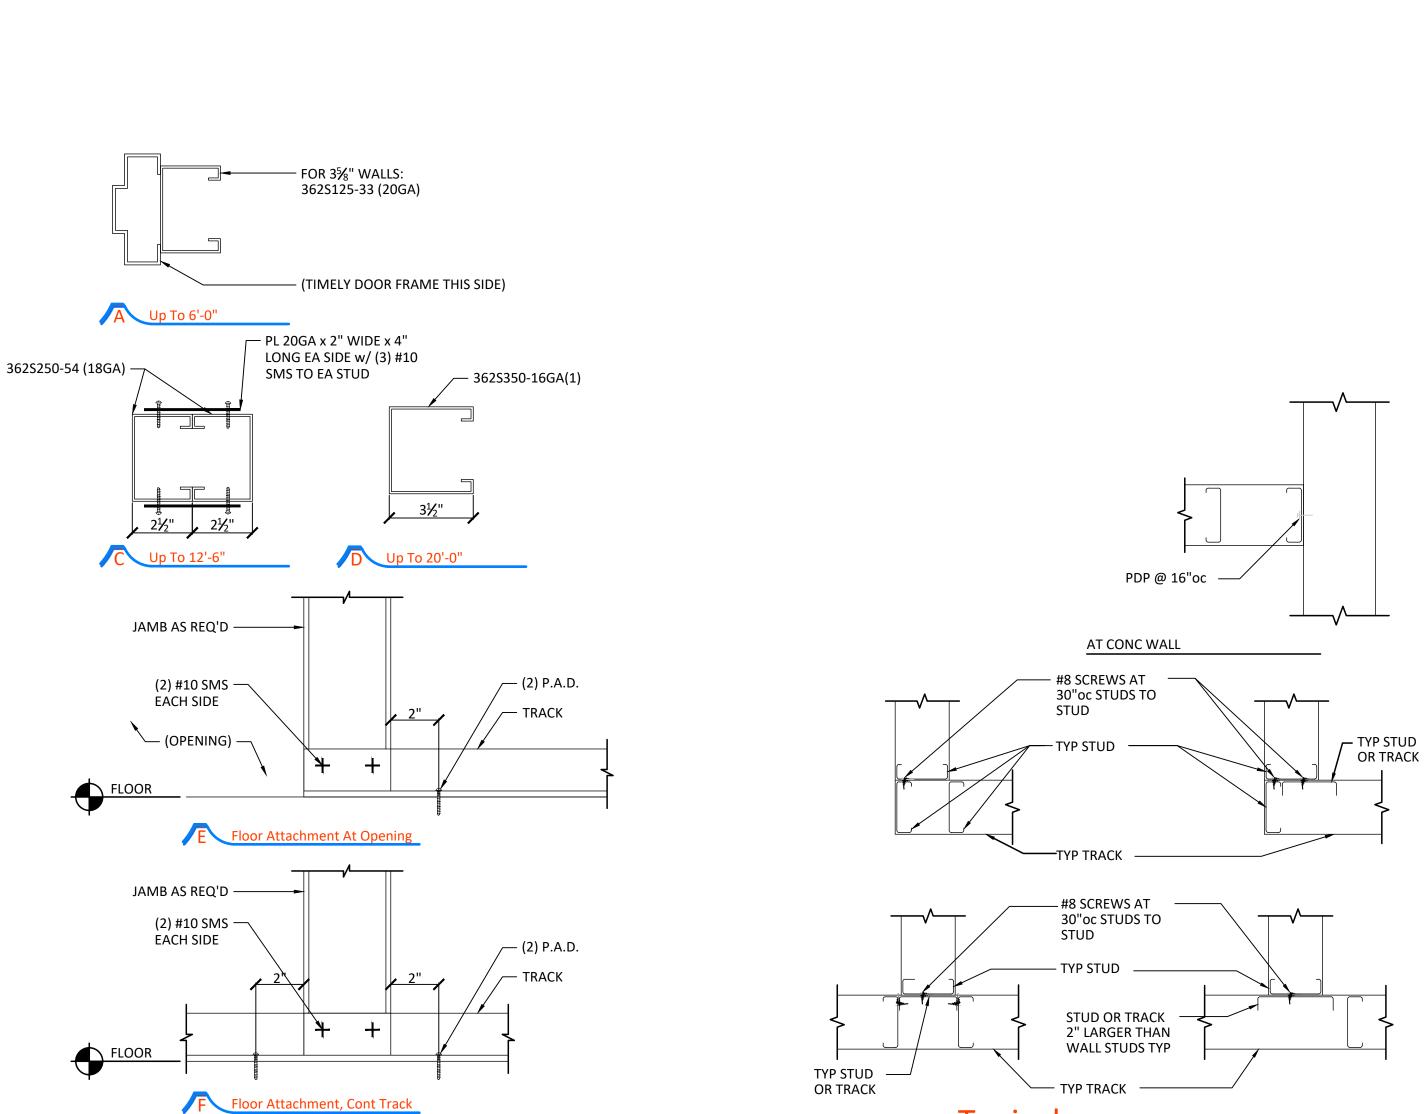

Scale: 3" = 1'-0"

Scale: 3/4" = 1'-0"

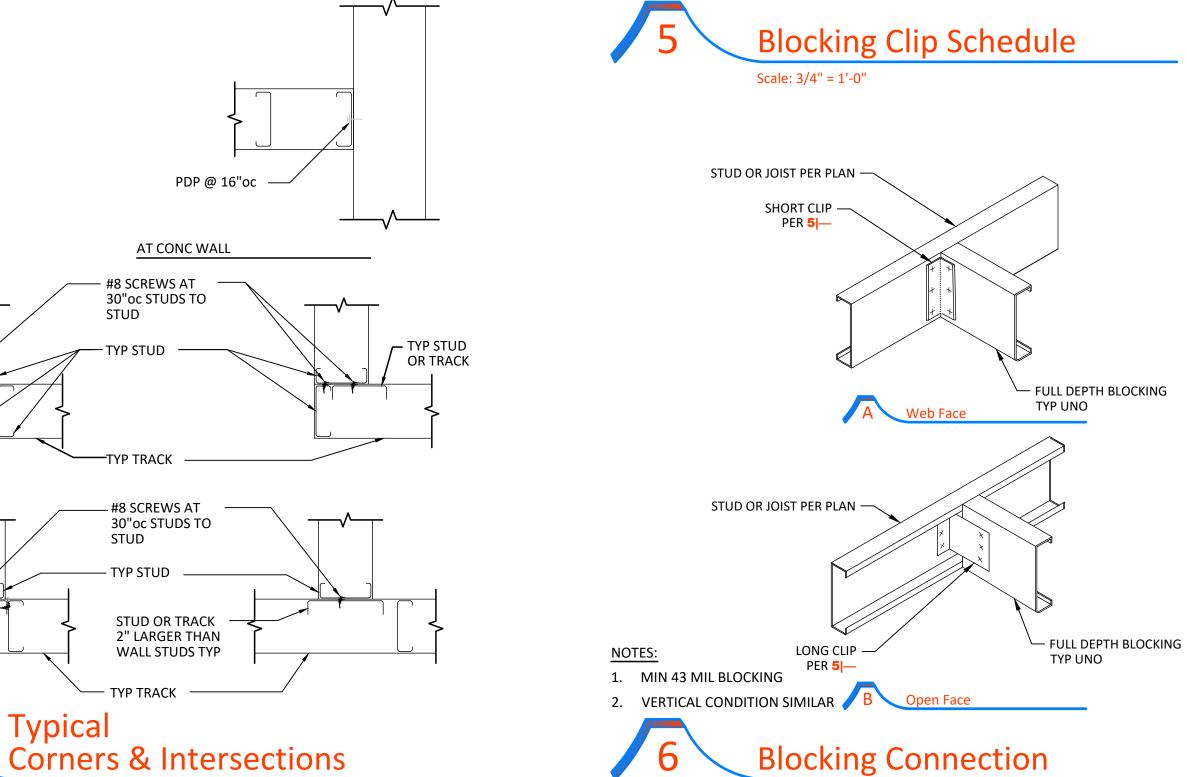

LONG CLIP (5")

43 MIL UNO

∠ 2" X 5" X

∠ 2" X 5" X 4 1/2"

∠ 2" X 5" X 6 1/2"

DEPTH

362

600

800

SHORT CLIP (2")

43 MIL UNO

∠ 2" X 2" X

∠ 2" X 2" X 4 1/2"

∠ 2" X 2" X 6 1/2"

SCREWS

(2) #10 SMS


EA LEG (UNO)

(3) #10 SMS EA


LEG (UNO)


(3) #10 SMS EA

LEG (UNO)

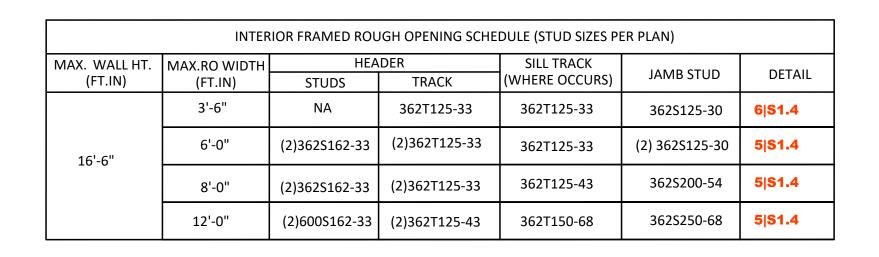



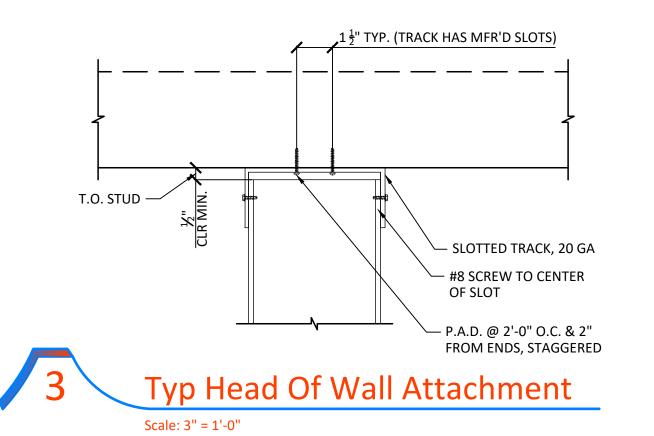

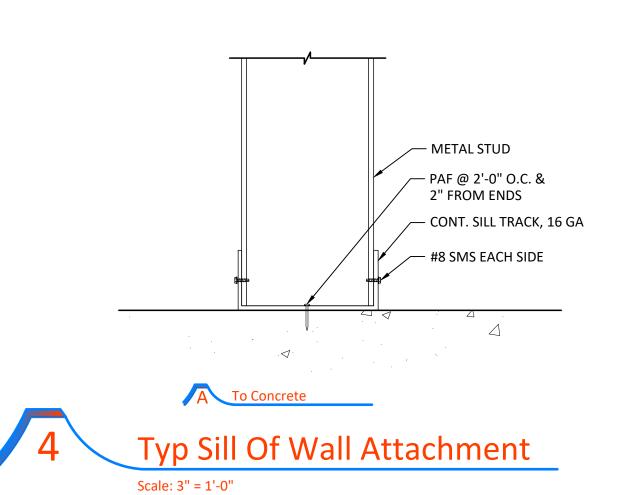



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FEATHER RIVER
TRIBAL HEALTH
2145 Fifth Avenue

Oroville, CA 95965

Feather River Tribal
Health Center Pharmacy Addition
and Remodel

Submittal:


Construction

Document

Architect of Record





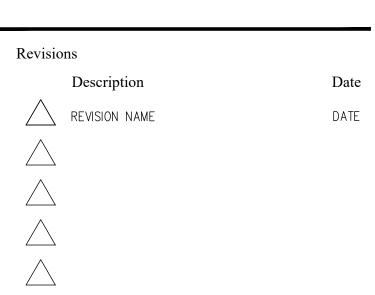

Approvals

Permit No.:

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Key Plan



KAP Job No. 463.01

Scale: As Noted

Date: 27 December 2022

Drawn By: ANR

Checked By: JMI


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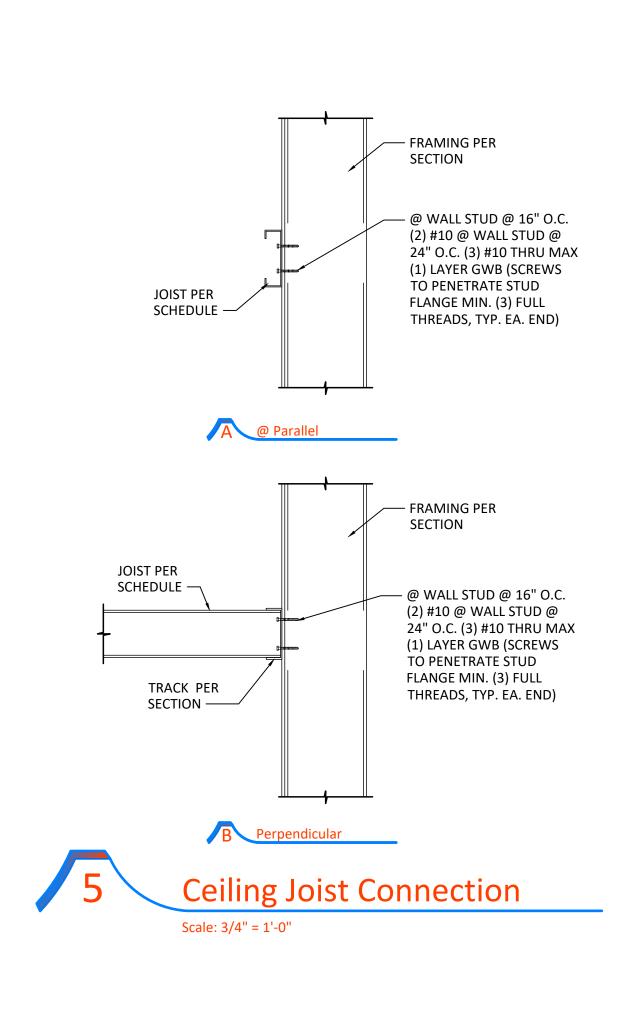
TYPICAL COLD-FORMED STEEL DETAILS


Sheet Number

S1.3







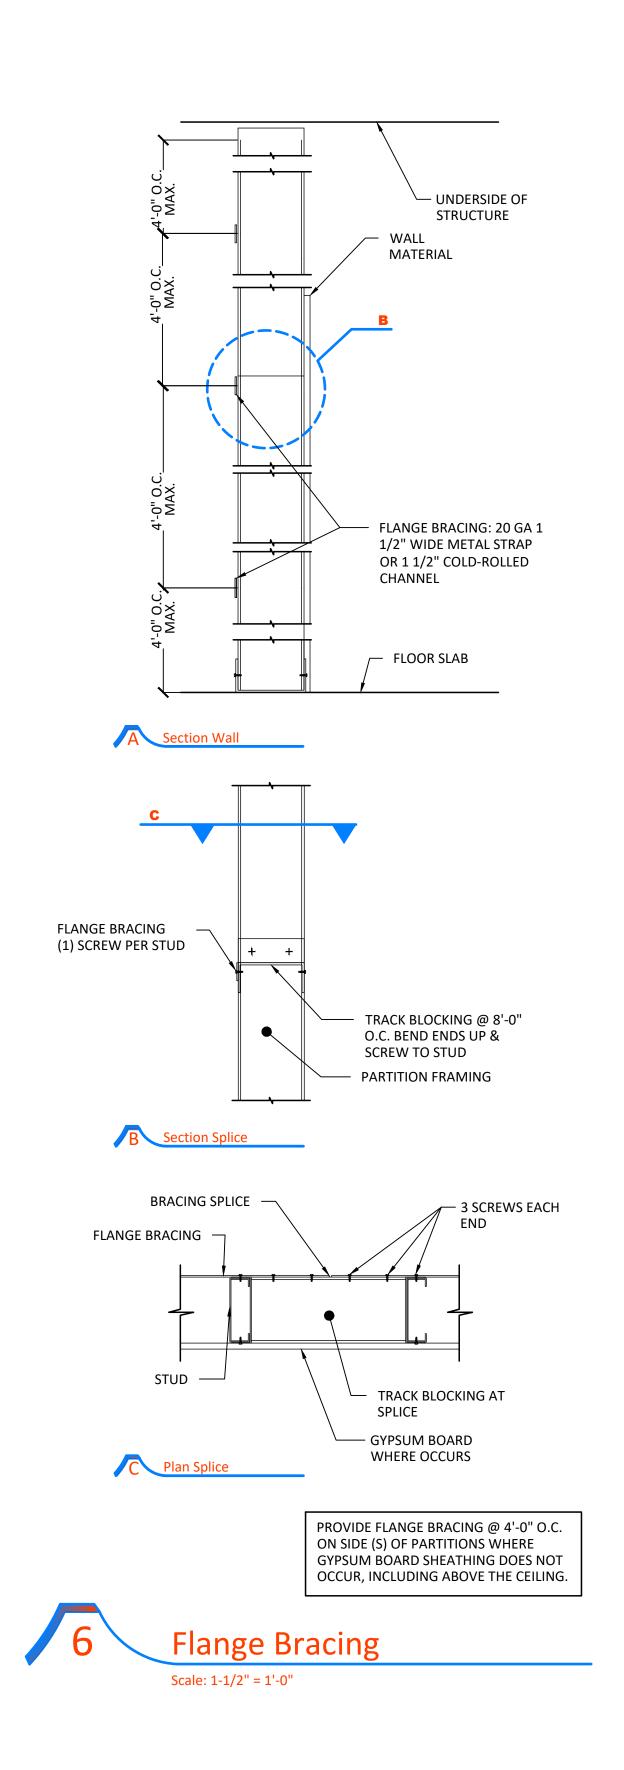


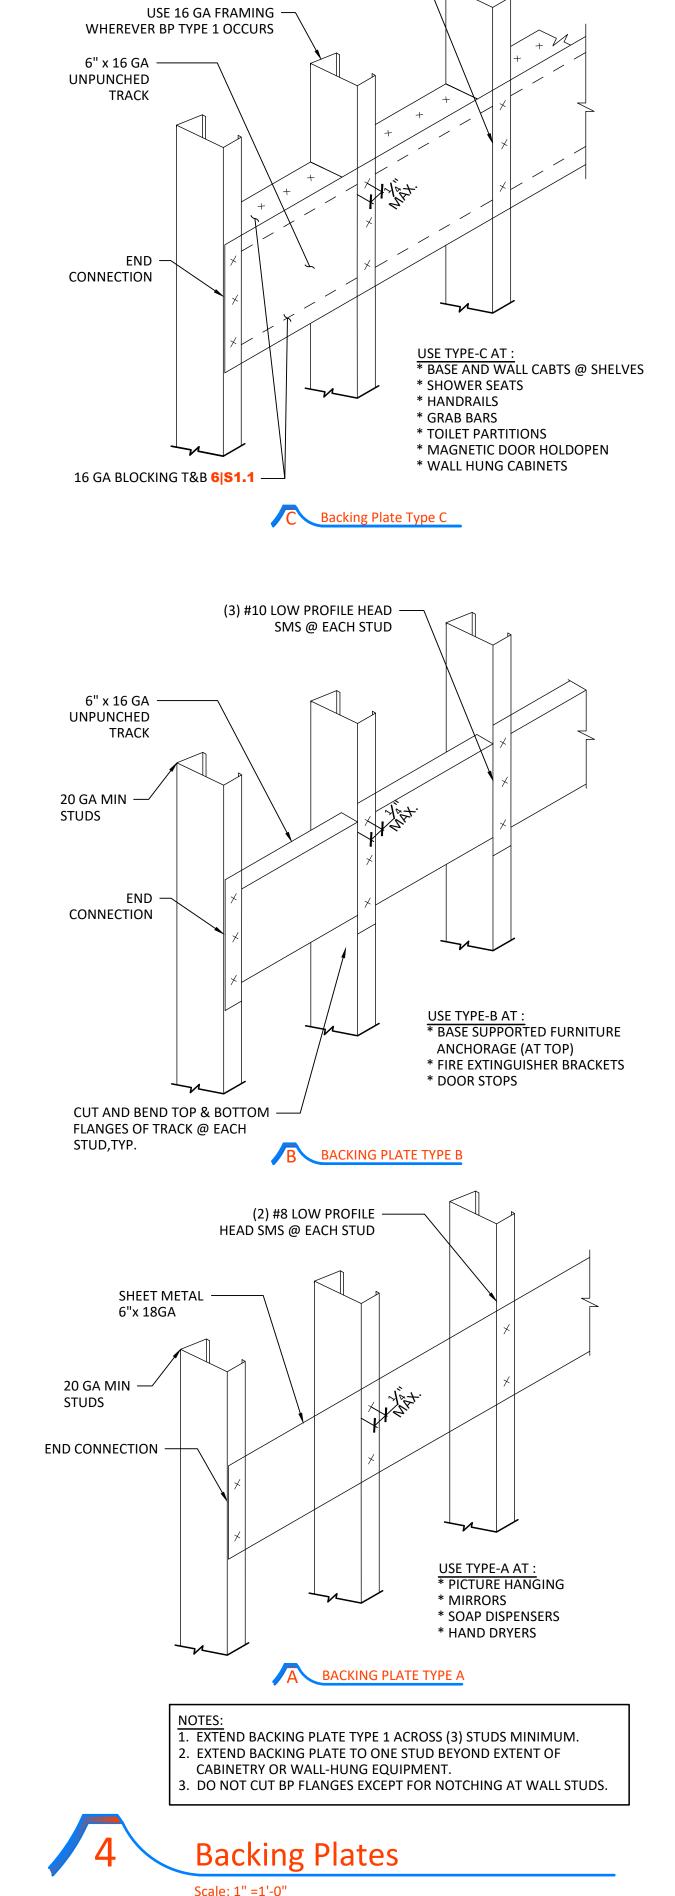


(3) #10 LOW PROFILE HEAD —— SMS @ EACH STUD

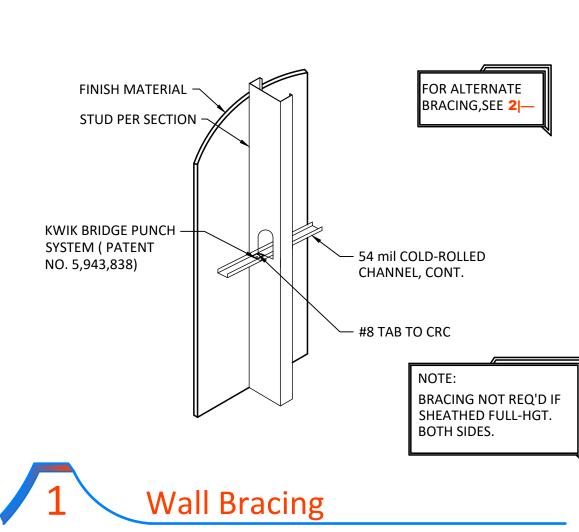

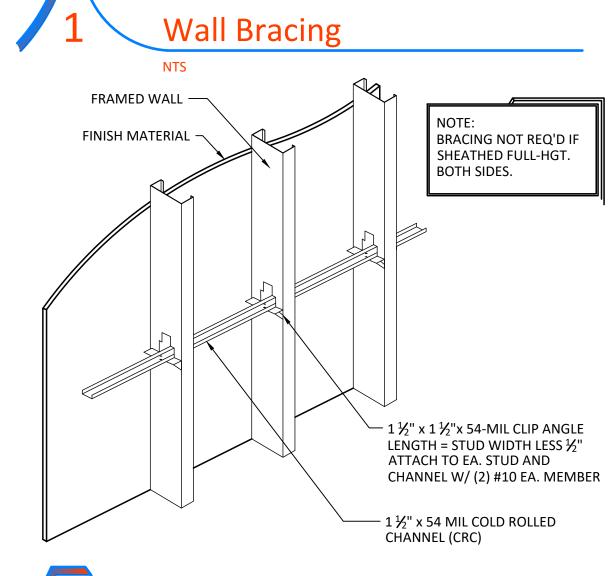

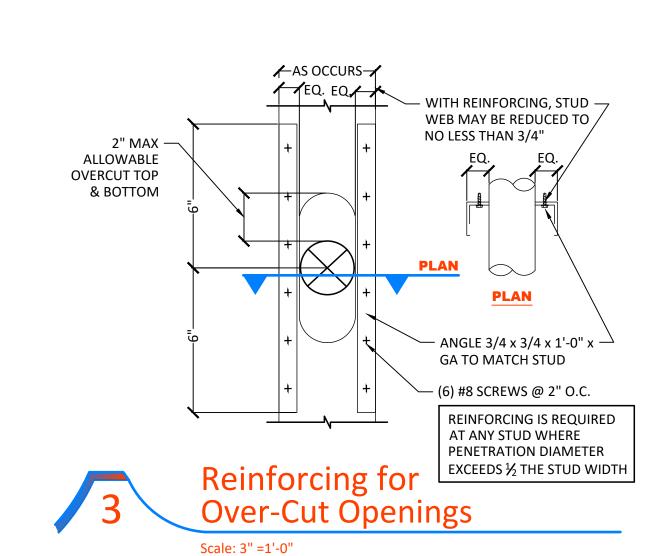

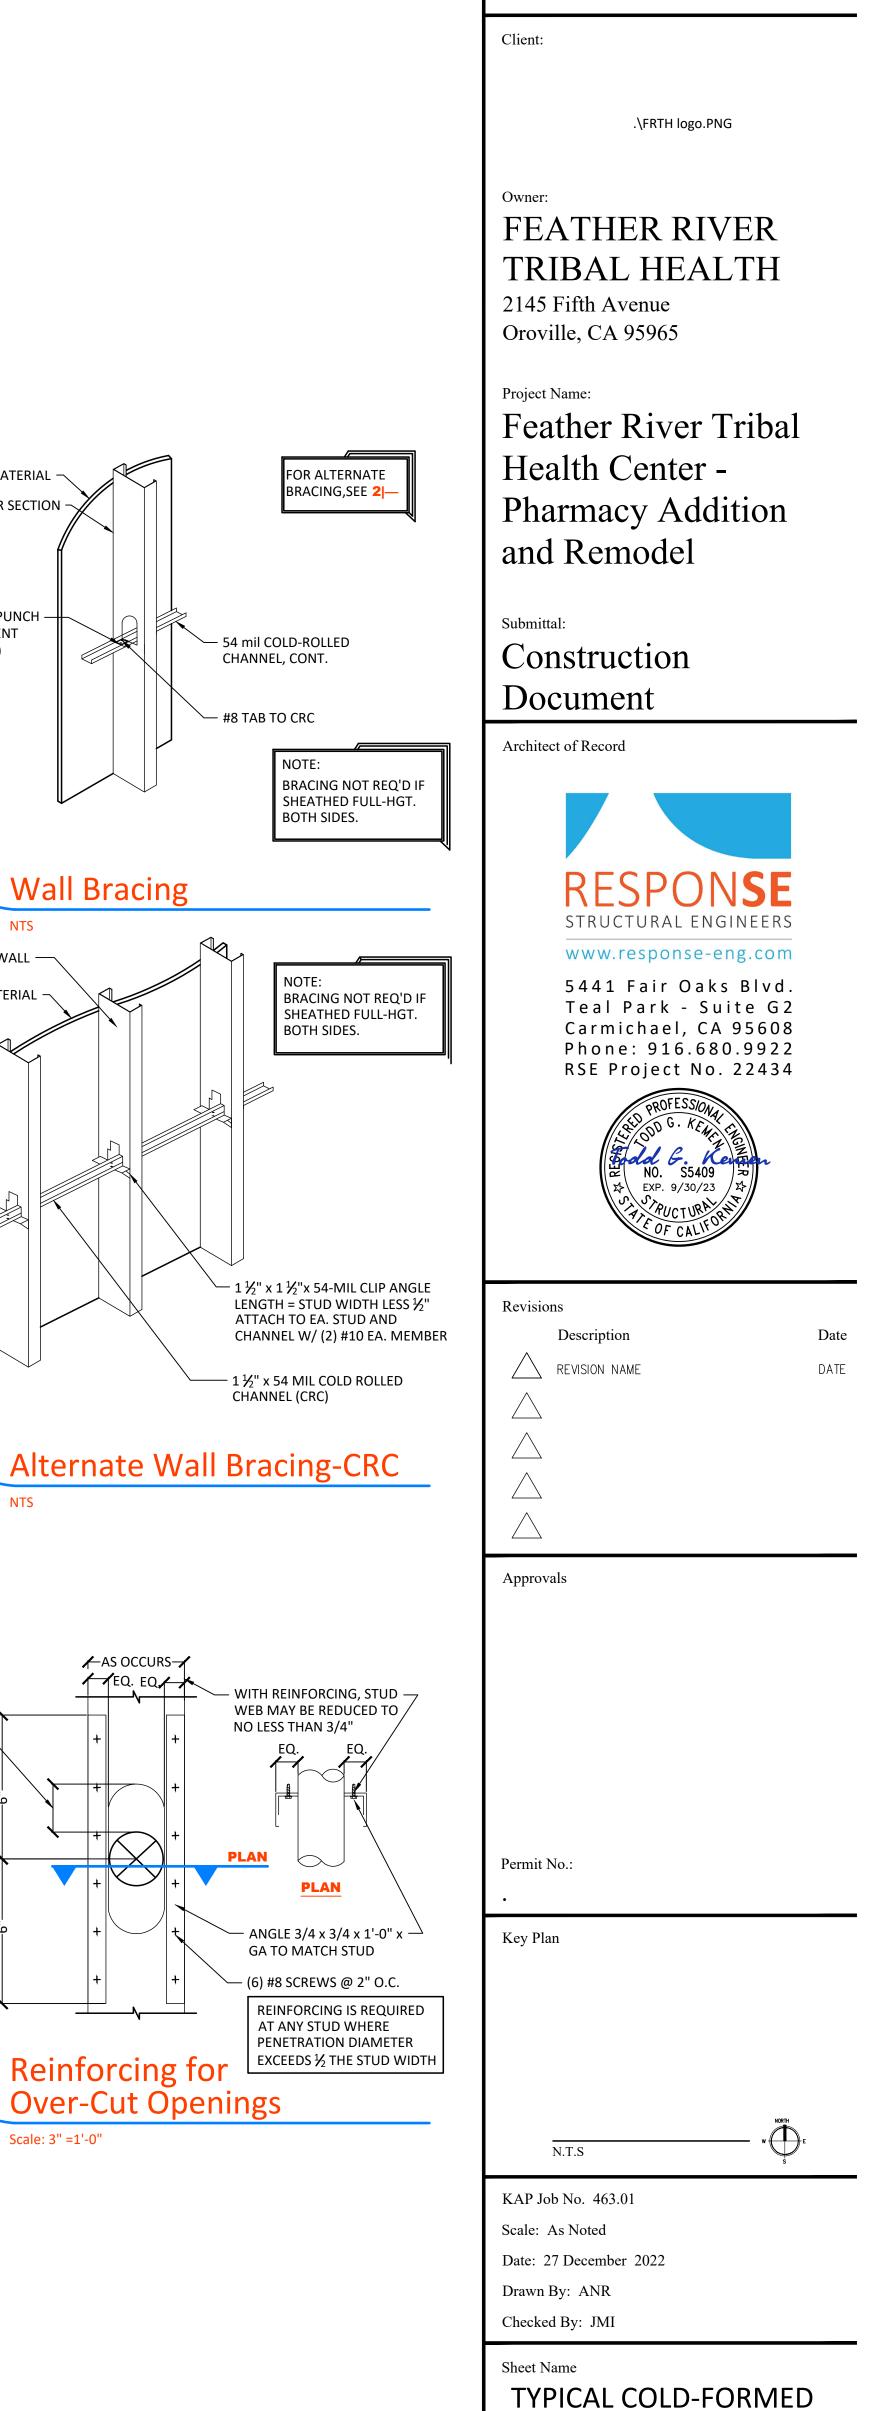

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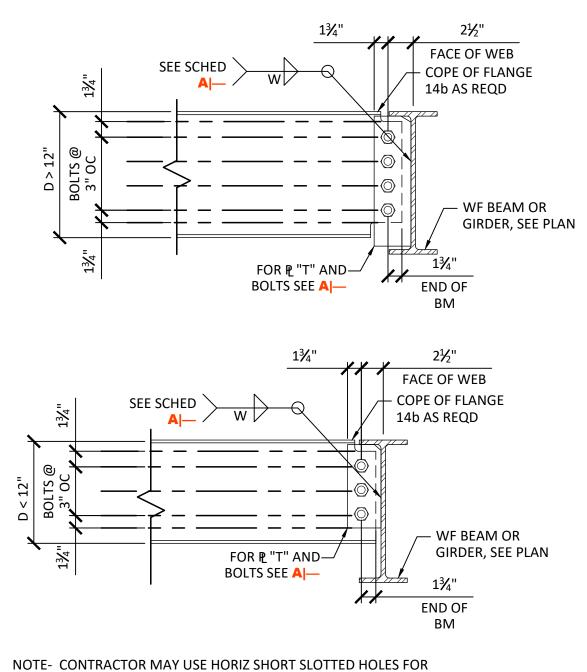
Sheet Number S1.4

STEEL DETAILS

CONTINUED


BEAM SIZE	NO 1Ø A-325-N BOLTS	SHR PET	w
C8 & C10	2- <del>7</del> 8" Ø	1/4"	3/16'
W8 & W10	2- <del>7</del> 8" Ø	1/4"	3/16'
W12 & W14	3- <del>7</del> 8" Ø	1/4"	3/16'
W16	4- <sup>7</sup> / <sub>8</sub> " Ø	3∕8"	1/4"
W18	5- <del>7</del> 8" Ø	3∕8"	1/4"
W21	5- <del>7</del> 8" Ø	3∕8"	1/4"
W24	6- <del>7</del> 8" Ø	3%"	1/4"
W27	7- <del>7</del> 8" Ø	3%"	1/4"
W30	8- 1" Ø	1/2"	5/16'
W33	9- 1" Ø	5/8"	5/16'
W36	10- 1" Ø	5/8"	5∕16′








NOTE- CONTRACTOR MAY USE HORIZ SHORT SLOTTED HOLES FOR THESE CONNECTIONS ONLY. THE SHORT SLOTTED HOLES SHALL BE IN THE BEAM WEB WITH HARDENED WASHERS PROVIDED OVER THE SLOTS.


Detail @ Beam To Beam-One Side

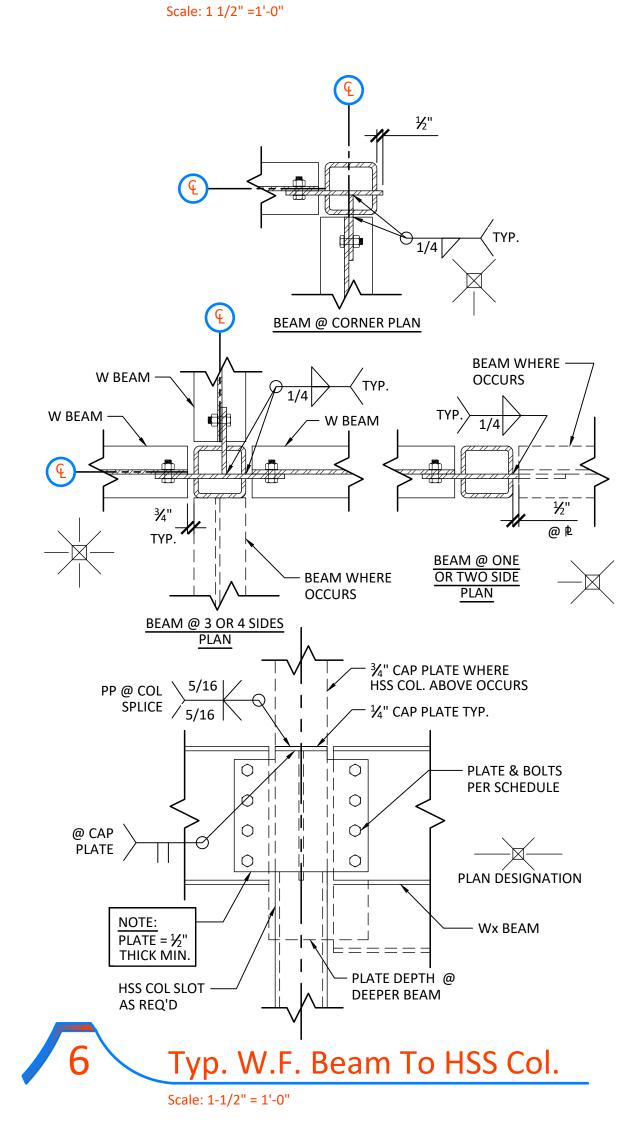

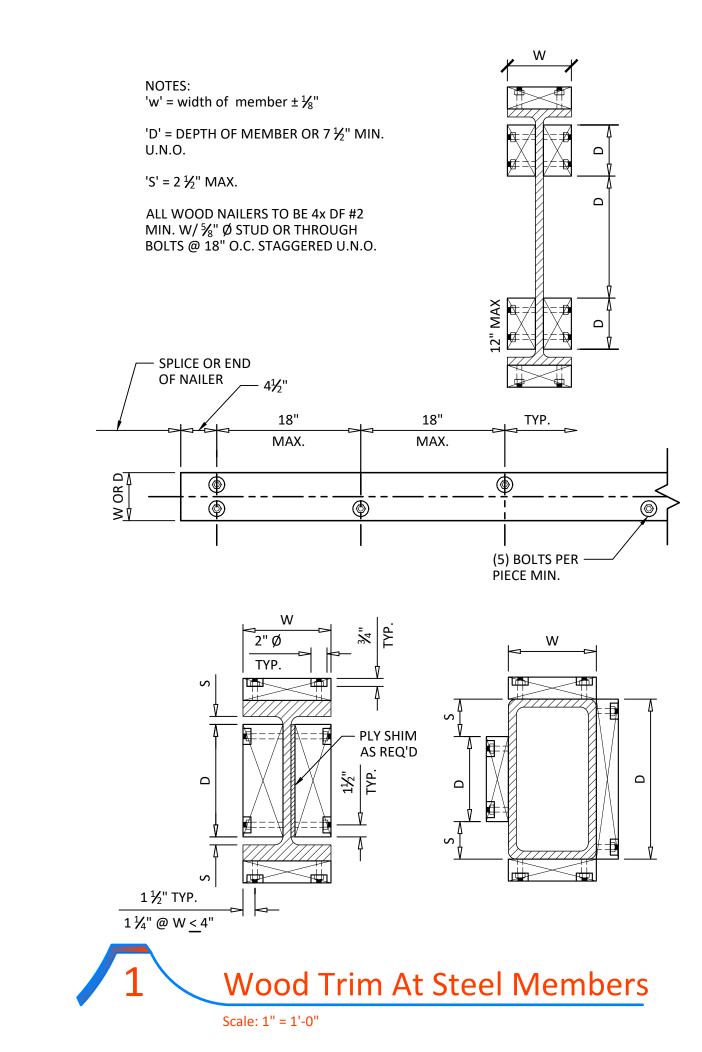

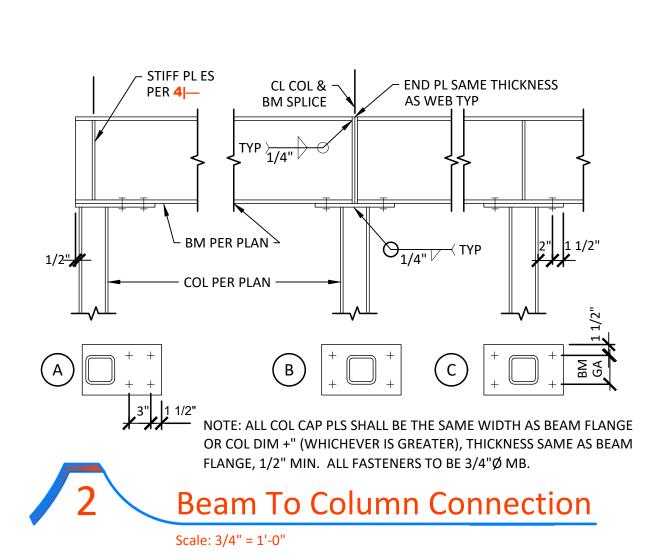

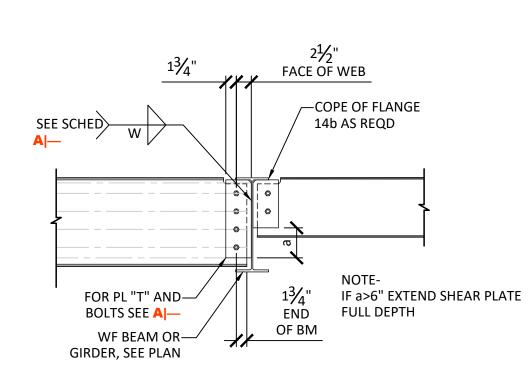

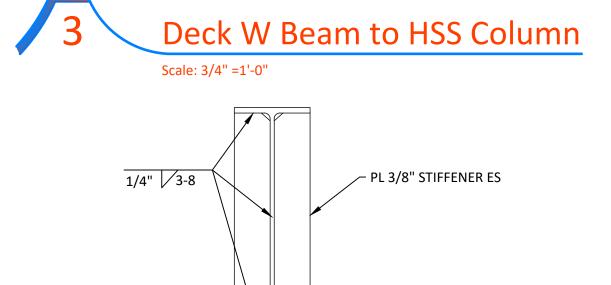





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FEATHER RIVER
TRIBAL HEALTH
2145 Fifth Avenue
Oroville, CA 95965

Feather River Tribal
Health Center Pharmacy Addition
and Remodel


Submittal:

Construction

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Revisions

Description
Date

REVISION NAME
DATE

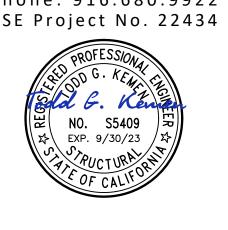Approvals

Permit No.:

Key Plan

N T S

KAP Job No. 463.01

Scale: As Noted

Date: 27 December 2022

Drawn By: ANR

Checked By: JMI

Sheet Name

TYPICAL STEEL DETAILS

Sheet Number

S1.5

I. Legend:	
[::::::]	(E) FTG
C===3	(N) FTG
	(E) WALL
	(N) WALL
	(N) METAL STUD WALL PER 2 S1.3
V//////	BRICK VENEER
0	(N) STEEL COLUMN
	(E) STEEL COLUMN
	(N) 6x6 WOOD POST @ END OF (N) SHEARWALL
	(E) SHEARWALL
	(N) SHEARWALL LOCATION, SEE SHEARWALL SCHED III
<b>.</b>	(N) SST HDU HOLDOWN 11 S1.2 UNO
<b>K</b> R	(N) SST ADHESIVE HDU HOLDOWN 16 S1.2
X 5'-0"	SHEARWALL TYPE & MINIMUM LENGTH. SEE SHEAR WALL SCHEDULE.
XS 5'-0"	STRAPPED SHEARWALL TYPE & MINIMUM LENGTH. SEE SHEAR WALL SCHEDULE & 10 \$1.2

### II. Footing Schedule:


MARK	SIZE	REINFORCEMENT
3	3'-0"x3'-0"x12" DEEP	(3) #5 REBAR EA WAY @ BOT
<b>5</b>	5'-0"x3'-0"x12" DEEP	(3) #5 REBAR @ TOP & BOT (LONG WAY) & (6) #5 REBAR @ TOP & BOT (SHORT WAY)
<b>6.6</b>	6'-6"x4'-0"x12" DEEP	(4) #5 REBAR @ TOP & BOT (LONG WAY) & (7) #5 REBAR @ TOP & BOT (SHORT WAY)
8	8'-6"x4'-0"x18" DEEP	(6) #5 REBAR @ TOP & BOT (LONG WAY) & (7) #5 REBAR @ TOP & BOT (SHORT WAY)

### 1. Footings to be centered below posts/columns UNO.

	SHEARWALL DESIGNATION:- SHEARWALL LENGTH:-	6 X'-X"	<b>X'-X"</b>	3 X'-X"	2 X'-X"	2A X'-X"	ALL NON SHEARWALLS
	PLYWOOD OR OSB SHEATING THICKNESS :	1/2"	1/2"	½"	1/2"	½" STR 1	COVERING AS REQUIRED IN ARCH DWGS
	EDGE NAILING:	10d @ 6" OC	10d @ 4" OC	10d @ 3" OC	10d @ 2" OC	10d @ 2" OC	@ 6" OC
SHEATING ONE FACE	3x MEMBERS REQUIRED AT PANEL EDGES:	NO	YES	YES	YES	YES	NO
	3x SILL REQUIRED:	NO	NO	NO	YES	YES	NO
	FIELD NAILING:	10d @ 12" OC	10d @ 12" OC	10d @ 12" OC	10d @ 12" OC	10d @ 12" OC	@ 12" OC
	SILL CONNECTION: NAILS (2-16d NAILS): SCREWS (SDS25600):	@ 6" OC @ 12" OC	@ 5" OC @ 9" OC	@ 4" OC @ 6" OC	 @ 5" OC	 @ 4" OC	@ 8" OC 
	5/8" DIA, MUDSILL AB: WITH 2x SILL WITH 3x SILL	@ 36" OC MAX @ 42" OC MAX	_	@ 18" OC MAX @ 24" OC MAX		 @ 16" OC MAX	 
	TOP CONNECTION - "RBC" TOP CONNECTION - "LTP4" TOP CONNECTION - "LS70" TOP CONNECTION - "A35"	@ 16" OC MAX @ 24" OC MAX @ 24" OC MAX @ 24" OC MAX	@ 16" OC MAX @ 18" OC MAX	@ 8" OC MAX @ 12" OC MAX @ 12" OC MAX @ 10" OC MAX	@ 8" OC MAX	@ 8" OC MAX @ 10" OC MAX	@ 6" OC MAX @ 6" OC MAX
	ALLOWABLE SHEAR	310	460	600	770	870	

- S1. All (N) exterior walls to be shear wall Type 6 UNO on plans.
- S2. Shear wall lengths, where noted, are minimum. Where length not indicated, Shear Wall to be full length of wall.
- S3. Edge nail wall sheathing to studs or posts with holdowns.
- S4. Wall sheathing to be 15/32" APA rated Sheathing (24/0) Exp 1 with 16d @ 12" OC field UNO.
- S5. Block all unsupported edges with 2x material UNO.
- S6. All nails to be common wire. Stagger nails where 2 rows are required.
- S7. Use 20d sinker nails in lieu of 16d nails at 3x sill plates.
- S8. Portions of interior wall surfaces adjacent to specified shear walls shall be sheathed for full length per Shear Wall Type 6 or with gypsum board of same thickness to provide an even wall surface for finish materials.
- S9. Anchor bolts to have 0.229" thick x 3" square plate washer at foundation sill plates. The edge of the plate washer shall extend to within  $\frac{1}{2}$ " of the sheathed edge of the sill plate. A diagonal slot is permitted on the plate washer. The slot shall be  $\frac{3}{16}$ " greater than the bolt diameter and no more than  $1\frac{3}{4}$ " in length. A standard cut washer shall be used between the plate and the nut.
- S10. No openings are allowed in Shear Walls unless shown on the Structural plans. Coordinate any openings not shown with the Structural Engineer.
- S11. Nails used at pressure treated sill plates & studs shall be hot dipped galvanized. S12. Provide a double stud where 10d common nails have a spacing tighter than 4" oc.
- **IV. Foundation Notes:** F1. Refer to sheet **S0.1** & **S1.1** for typical notes and details.
- F2. Site preparation and building pad construction shall be in accordance with
- foundation notes on sheet **S0.1**.
- F3. Structural wall studs, including bearing walls and exterior walls, shall be 2x6 @ 16"
- F4. All exterior walls to have sheathing per SW Type 6.
- F5. Verify all slab dimensions, including depressions, curbs and pads with architectural and mechanical drawings. Notify Architect and Structural Engineer of any discrepancies prior to construction.
- F6. Elevations shown on structural drawings are relative the top of slab-on-grade elevation of 0'-0". Coordinate all elevations with architectural and civil drawings.
- Notify Architect and Structural Engineer of any discrepancies prior to construction. F7. Contractor to field verify (E) floor framing size direction, spans and bearing locations prior to construction. Contact engineer if (E) conditions do not match plan.
- F8. All Interior (N) walls to be metal stud wall per 2|\$1.3.
- F9. 4" thick concrete slab on grade reinforced w/ #4 @ 18" OC centered in slab w/ 10mil vapor retarding membrane o/ $\frac{3}{4}$ " crushed rock.

V. Grade Beam Schedule:									
GB1	= 18" W x 18"D CONT FTG w/ (3) #5 CONT TOP & BOT w/ #3 TIES @ 12" OC UNO								
CF1	= 16" W x 12" D CONT FTG w/ (2) #5 BARS TOP & BOT w/ 3 TIES @ 18" OC								
CF2	= 12" W x 12" D CONT FTG w/ (2) #5 BARS TOP & BOT w/ 3 TIES @ 18" OC								

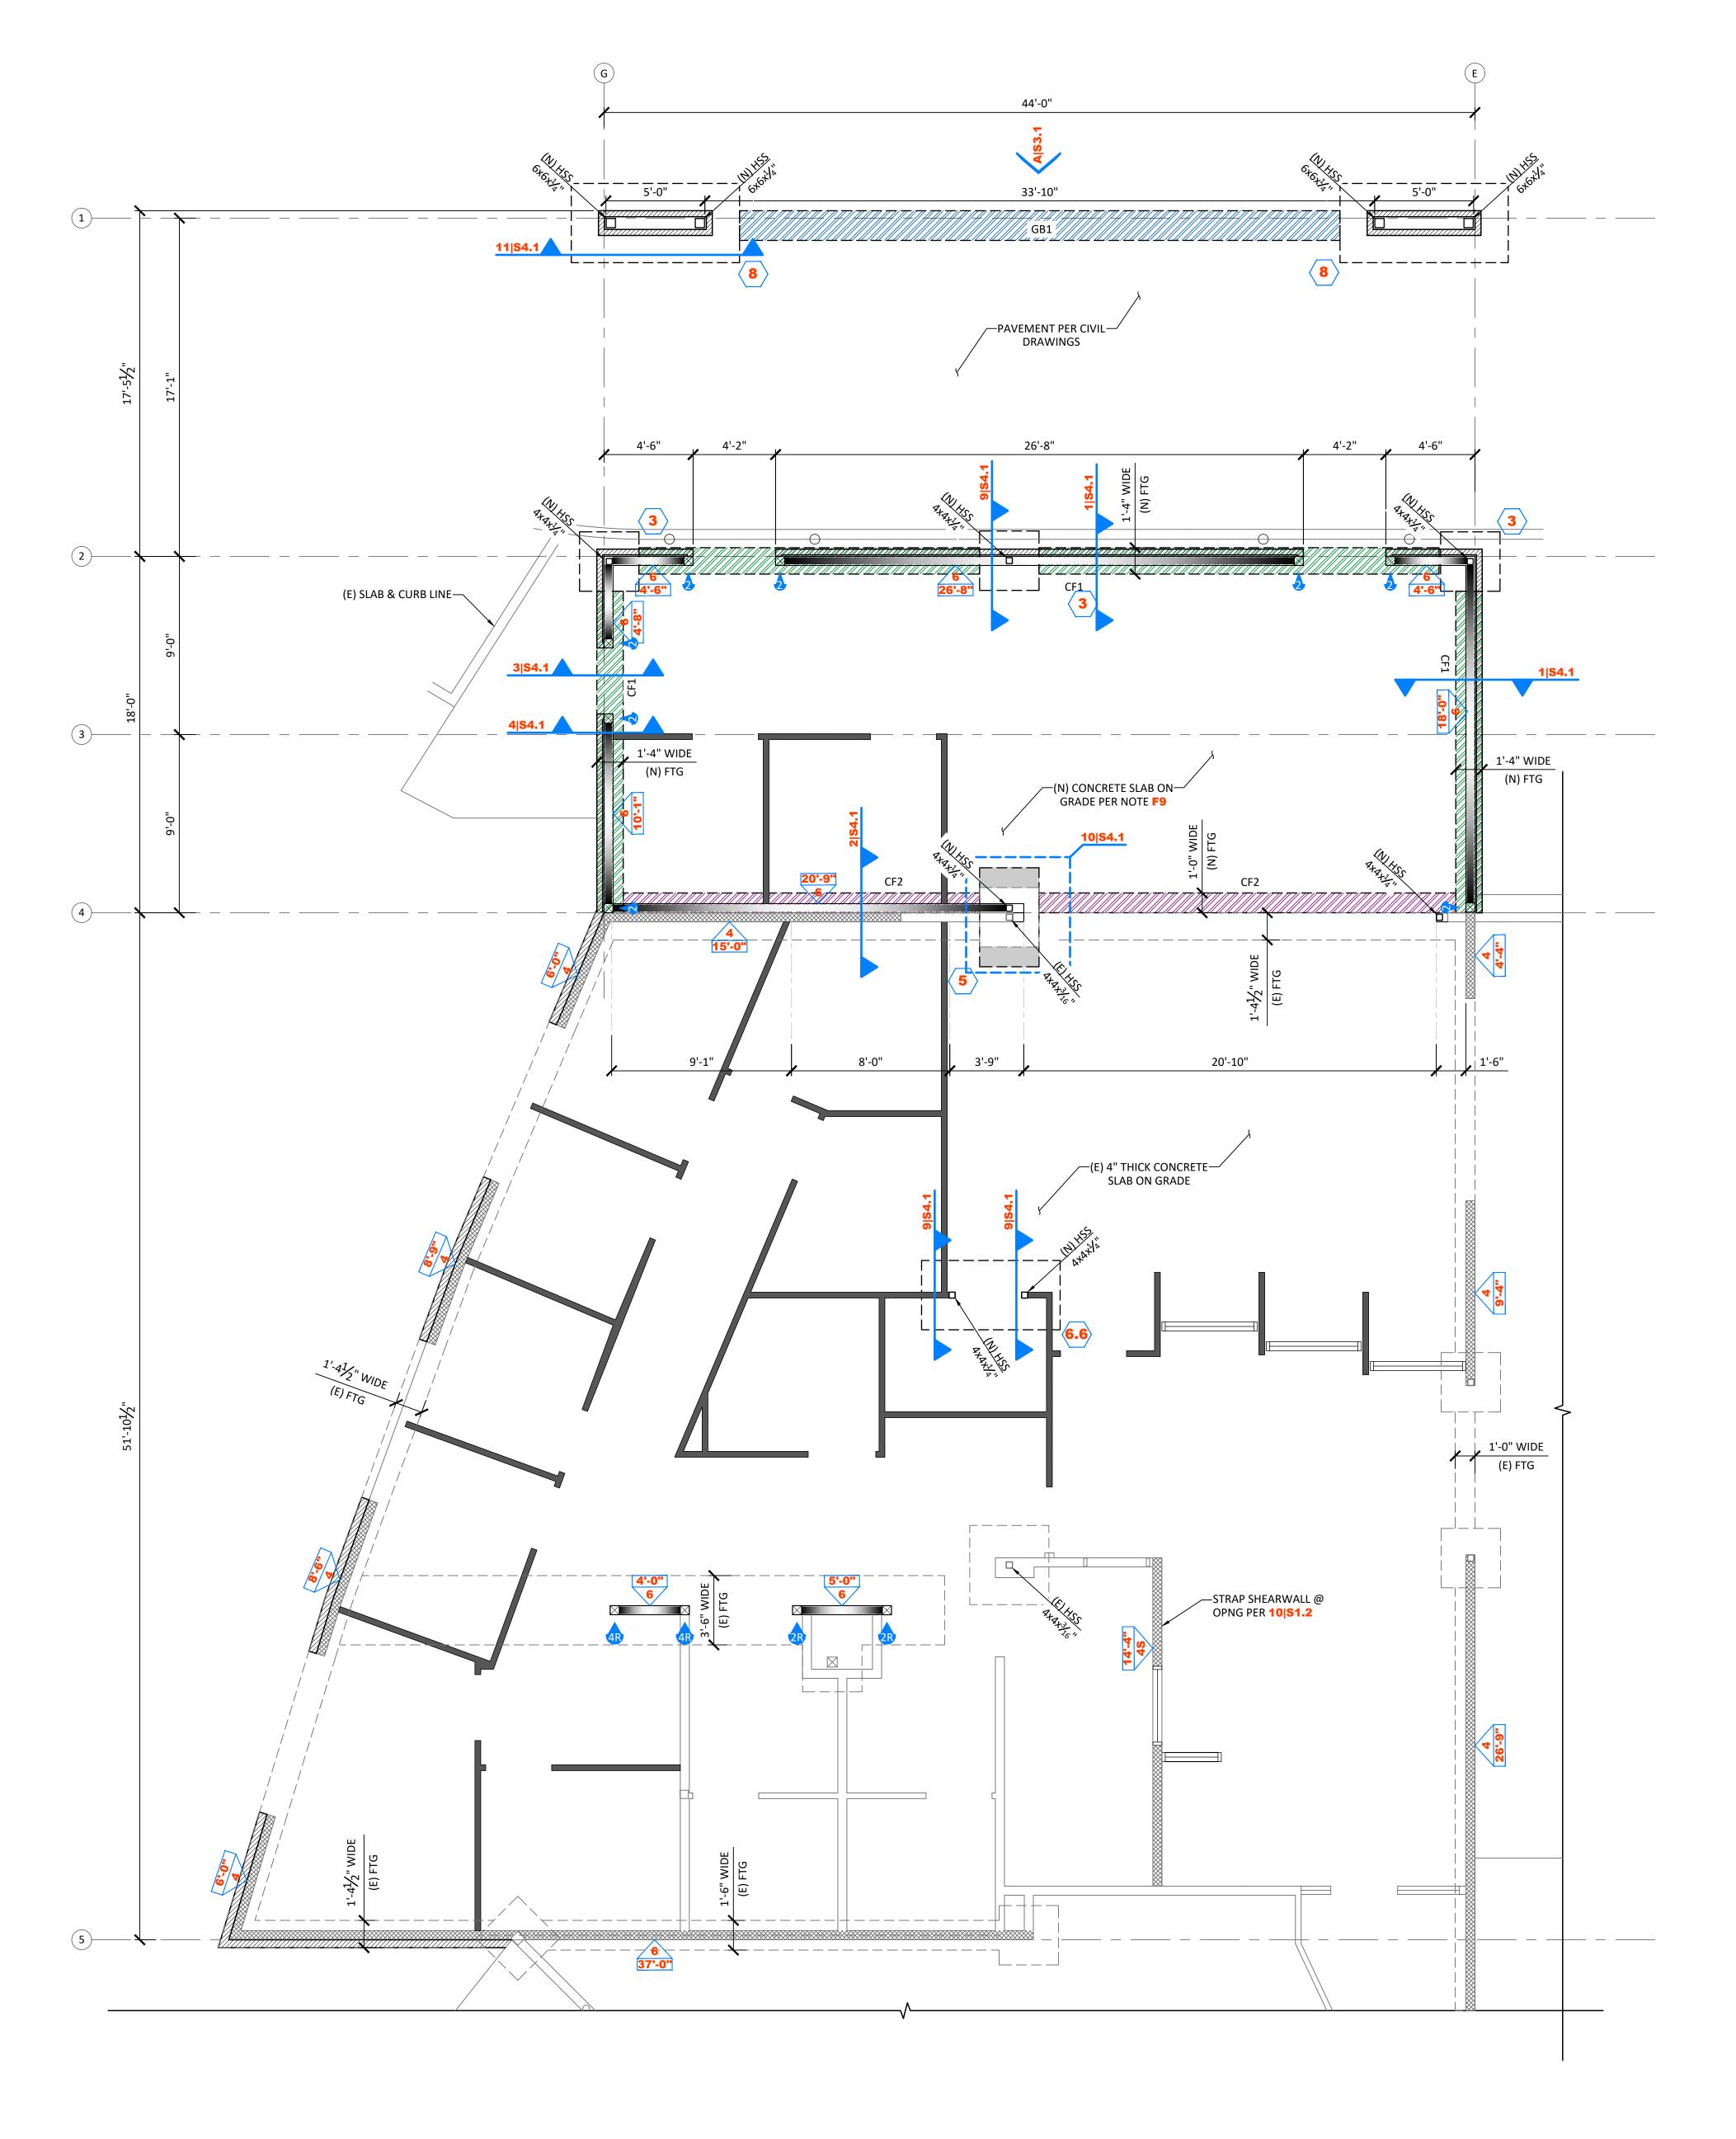





Oroville, CA 95965

FEATHER RIVER TRIBAL HEALTH 2145 Fifth Avenue


Feather River Tribal Health Center -Pharmacy Addition and Remodel

Construction Document

Architect of Record



Carmichael, CA 95608 Phone: 916.680.9922 RSE Project No. 22434

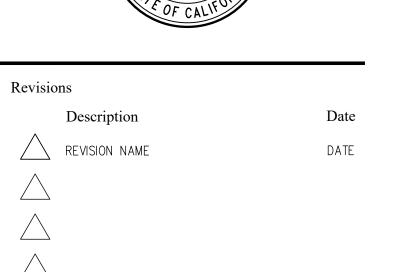

Approvals

Permit No.:

Key Plan

KAP Job No. 463.01 Scale: As Noted Date: 27 December 2022 Drawn By: ANR Checked By: JMI

Sheet Name

**FOUNDATION** PLAN

Sheet Number

S2.1

I. Legend:	
[====]	(E) WALL BELOW
	(N) WALL ABOVE
[]]]]]	(N) WALL BELOW
200000001	(N) METAL STUD WALL BELOW
<i>V72/72/7</i> 2	(N) BRICK VENEER BELOW
0	(N) STEEL COLUMN BELOW
	(E) STEEL COLUMN BELOW
	(E) SHEARWALL VIF
	(N) SHEARWALL BELOW
	(N) BEAM
	TRUSS BLOCKING
	DENOTE BRACE FRAME


### **II. Roof Framing Notes:**

- R1. Refer to sheets **\$0.1,\$0.2** & **\$1.2** for typical notes and details.
- R2. Roof sheathing to be <sup>19</sup>/<sub>32</sub>" APA rated Sheathing (40/20) Exp 1 nail with 10d @ 6" OC edges & 10d @ 12" OC field UNO. No panels less than 24" wide shall be used. Block all edges w/ 2x3 flat.
- R3. Verify all opening dimensions with architectural and mechanical drawings.

  Mechanical unit locations and weights to match mechanical drawings.

  Notify Architect and Structural Engineer otherwise.

III. 9	Strap Schedule:							
	INDICATES CENTER OF STRAP UNO							
1	(S) MSTC52 VERT CTRD o/ RIM							
2	(S) CS16 x 8'-0" W/ 10d @ 3" OC STGRD TO BLKG PANELS OR 2x FLAT BLKG							
3	(S) CS16 x 16'-0" W/ 10d @ 3" OC STGRD TO BLKG PANELS OR 2x FLAT BLKG							
4	(S) CMST14 x 22'-0" w/ 10d @ 3" OC STGRD TO BLKG PANELS OR 2x FLAT BLKG							

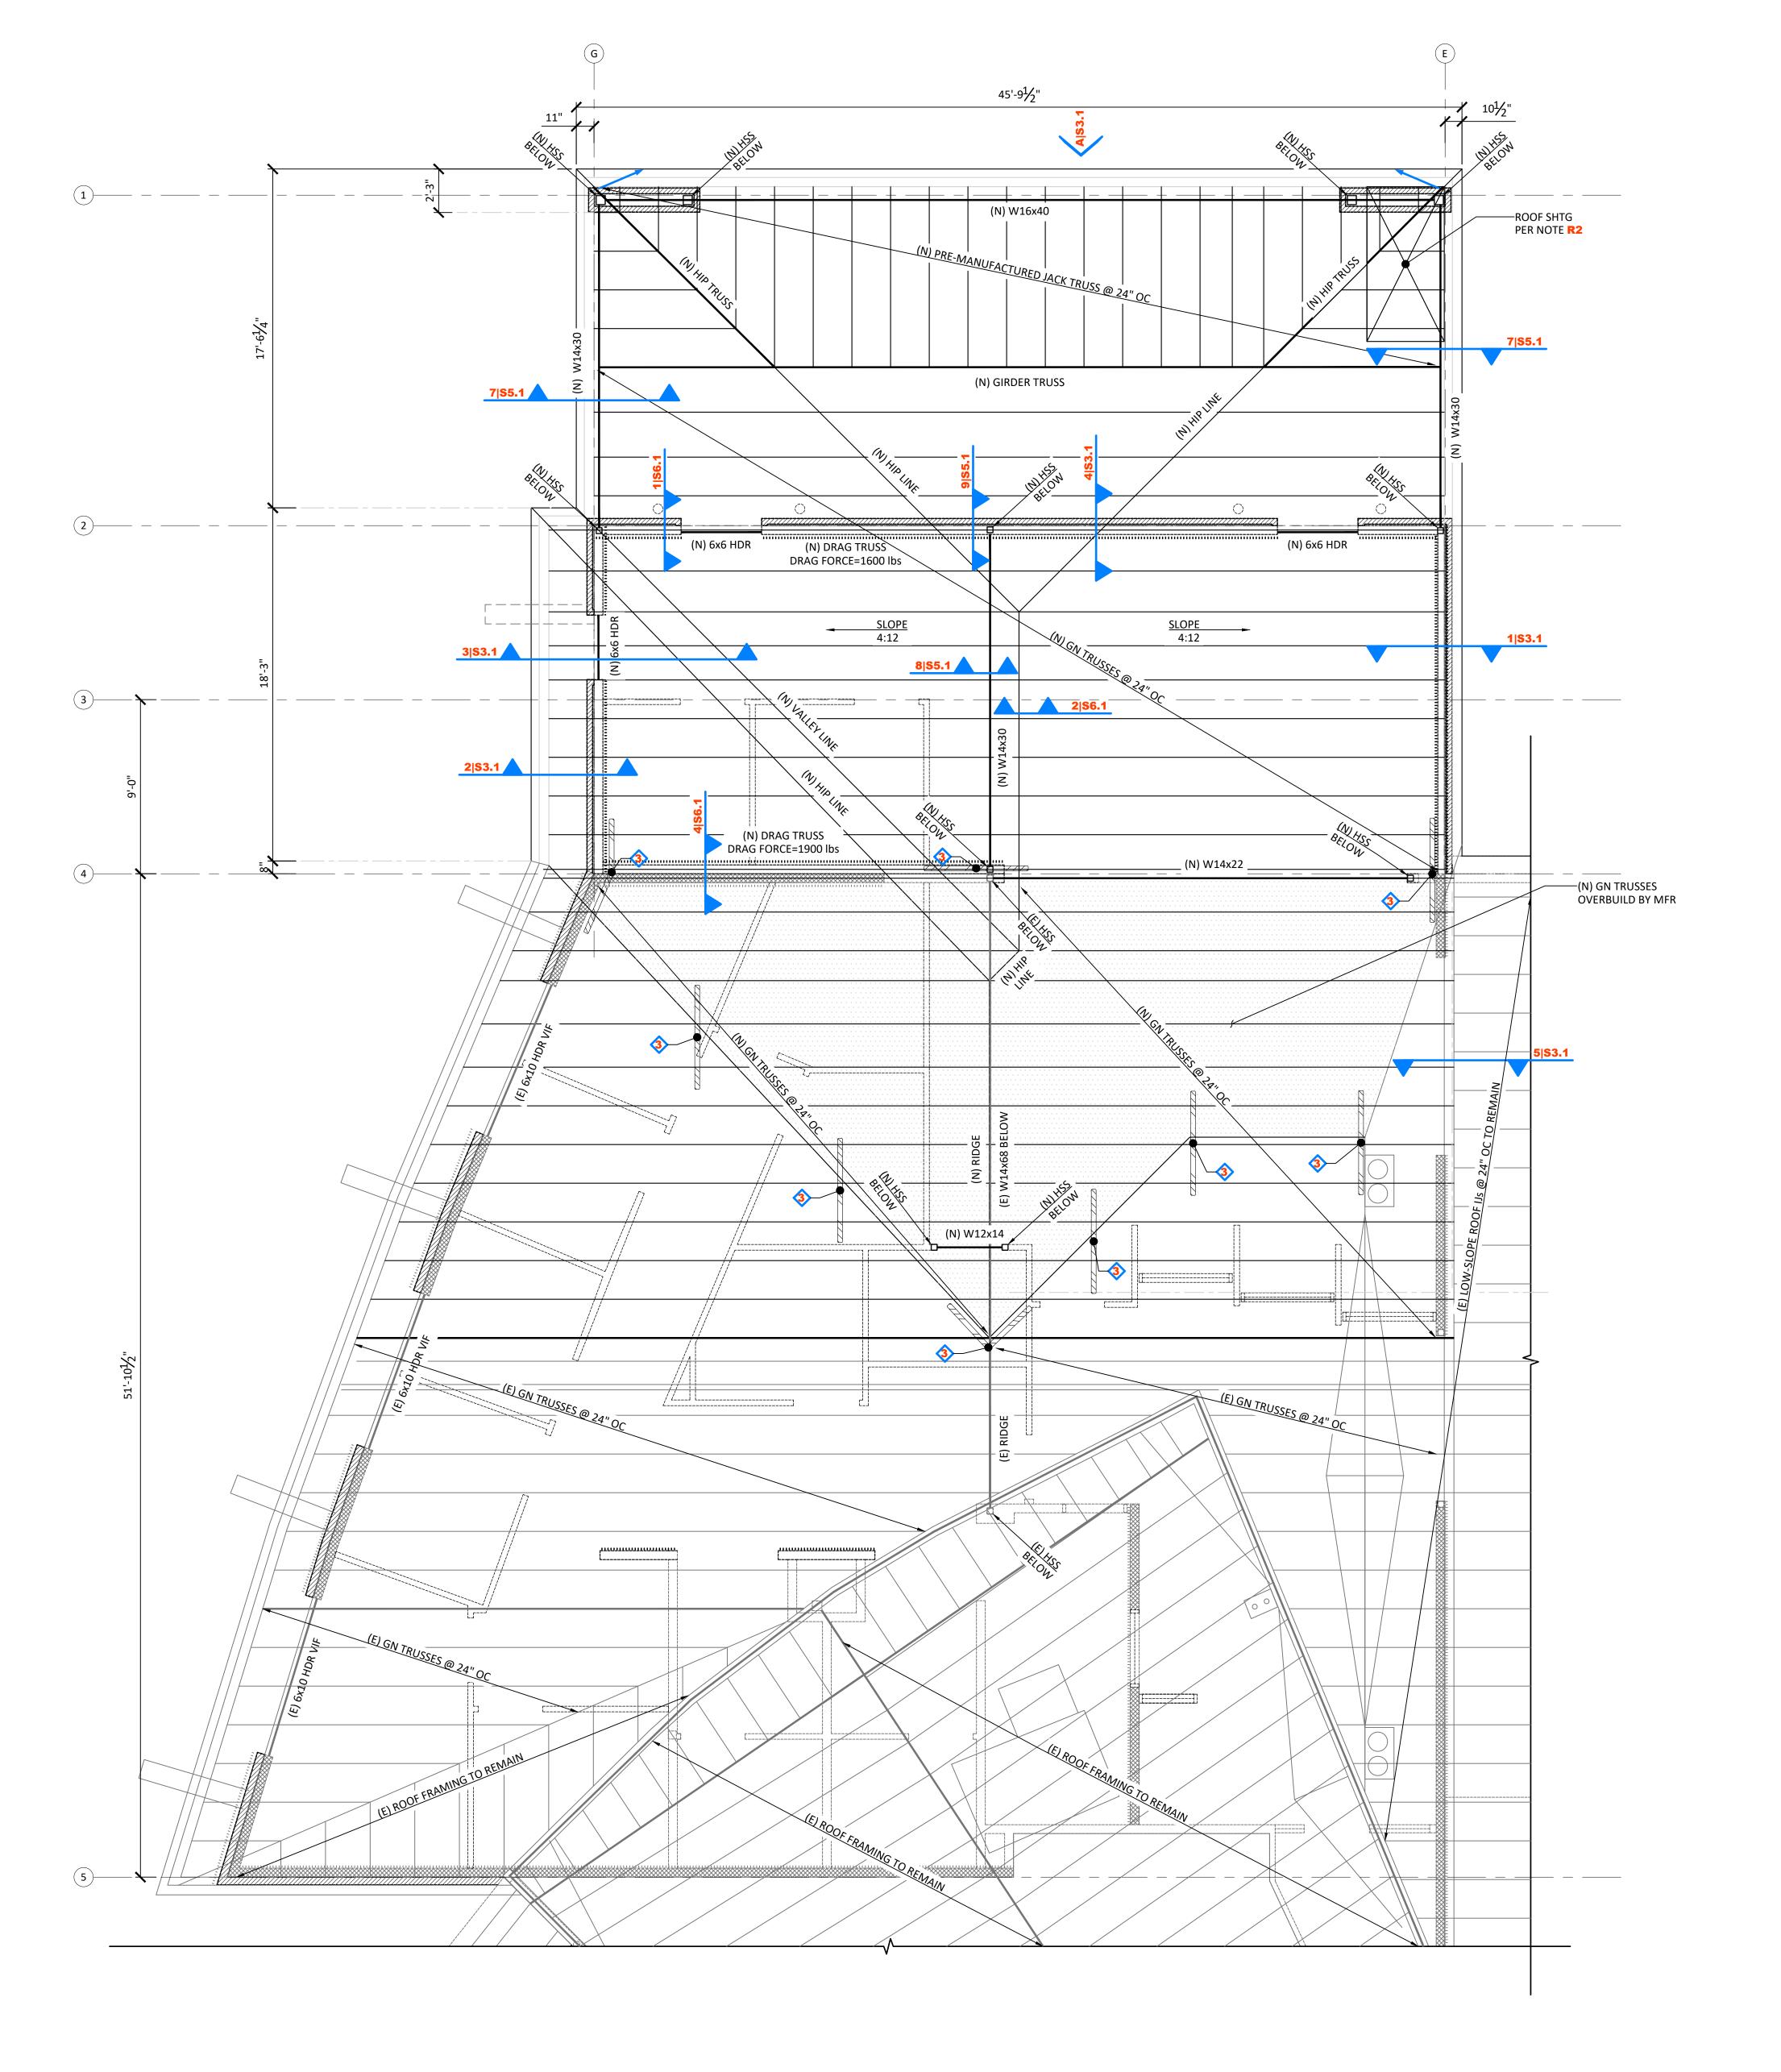





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# FEATHER RIVER TRIBAL HEALTH 2145 Fifth Avenue

Oroville, CA 95965

Project Name:

Feather River Tr

Feather River Tribal
Health Center Pharmacy Addition
and Remodel

Submittal:

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Carmichael, CA 95608
Phone: 916.680.9922
RSE Project No. 22434

PROFESSIONAL

NO. S5409
EXP. 9/30/23

PUCTURE

REP. 9/30/23

Revisio	ons							
	Description REVISION NAME							
$\triangle$	REVISION NAME	DATE						
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Approvals

Permit No.:

Key Plan

N.T.S

KAP Job No. 463.01

Scale: As Noted

Date: 27 December 2022

Drawn By: ANR

Checked By: JMI


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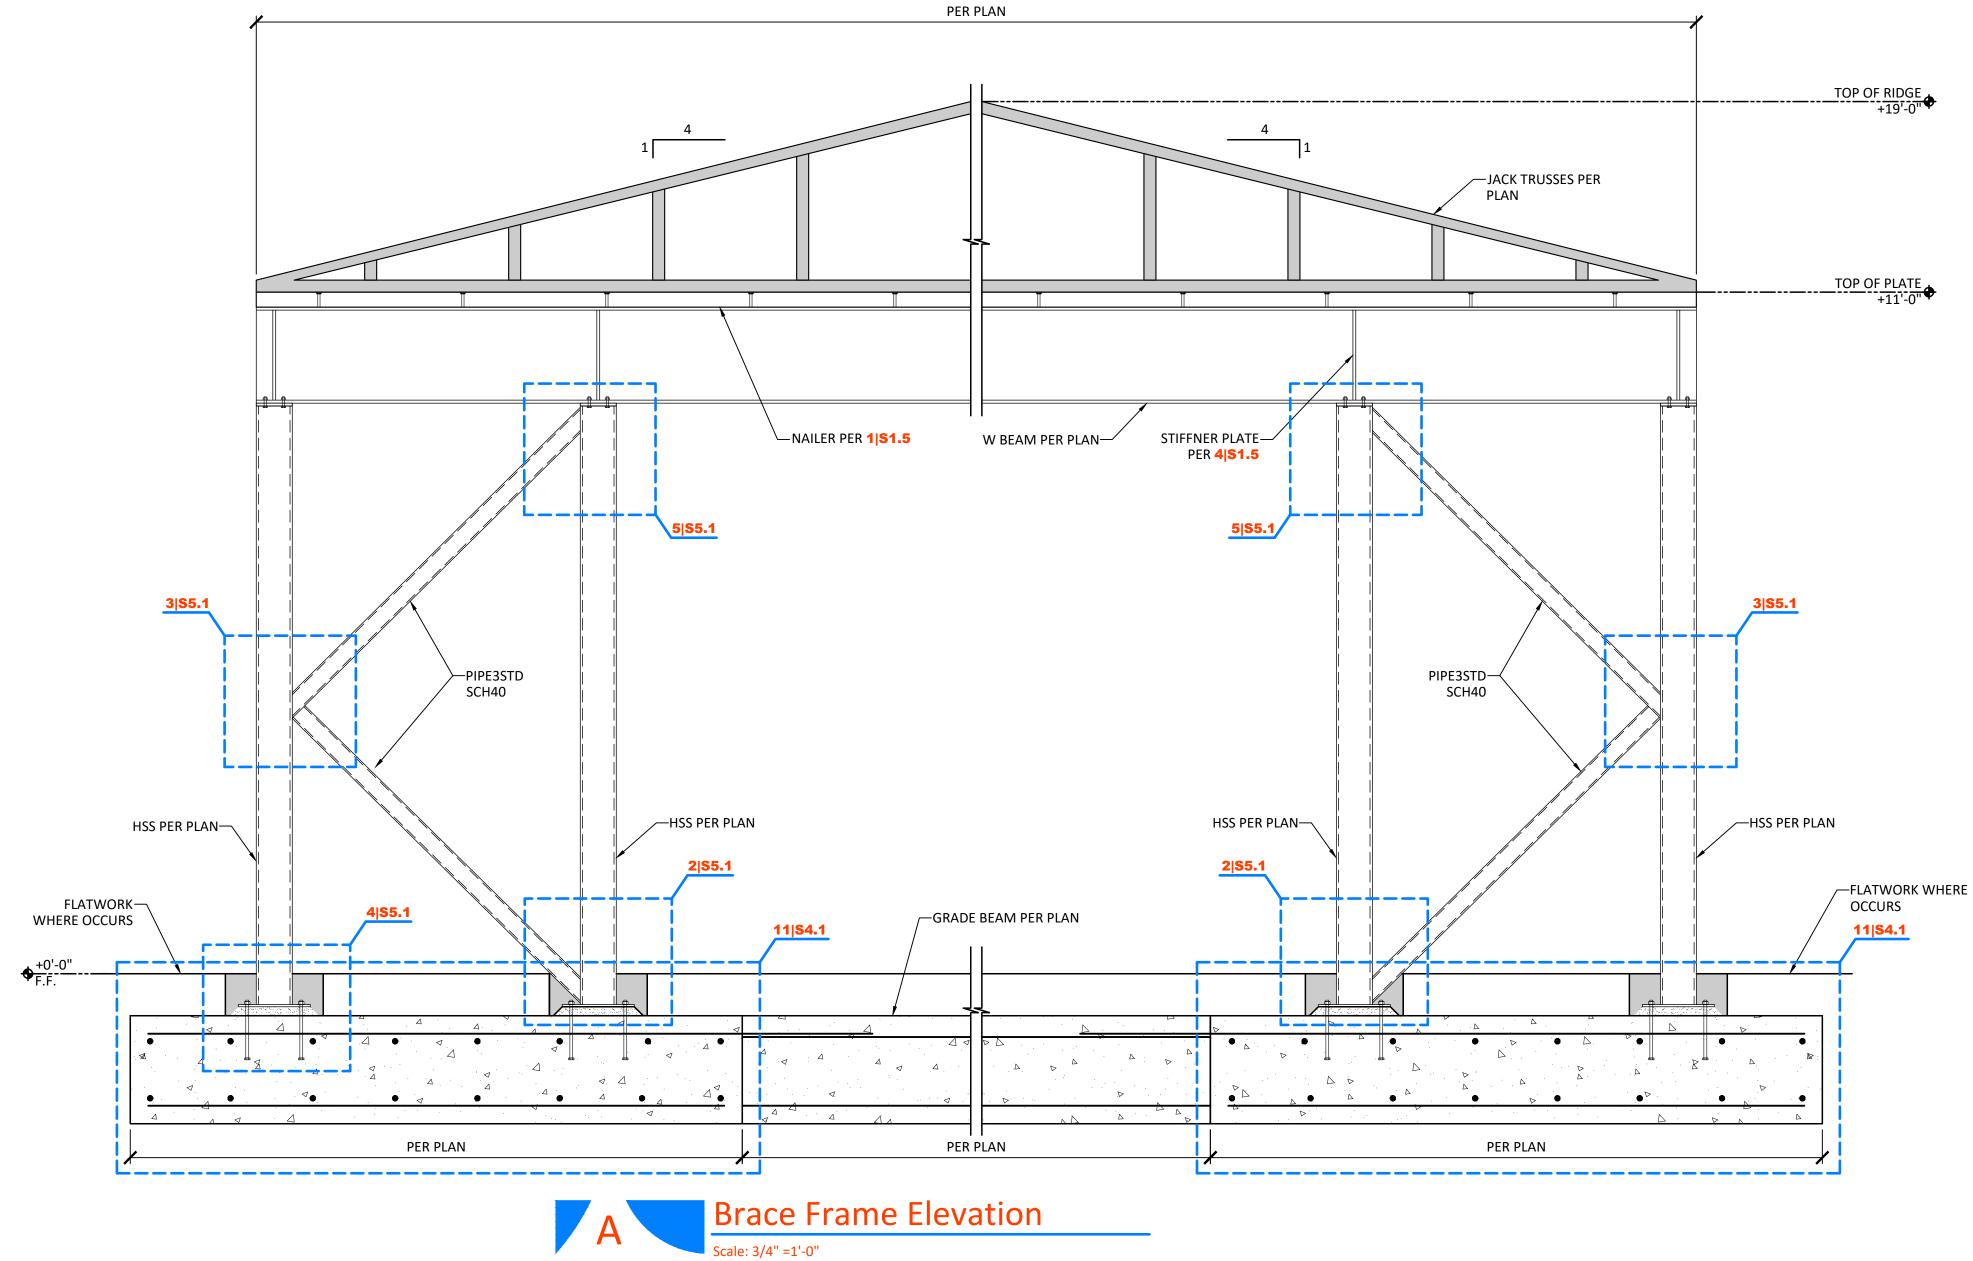
ROOF FRAMING PLAN


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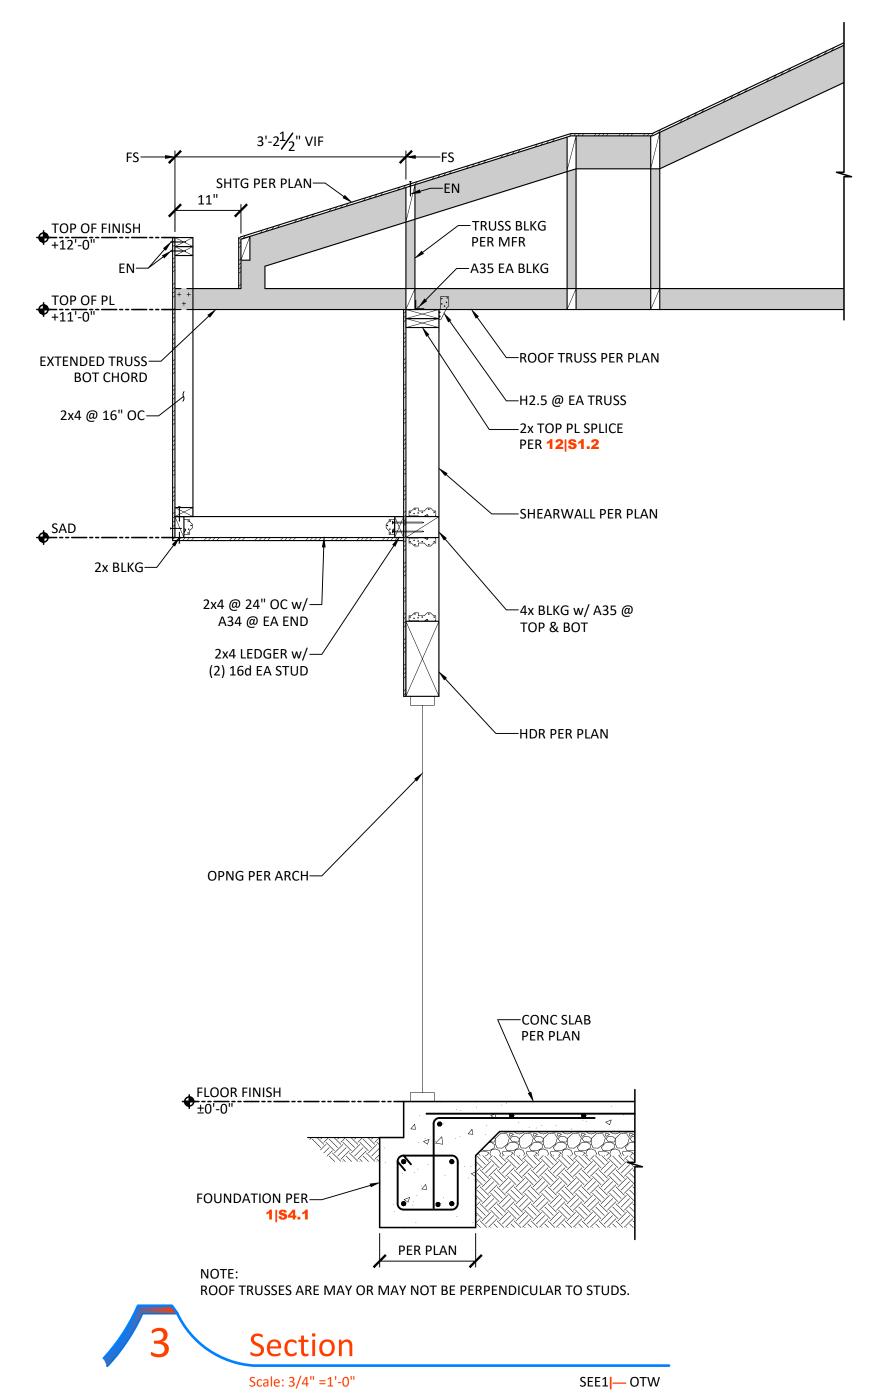
S2.2








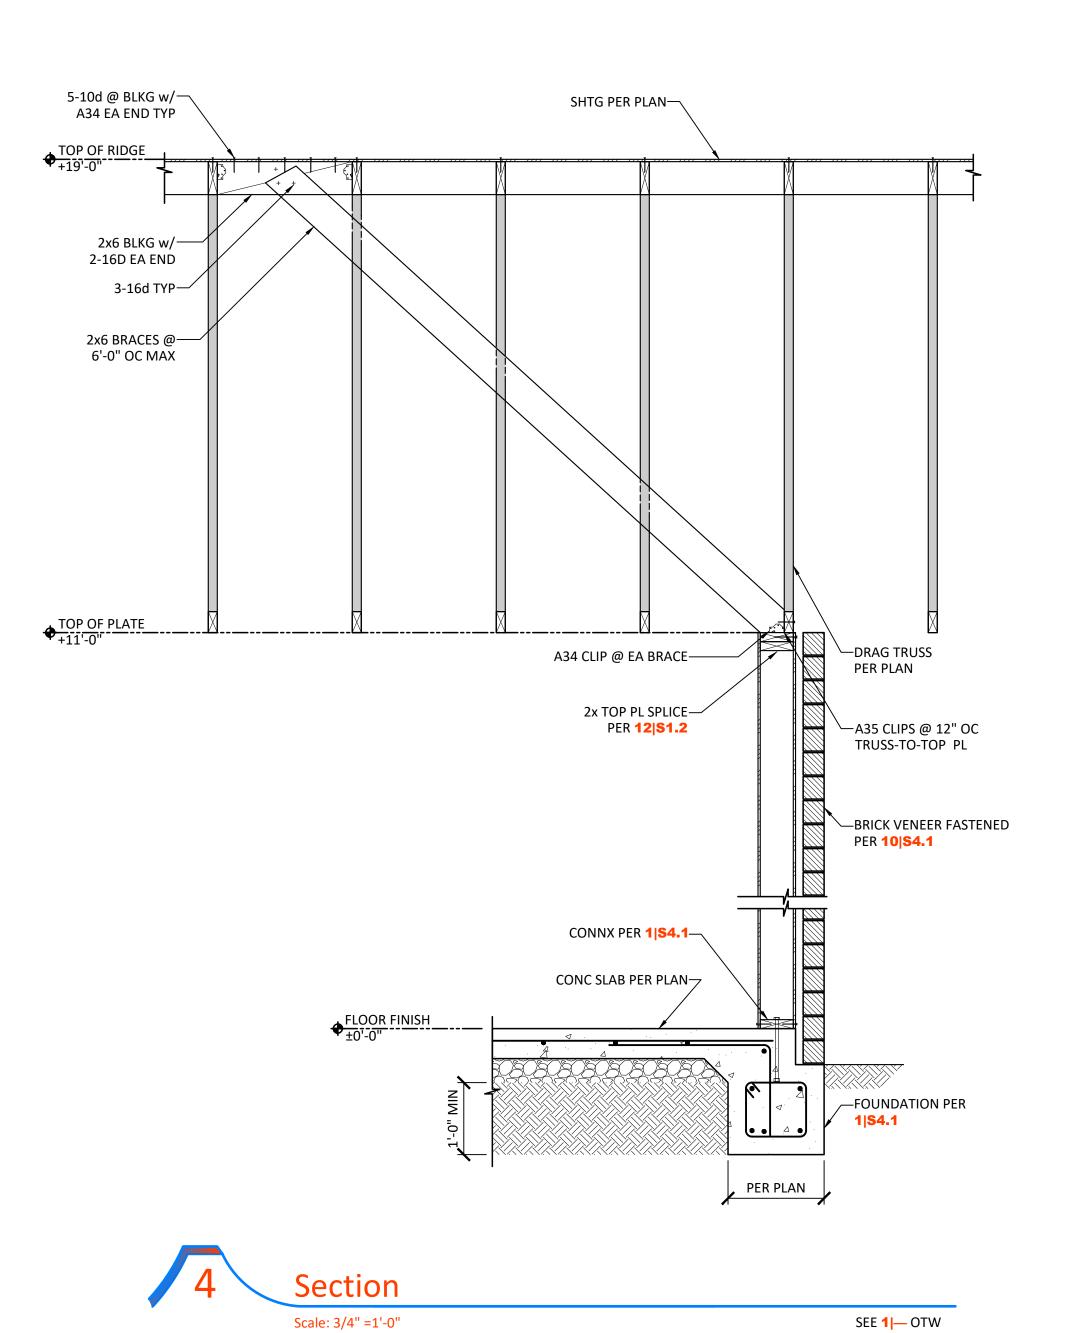

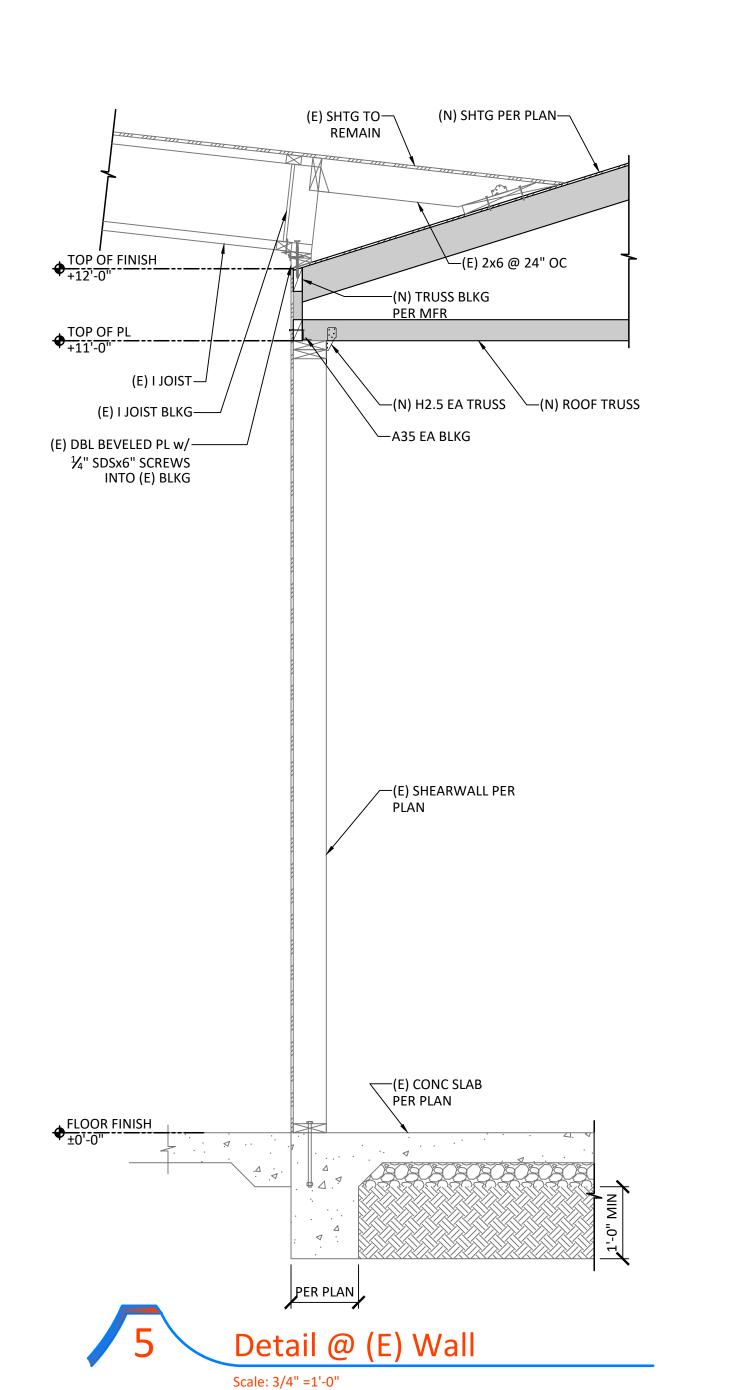

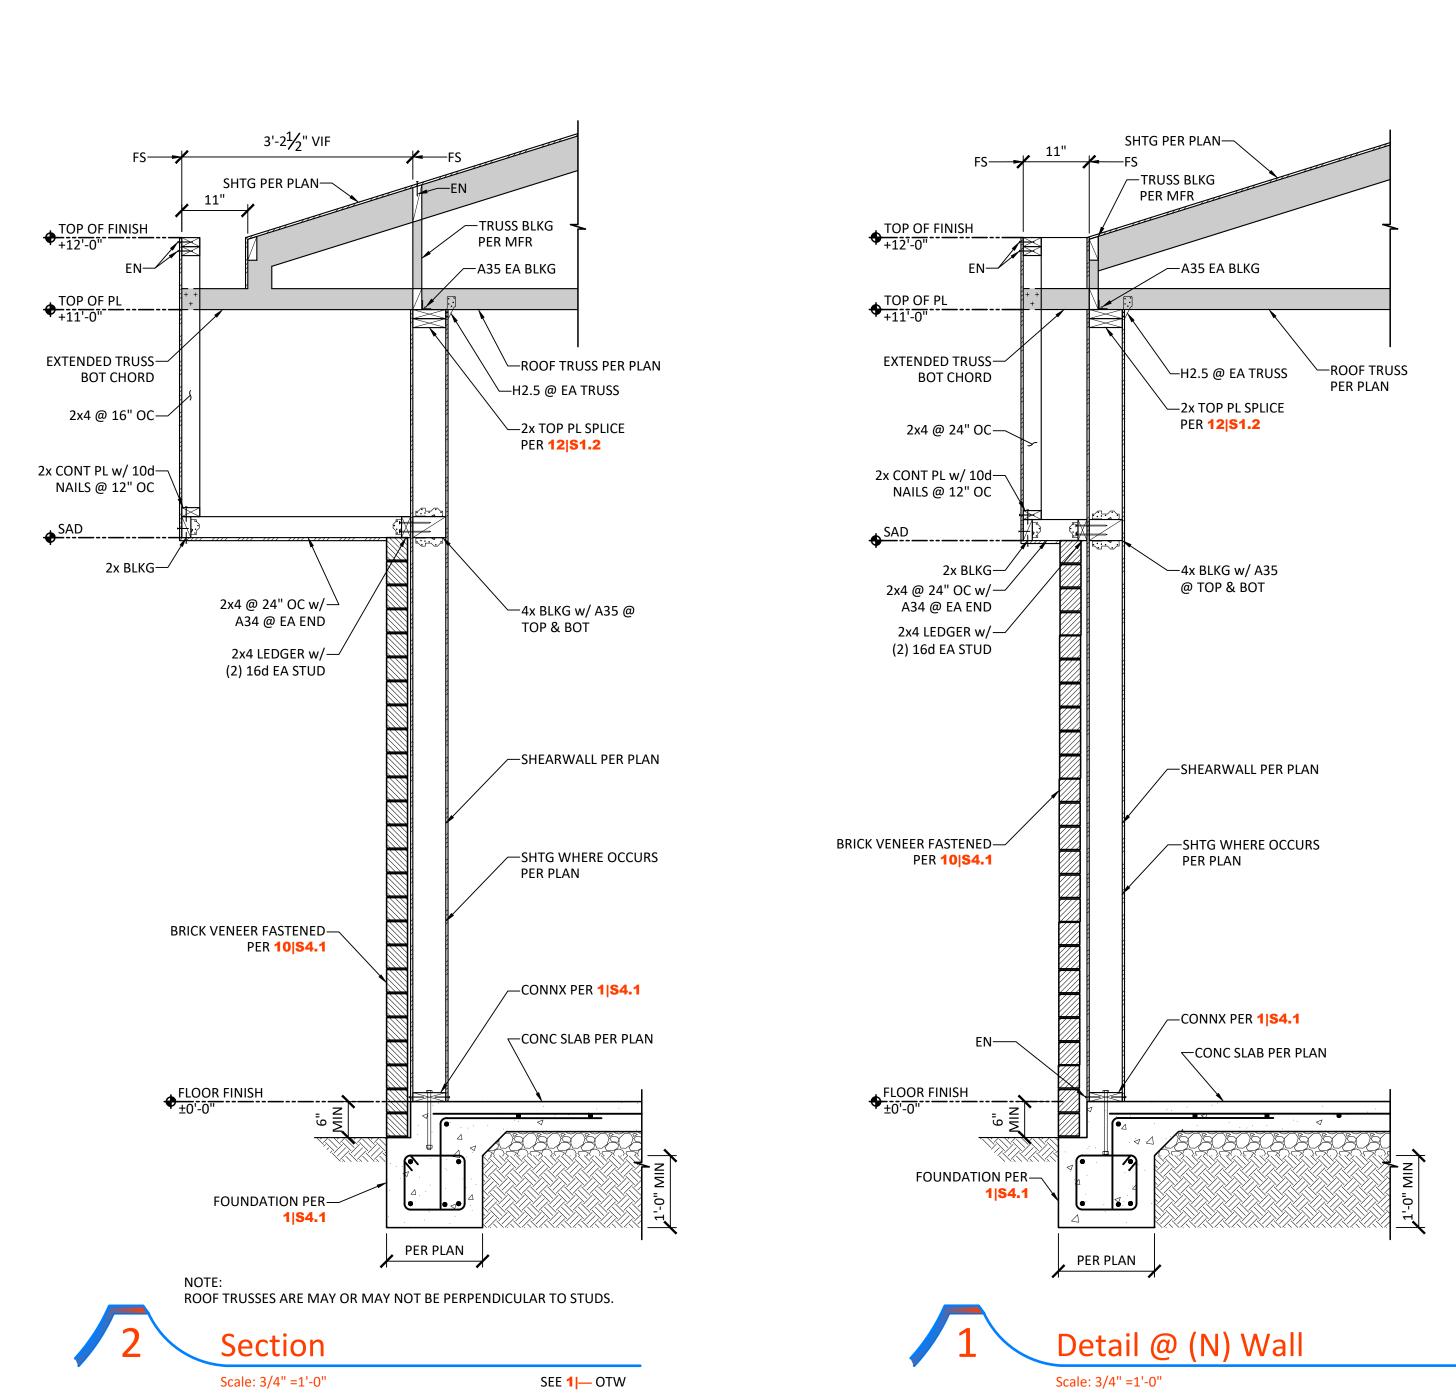



KAP Job No. 463.01

Scale: As Noted

Date: 27 December 2022

Drawn By: ANR

Checked By: JMI


Sheet Name

ELEVATIONS

Sheet Number

S3.1

& SECTIONS

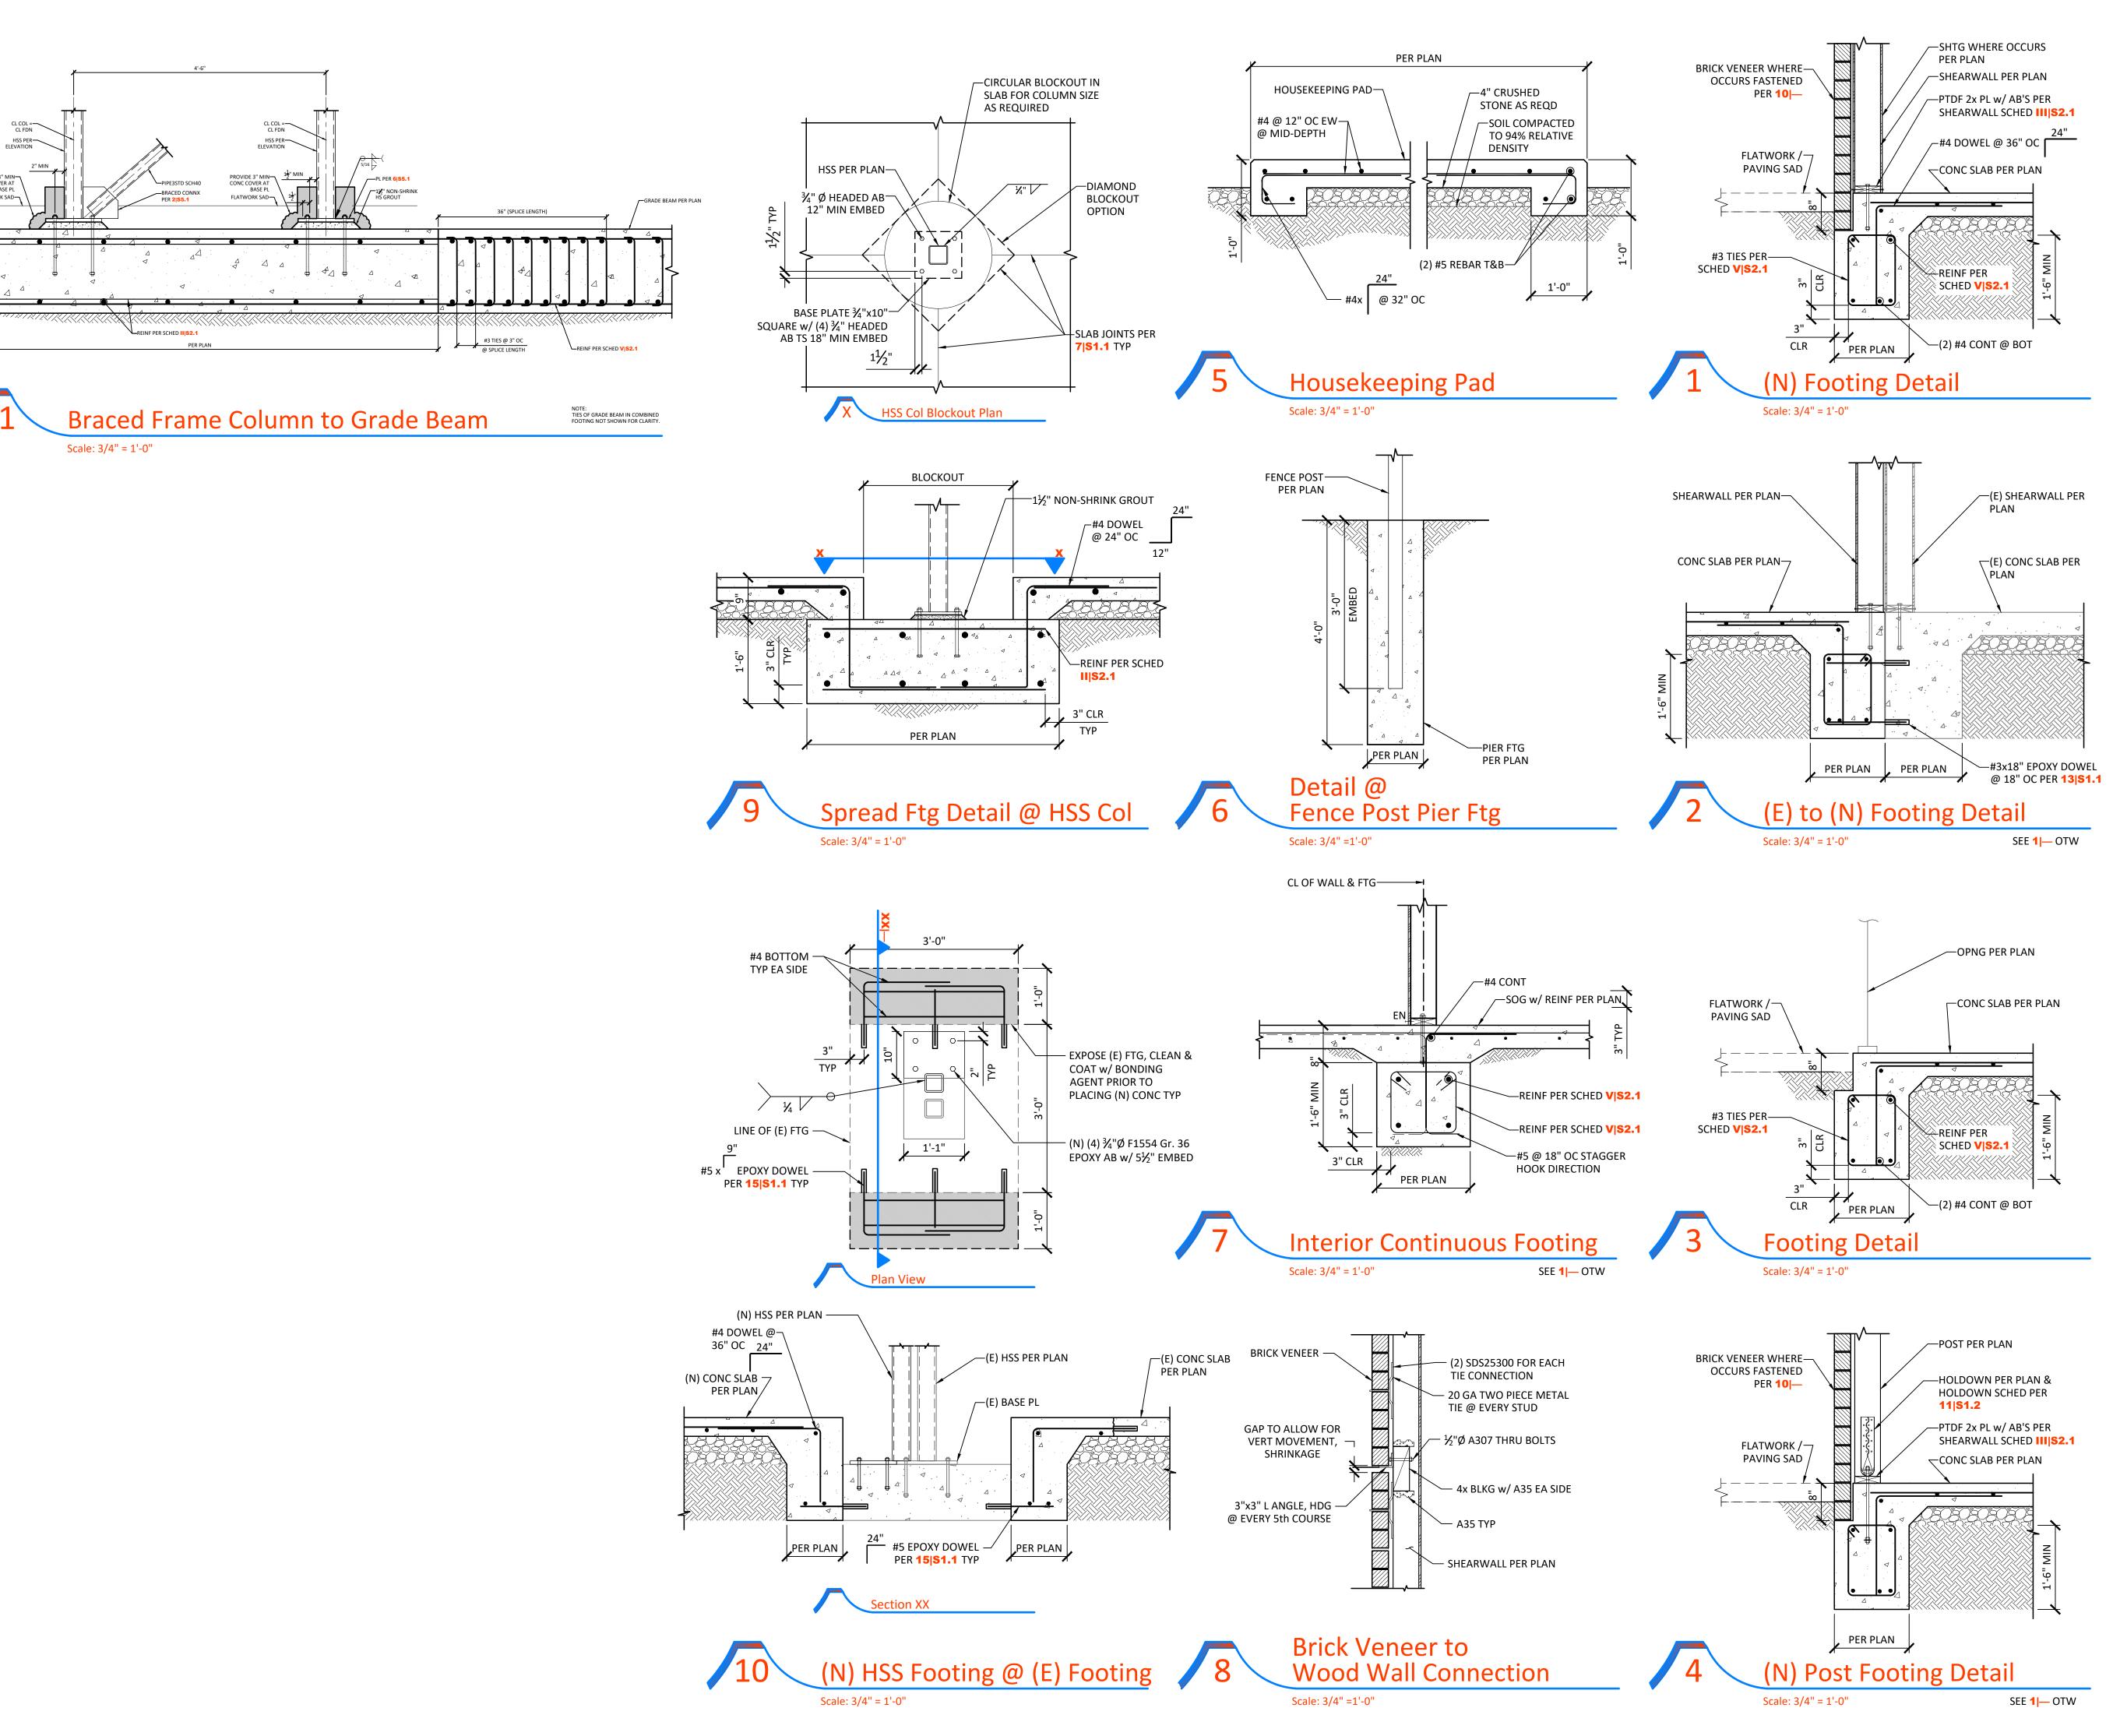

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FEATHER RIVER TRIBAL HEALTH 2145 Fifth Avenue


Oroville, CA 95965

Project Name: Feather River Tribal Health Center -Pharmacy Addition and Remodel

Construction Document

Architect of Record



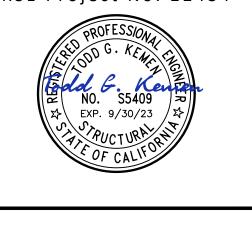

Description	Date
REVISION NAME	DATE
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$\wedge$	

Approvals

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Key Plan

KAP Job No. 463.01 Scale: As Noted Date: 27 December 2022 Drawn By: ANR


Sheet Name


Checked By: JMI

**FOUNDATION DETAILS** 

Sheet Number

**S4.1** 

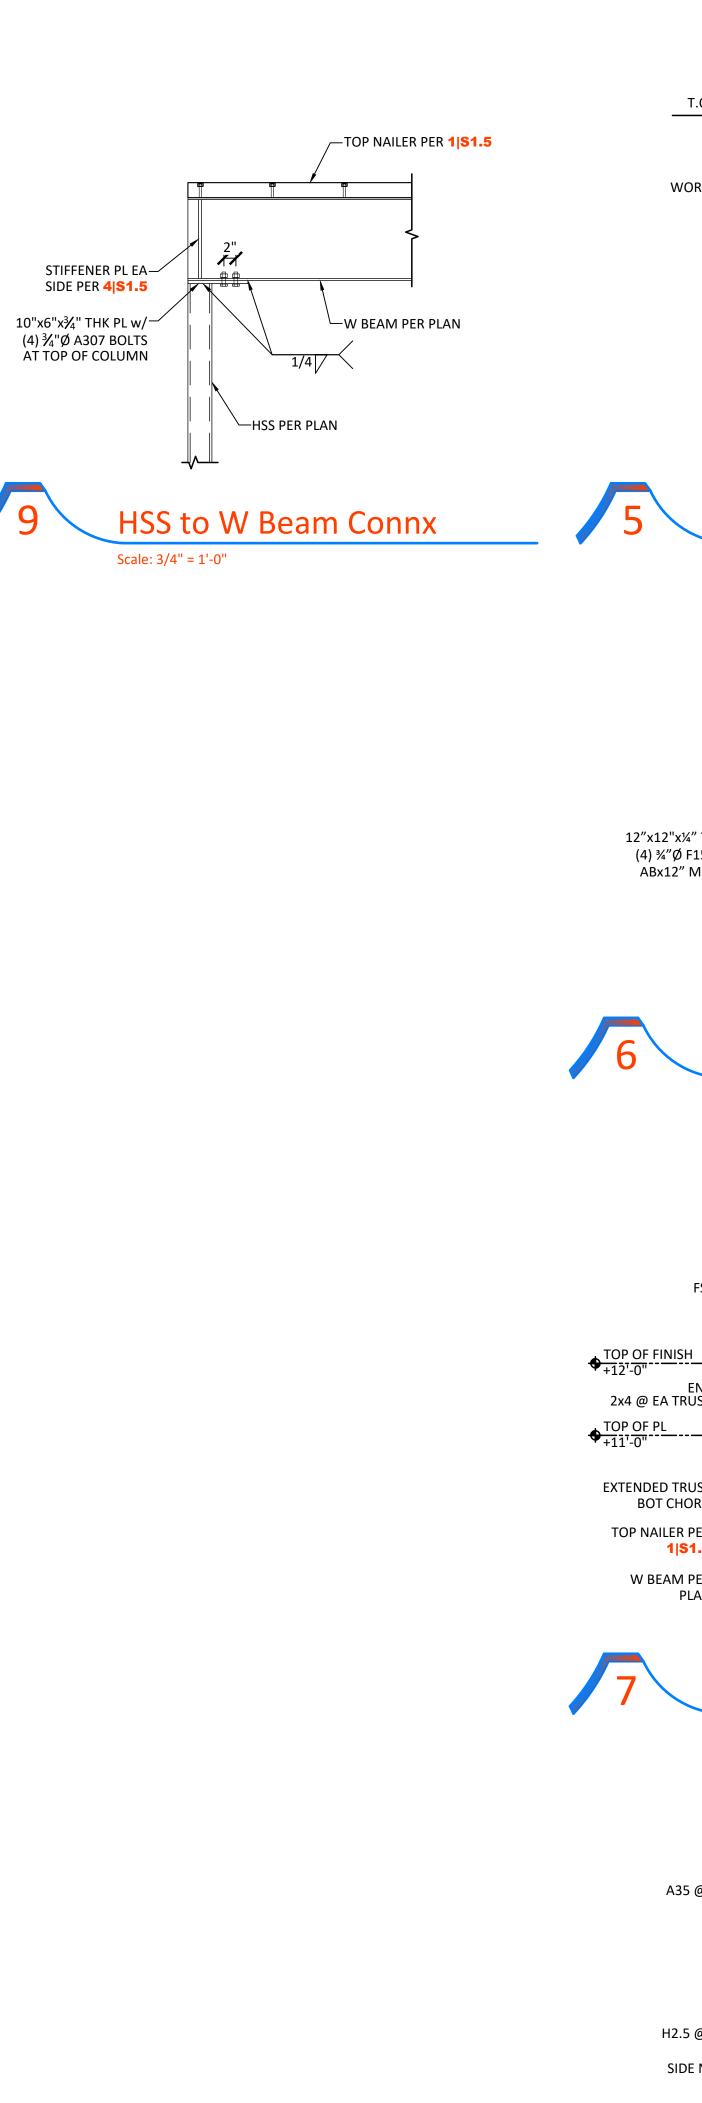

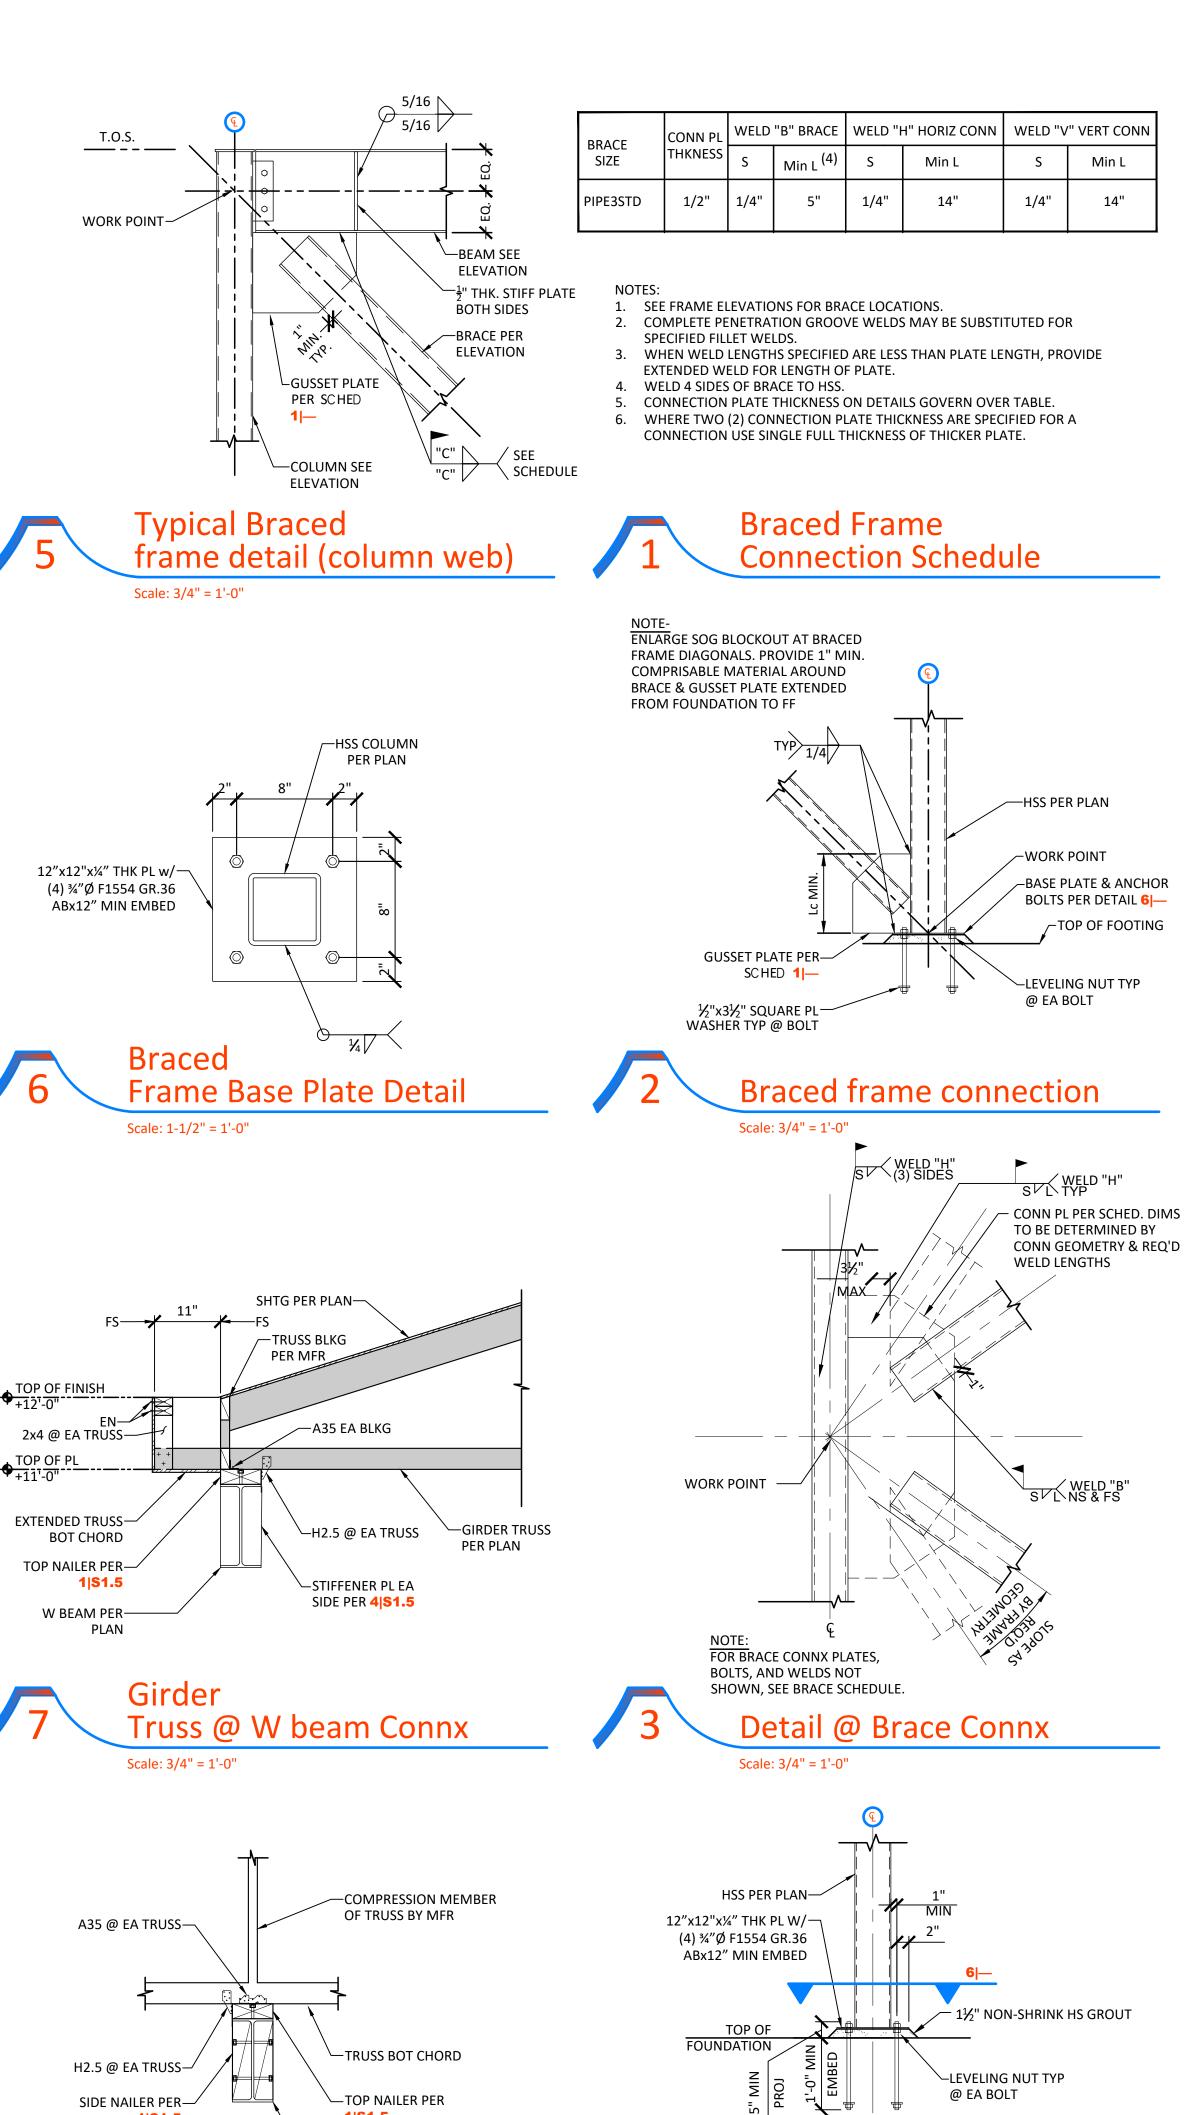

------W BEAM PER PLAN

Scale: 3/4" = 1'-0"

Column to

Scale: 3/4" = 1'-0"

Footing Base PL Connx



.\FRTH logo.PNG

FEATHER RIVER TRIBAL HEALTH


2145 Fifth Avenue Oroville, CA 95965

Project Name: Feather River Tribal Health Center -Pharmacy Addition and Remodel

Submittal: Construction Document

Architect of Record



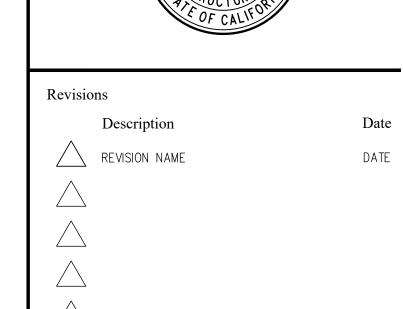

Approvals

Permit No.:

Key Plan




KAP Job No. 463.01 Scale: As Noted Date: 27 December 2022 Drawn By: ANR Checked By: JMI


Sheet Name

STEEL FRAMING **DETAILS** 

Sheet Number

S5.1

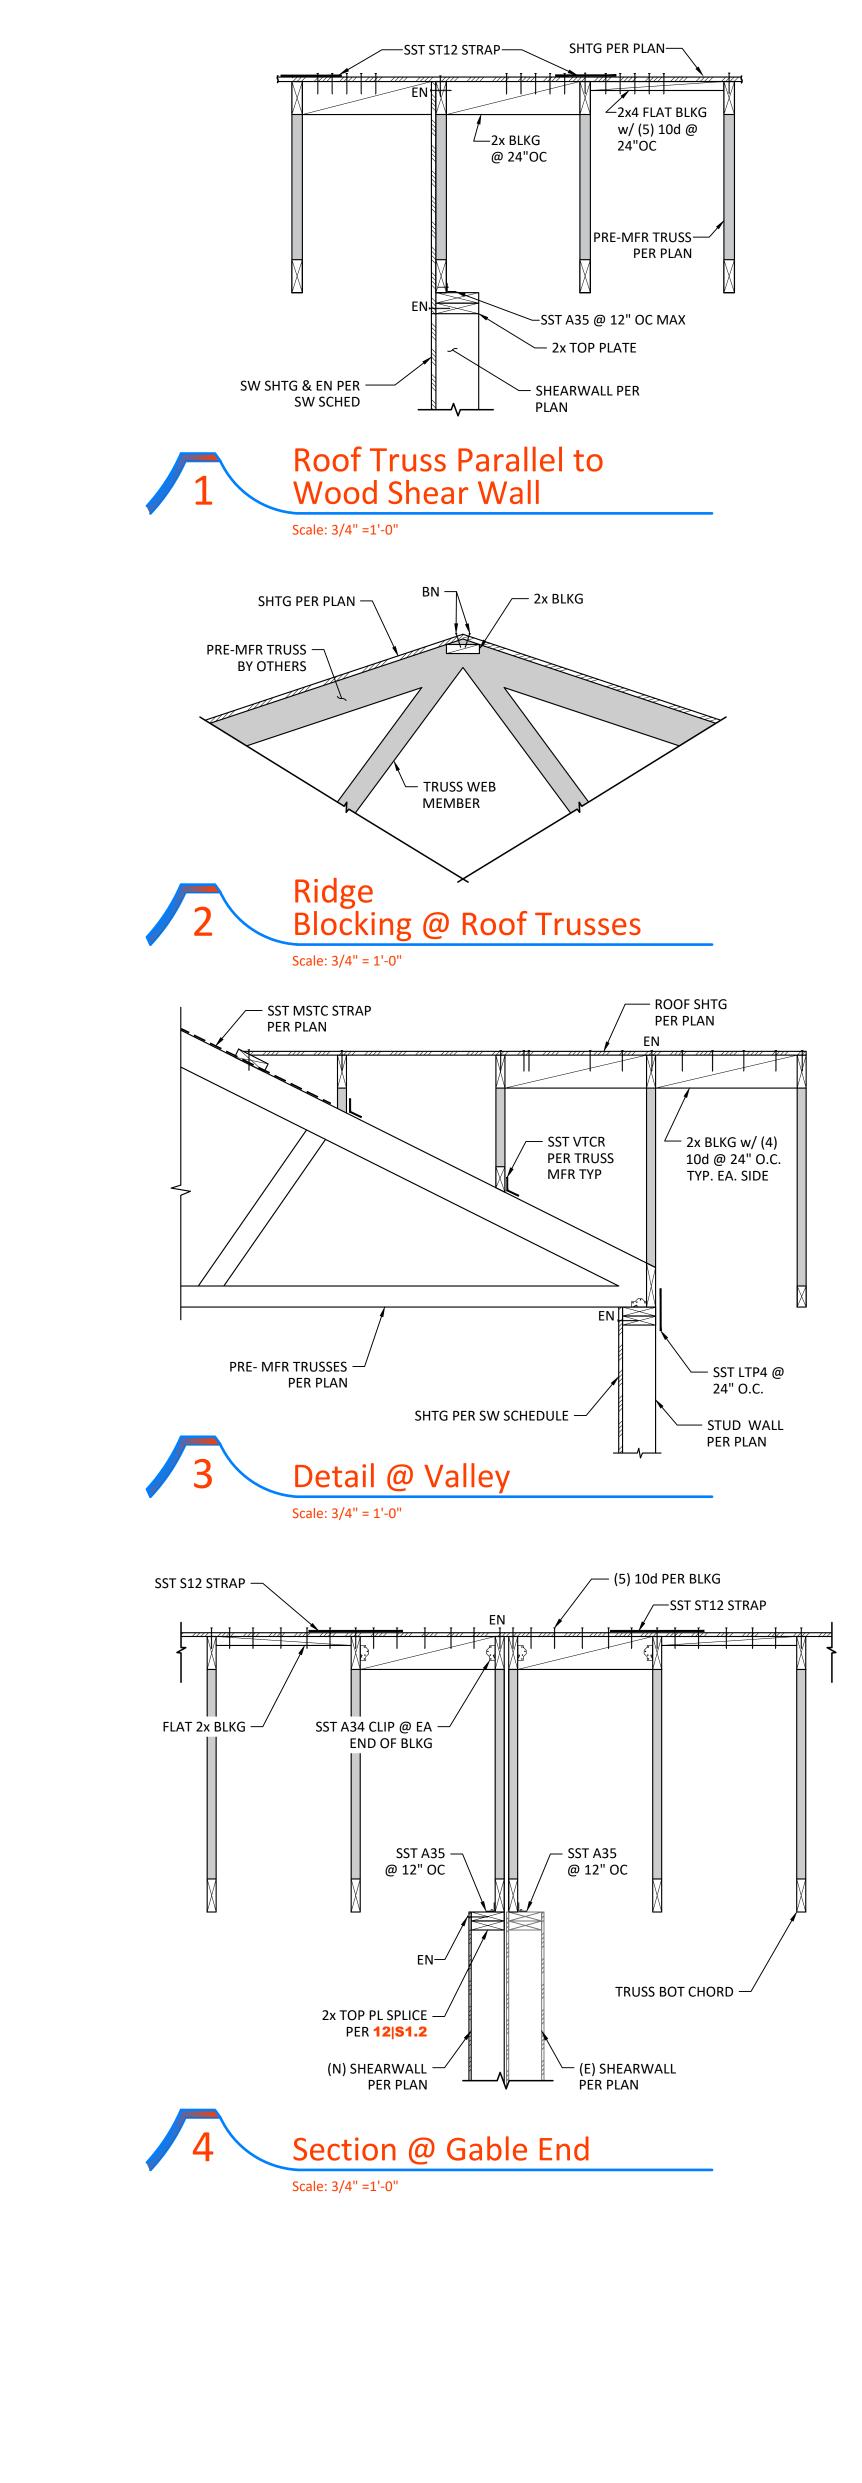

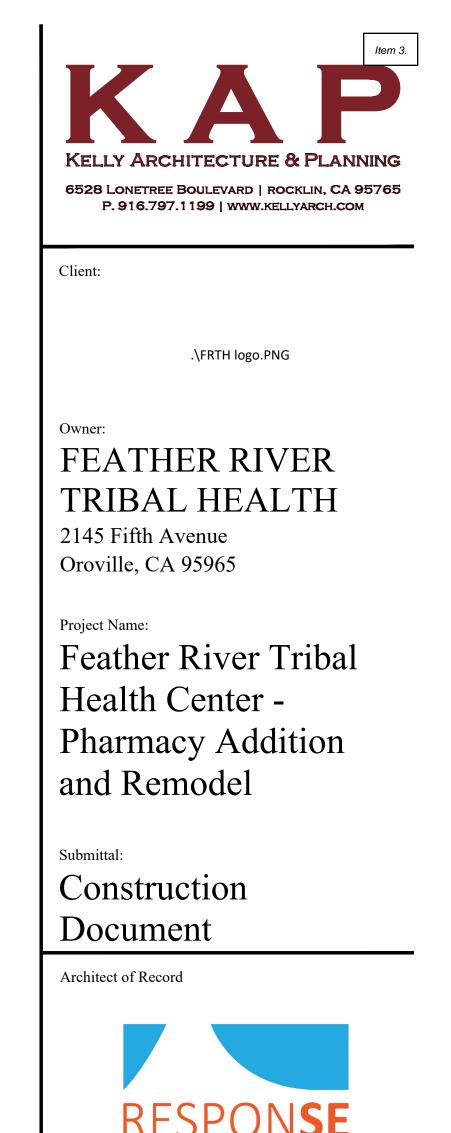

STRUCTURAL ENGINEERS

www.response-eng.com

5441 Fair Oaks Blvd. Teal Park - Suite G2

Carmichael, CA 95608 Phone: 916.680.9922 RSE Project No. 22434

DATE

Revisions

Approvals

Permit No.:

Key Plan

KAP Job No. 463.01

Date: 27 December 2022

**ROOF FRAMING** 

**DETAILS** 

51

S6.1

Scale: As Noted

Drawn By: ANR

Checked By: JMI

Sheet Name

Sheet Number

Description

REVISION NAME

### COMPLIANCE NOTES

MECHANICAL AND PLUMBING EQUIPMENT SHALL CONFORM TO THE FOLLOWING AS STATED IN THE ENERGY EFFICIENCY STANDARDS, 2019.

- 1. BE CERTIFIED BY THE MANUFACTURER AS COMPLYING WITH THE EFFICIENCY REQUIREMENTS AS PRESCRIBED IN SECTIONS:
- 111. APPLIANCES REGULATED BY THE APPLIANCE EFFICIENCY STANDARDS: 112. HVAC EQUIPMENT EFFICIENCY AND PACKAGED CONTROLS:
- 113. SERVICE WATER HEATING EFFICIENCY AND CONTROLS:
- 114. POOL AND SPA HEATING EFFICIENCY AND CONTROLS: 115. RESTRICTIONS ON PILOT LIGHTS:
- 2. BE SPECIFIED AND INSTALLED IN ACCORDANCE WITH SECTIONS.
- 121. REQUIREMENTS FOR VENTILATION:
- 122. REQUIRED CONTROLS FOR HVAC SYSTEMS: 123. REQUIREMENTS FOR PIPE INSULATION:

124. REQUIREMENTS FOR DUCT INSULATION:

MECHANICAL	LEGEND

	RETURN OR OUTSIDE
	SUPPLY DUCT
	TRANSFER OR EXHAUST AIR DUC
 1 MAD	MANUAL AIR DAMPER
$\bigcirc$	THERMOSTAT
U.C.	UNDER CUT DOOR 3/4"
(E)	EXISTING
(R)	RELOCATE
(NI)	NITW

# DIFFUSER, REGISTER, & GRILLE SCHEDULE

**DESCRIPTION** 

CEILING DIFFUSER
TITUS MODEL MCD, TBAR MOUNT FRAME, WHITE FINISH.

<u>CEILING DIFFUSER</u> TITUS MODEL 50F, TBAR MOUNT FRAME, WHITE FINISH.

<u>RETURN GRILLE</u> TITUS MODEL 50F, TBAR MOUNT FRAME, WHITE FINISH.

### GENERAL NOTES

- 1. FLEXIBLE DUCT SHALL BE R-6 RATED AND NOT EXCEED 5'-0" IN LENGTH.
- 2. EXTERNAL DUCT WRAP SHALL BE 2", 3/4 # DENSITY FSK
- 3. ALL SUPPLY BRANCH DUCTS SHALL HAVE A MANUAL VOLUME DAMPER
- 4. DSD DUCT SMOKE DETECTORS EXISTING.
- 5. DUCT CONSTRUCTION SHALL COMPLY WITH THE LATEST SMACNA
- 6. ALL SUPPLY/RETURN PLENUMS SHALL HAVE R4.2 RATED INTERNAL LINER
- 7. PROVIDE PERMANENT IDENTIFICATION ON ALL ROOFTOP EQUIPMENT.
- 8. ALL OUTSIDE AIR INTAKES AND EXHAUST DISCHARGES SHALL HAVE BIRD SCREENS PER CMC 402.4 & CMC 502.1

	EXIS	ROOF	TOP	AC	S	СН	EC	$\bigcup \bigcup$	LE		
TAG	MANUFACTURER	MODEL	COOLING SENSIBLE BTU	HEATING CAPACITY BTU	CFM	OSA	VOLT	MOT(	OR HZ	MIN. CKT AMPS	OPERATING WEIGHT LBS.
(E) AC-11	CARRIER	48HJD012	116,000	180,000	3,200	500	208	3	60	58.3	1435

ROOFTOP AC SCHEDULE								CE	ILING	EXH	AUS7	FAI	V 50	CHE	JUL	E					
COOLING SENSIBLE BTU	HEATING CAPACITY BTU	CFM	OSA	\ (OL T	1	MOTOR  PH   HZ   MIN. CKT		OPERATING WEIGHT LBS.	OPERATING WEIGHT L DC	SYMBOL MANUFACTURER	MODEL	CFM	ESP	SONES (MAX.)	RPM	MOTOR  AMPS VOLTS PH		HZ	OPERATING WEIGHT LBS.		
				VOLT	PH	HZ	AMPS	WEIGHT LBS.								171 141	7	+	' ' '		
116,000	180,000	3,200	500	208	3	60	58.3	1435		CEF-1	BROAN	L150	130	0.375	1.8	640	1.1	115	1	60	23
									_	NOTES:	•					•					


1. PROVIDE WITH FACTORY BACKDRAFT DAMPER AND SPEED CONTROLLER.

**DICKSON** MECHANICAL


Revisions

RIVER TRIBAL HEALTH ADDITION/RENOVATION FEATHER PHARMACY


MECHANICAL SCHEDULES

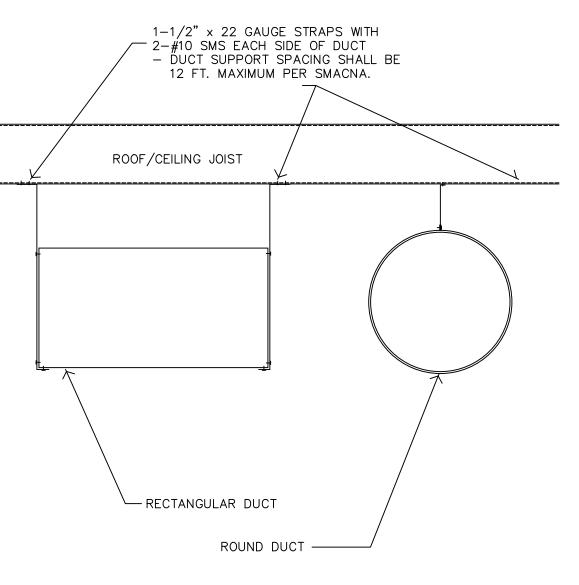

<u>DUCT SUPPORT</u> NO SCALE

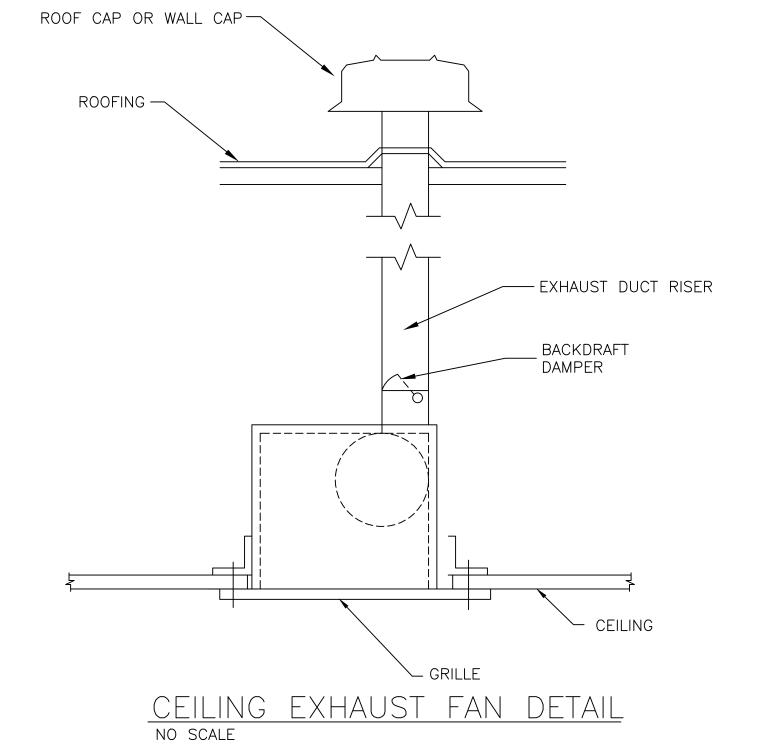

THIS WORK IS DESIGNED BY AND SHALL BE INSTALLED BY THE LISTED MECHANICAL CONTRACTOR PER CBC 107 & BUSINESS PROFESSIONS CODE SECTION 6737.3

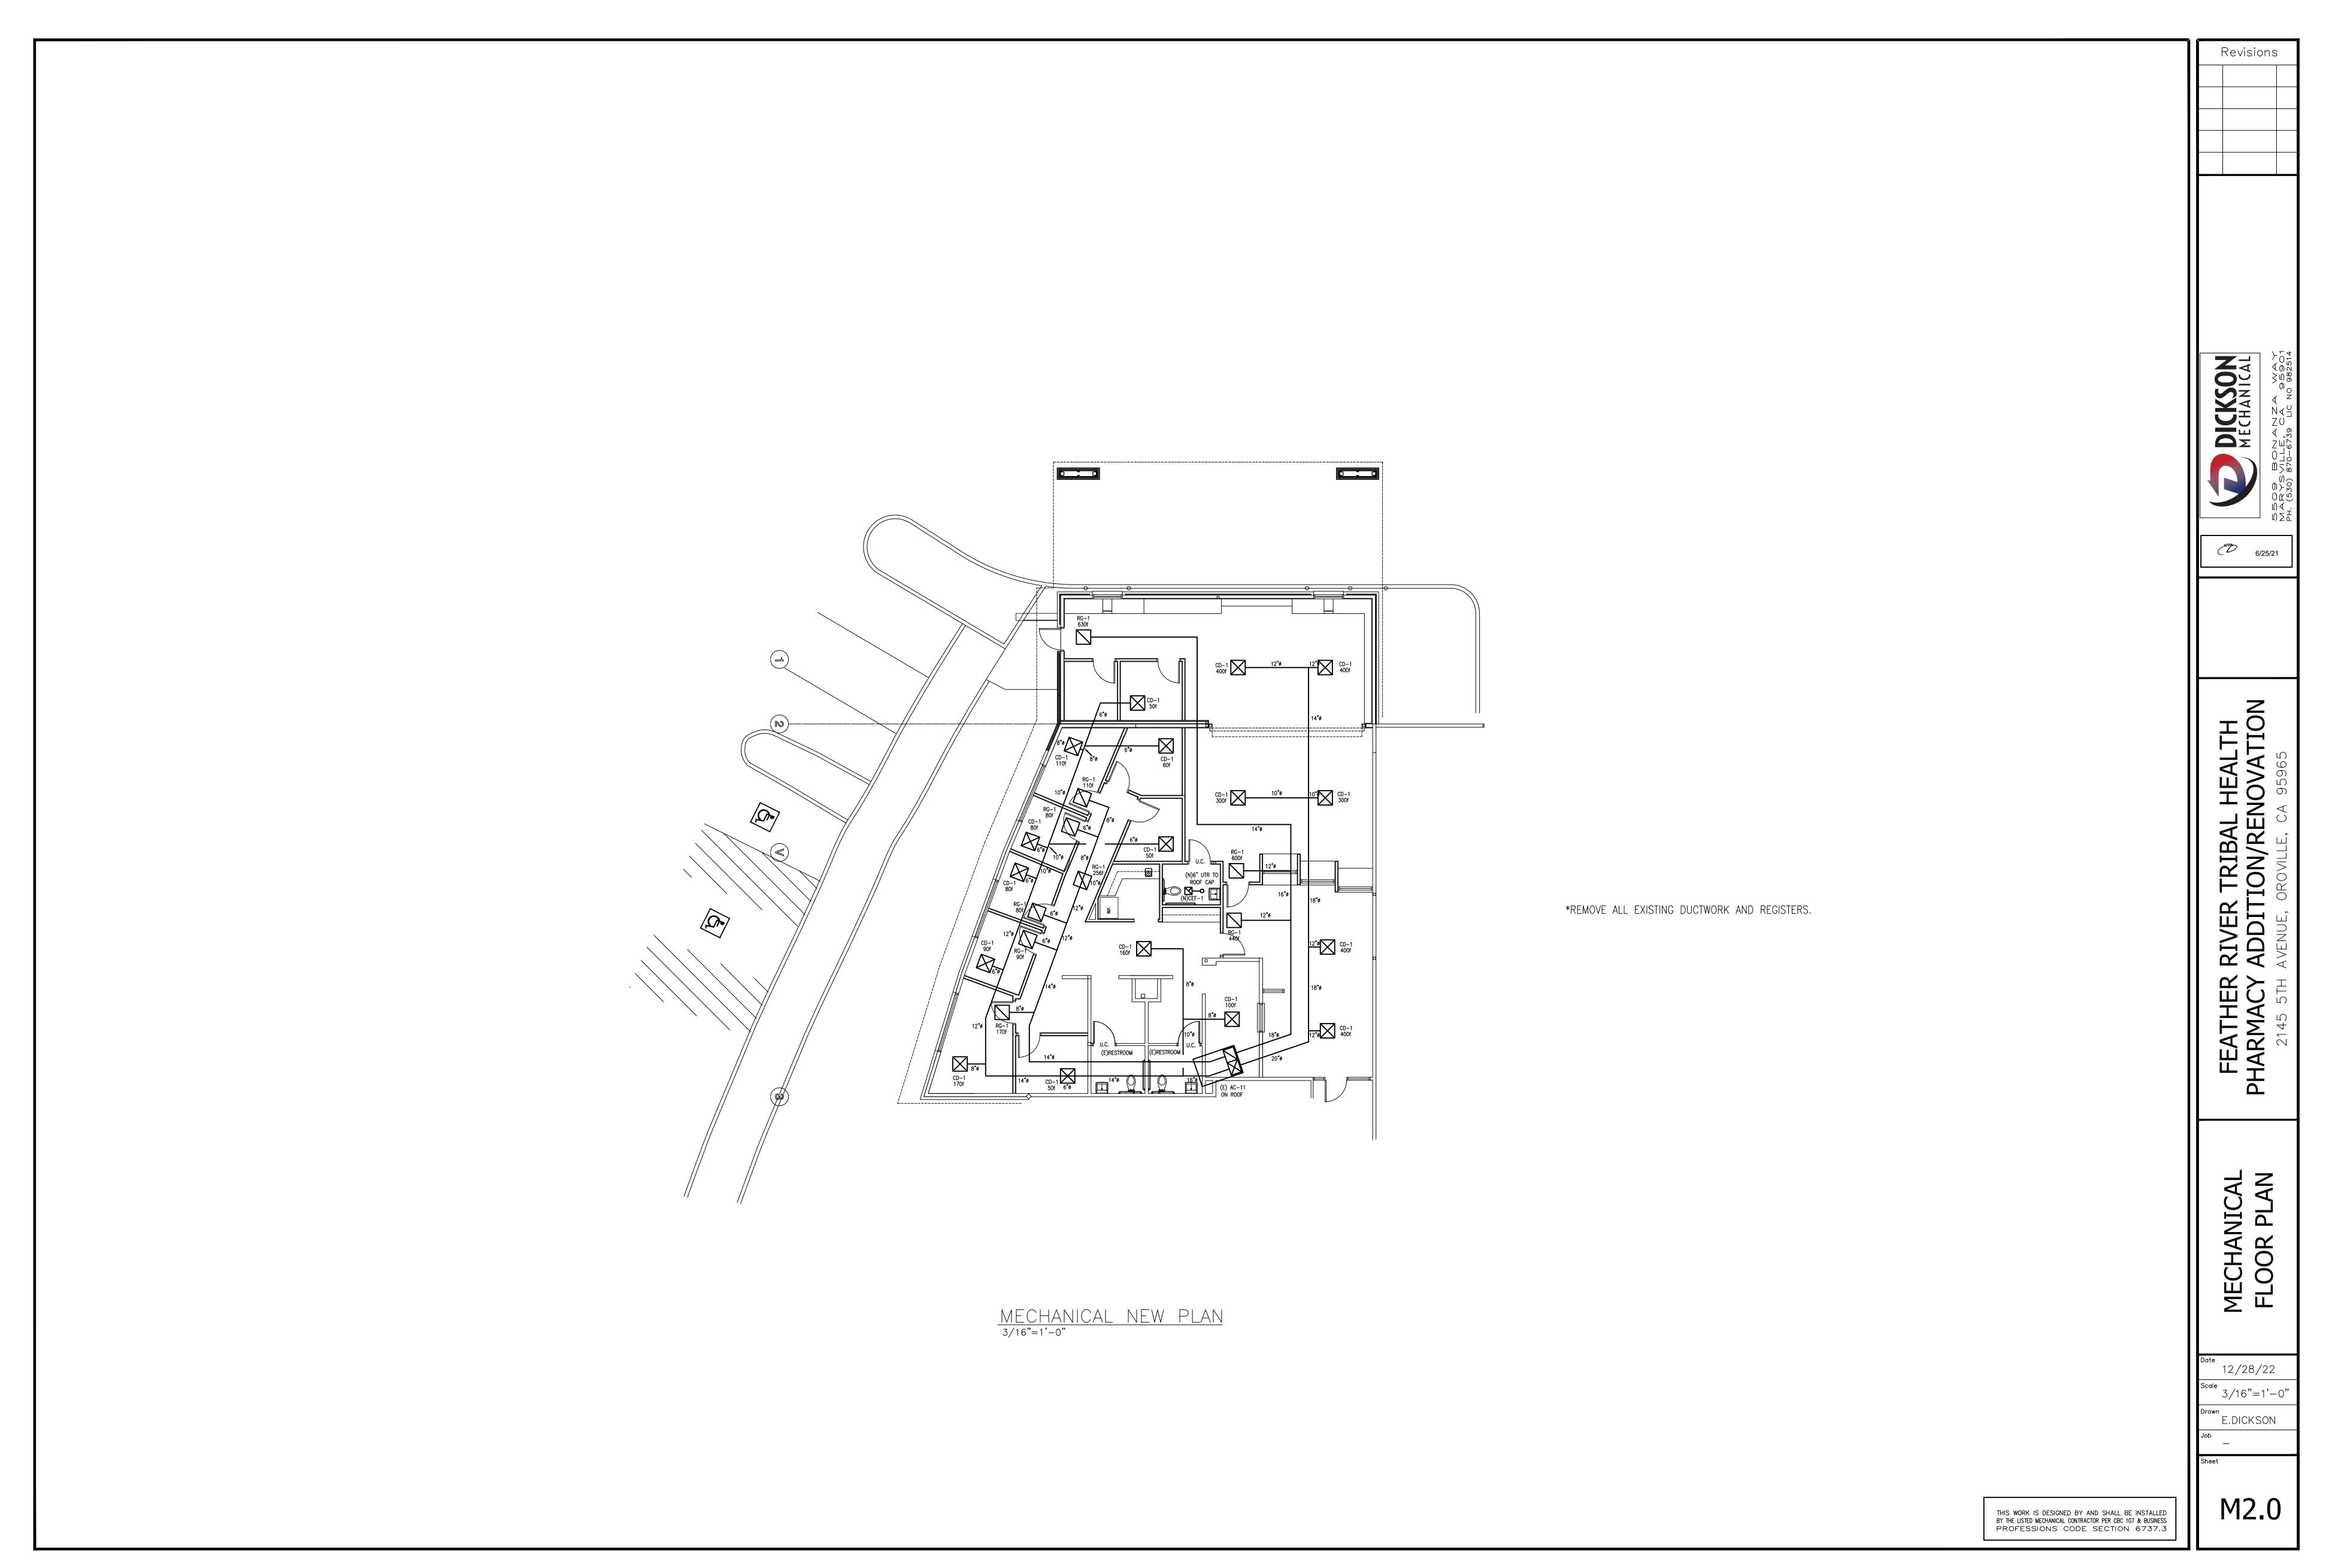

NRCC-MCH-E (Created 11/18)				CALIFORNIA F	NERGY COMMISSION
CERTIFICATE OF COMPLIANCE				O'LLI O'MAIA E	NRCC-MCH
Table Instructions: Include any mechanical system §140.4, or §141.0(b)2 for alterations.	ms that are within the scope of	f the permit application and are demo	nstrating compliand	e using the preso	criptive path outlined in
Project Name: Feather River Tribal Pharmacy		Report P	ige:		Page 1 o
Project Address: 2145 5th Avenue		Date Pre	ared:		2022-12-
A. GENERAL INFORMATION					
01 Project Location (city)	Oroville	04 Total Conditioned Flo	or Area		3,016
02 Climate Zone	11	05 Total Unconditioned	Floor Area		0
03 Occupancy Types Within Project:		06 # of Stories (Habitabl	Above Grade)		1
✓ Office Retail	Non-ref		otel/ Motel	Scho	ool
		(Write In):			
B. PROJECT SCOPE  Table Instructions: Include any mechanical system	ms that are within the scope of	f the permit application and are demo	nstrating complianc	e using the presc	criptive path outlined i
§140.4, or <u>§141.0(b)2</u> for alterations.		consists of (check all that apply)			· ·
01		02		03	
Air System(s)	Wet	t System Components		Ory System Comp	oonents
	☐ Water Economiz	zer	Air Economize	r	
✓ Heating Air System					
<ul><li>✓ Heating Air System</li><li>✓ Cooling Air System</li></ul>	Pumps		Electric Resista	ince Heat	
Cooling Air System  Mechanical Controls	Pumps  Hydronic System	n Piping	☐ Electric Resista☐ Fan Systems	ince Heat	
✓ Cooling Air System	Hydronic System Cooling Towers		Fan Systems  U Ductwork	nce Heat	
Cooling Air System  Mechanical Controls  Mechanical Controls	Hydronic System Cooling Towers Chillers		Fan Systems  Unctwork Ventilation		
✓ Cooling Air System  Mechanical Controls  ✓ Mechanical Controls  Scope Description	Hydronic System Cooling Towers Chillers Boilers		Fan Systems Ductwork Ventilation Zonal Systems,	/ Terminal Boxes	
✓ Cooling Air System  Mechanical Controls  ✓ Mechanical Controls  Scope Description	Hydronic System Cooling Towers Chillers Boilers		Fan Systems Ductwork Ventilation Zonal Systems,	/ Terminal Boxes	
Cooling Air System  Mechanical Controls  Mechanical Controls  Scope Description  Describe the scope of the mechanical systems in	Hydronic System Cooling Towers Chillers Boilers		Fan Systems Ductwork Ventilation Zonal Systems,	/ Terminal Boxes	
C. COMPLIANCE RESULTS	Hydronic System Cooling Towers Chillers Boilers cluded in the permit applicatio	on. Include whether the systems are	Fan Systems  Ductwork  Ventilation  Zonal Systems, new, or being altere	/ Terminal Boxes d.	
Cooling Air System  Mechanical Controls  Mechanical Controls	Hydronic System Cooling Towers Chillers Boilers cluded in the permit applicatio	on. Include whether the systems are	Fan Systems  Ductwork  Ventilation  Zonal Systems, new, or being altere	/ Terminal Boxes d.	09
Mechanical Controls  ✓ Mechanical Controls  Scope Description  Describe the scope of the mechanical systems in  C. COMPLIANCE RESULTS  Table Instructions: If any cell on this table says "I  O1	Hydronic System Cooling Towers Chillers Boilers Cluded in the permit application  DOES NOT COMPLY" or "COMPLY"  System Controls (C), (A) S120.2, S120.2,	on. Include whether the systems are PLIES with Exceptional Conditions" ref	Fan Systems  Ductwork  Ventilation  Zonal Systems, new, or being altere  r to Table D. for gui	/ Terminal Boxes d. dance. 08 Cooling	09
Mechanical Controls  Mechanical Controls  Scope Description  Describe the scope of the mechanical systems in  C. COMPLIANCE RESULTS  Table Instructions: If any cell on this table says "In the support of the support of the support of the mechanical systems in the support of the support of the mechanical systems in the support of the sup	Hydronic System Cooling Towers Chillers Boilers Cluded in the permit application  DOES NOT COMPLY" or "COMPLY"  System Controls Sillo.2, S	On. Include whether the systems are  ODE	Fan Systems    Ductwork     Ventilation     Zonal Systems, onew, or being altere     O7     Distribution     \$120.3, \$140.4(1)     AND	/ Terminal Boxes d.  dance.  08  Cooling Towers §110.2(e)2	09
Mechanical Controls  ✓ Mechanical Controls  Scope Description  Describe the scope of the mechanical systems in  C. COMPLIANCE RESULTS  Table Instructions: If any cell on this table says "I  O1  System Summary §110.1, §110.2, AND Pumps §140.4(k) AND Fans, Economi §140.4 §140.4	Hydronic System Cooling Towers Chillers Boilers Cluded in the permit application  DOES NOT COMPLY" or "COMPLY"  System Controls Sillo.2, S	PLIES with Exceptional Conditions" ref  05  06  Ventilation 8120.1  AND Controls AN	Fan Systems    Ductwork     Ventilation     Zonal Systems, new, or being altere     O7     Distribution     \$120.3, \$140.4(I)     (See Table L)	/ Terminal Boxes d.  dance.  08  Cooling Towers §110.2(e)2  (See Table M)	(

	(Created 11/1		CALIFORI	NIA ENERGY COMMI	SSION W
	TE OF COM			N	IRCC-MCH-
Project Na		ther River Tribal F	· · · · ·		Page 4 of
Project Add	dress: 214	5 5th Avenue	Date Prepared:		2022-12-2
Table Cont	inued				
			In a space directly under a roof that has a U-factor greater than the U-factor of the ceiling, or if the roof doe requirements of §140.3(a)1B or if the roof has fixed vents or openings to the outside/ unconditioned space		
			In an unconditioned crawlspace		
			In other unconditioned spaces		
14	No	The scope of th	ne project includes extending an existing duct system, which is constructed, insulated or sealed with asbestos.		
15	No	The scope of th	ne project includes an existing duct system that is documented to have been previously sealed as confirmed th	rough field verifi	cation and
13	INO	diagnostic testi	ing in accordance with procedures in the <u>Reference Nonresidential Appendix NA2</u> .		
This Section		F REQUIRED CE	ERTIFICATES OF INSTALLATION on made based on information provided in previous tables of this document. If any selection needs to be change	ed, please explair	why in
This Section  N. DECLAI  Table Instru  Table E. Aa	n Does Not  RATION O  uctions: Ser Iditional Re	F REQUIRED CE lections have bee marks. These doo		ed, please explair	why in
This Section  N. DECLAI  Table Instruction  Table E. Aa  www.energ	RATION Ouctions: Sei	F REQUIRED CE lections have bee marks. These doo	on made based on information provided in previous tables of this document. If any selection needs to be change cuments must be provided to the building inspector during construction and can be found online at <a href="http://cec-400-2015-033/appendices/forms/NRCI">http://cec-400-2015-033/appendices/forms/NRCI</a>		why in
This Section  N. DECLAI  Table Instru  Table E. Aa	n Does Not  RATION O  uctions: Ser Iditional Re	F REQUIRED CE lections have bee marks. These doo	n made based on information provided in previous tables of this document. If any selection needs to be change cuments must be provided to the building inspector during construction and can be found online at <a href="http://">http://</a>		
This Section  N. DECLAI  Table Instruction  Table E. Aa  www.energ	RATION Ouctions: Sei	F REQUIRED CE lections have bee marks. These doc 2015publications/	on made based on information provided in previous tables of this document. If any selection needs to be change cuments must be provided to the building inspector during construction and can be found online at <a href="http://cec-400-2015-033/appendices/forms/NRCI">http://cec-400-2015-033/appendices/forms/NRCI</a>	Field In	spector

NRCC-MCH-E (Created 11/18)  CERTIFICATE OF COMPLIANCE  Project Name: Feather River Tril  Project Address: 2145 5th Avenue  DOCUMENTATION AUTHOR'S I  Documentation Author Name:  Company:  Address:  City/State/Zip:  RESPONSIBLE PERSON'S DECLARA I certify the following under penal	·	Report Page: Date Prepare  Documentation Author Signature Date:	ed:	NRCC-MCH- Page 7 of 2022-12-2 Digitally signed by Eric Dickson Date: 2022.12.28 14.46.07 -08'00'
Project Name: Feather River Tril Project Address: 2145 5th Avenue  DOCUMENTATION AUTHOR'S I Documentation Author Name:  Company: Address: City/State/Zip:  RESPONSIBLE PERSON'S DECLARA	DECLARATION STATEMENT  Eric Dickson  Dickson Mechanical	Date Prepare  Documentation Author Signature Date:	ed: ure:Eric Dlckson	Page 7 of 2022-12-2
Project Address: 2145 5th Avenue  DOCUMENTATION AUTHOR'S I  Documentation Author Name:  Company:  Address:  City/State/Zip:  RESPONSIBLE PERSON'S DECLARA	DECLARATION STATEMENT  Eric Dickson  Dickson Mechanical	Date Prepare  Documentation Author Signature Date:	ed: ure:Eric Dlckson	2022-12-2
Documentation Author Name:  Company:  Address:  City/State/Zip:  RESPONSIBLE PERSON'S DECLARA	Eric Dickson Dickson Mechanical	Signature Date:		Digitally signed by Eric Dickson
Documentation Author Name:  Company:  Address:  City/State/Zip:  RESPONSIBLE PERSON'S DECLARA	Eric Dickson Dickson Mechanical	Signature Date:		Digitally signed by Eric Dickson
Address: City/State/Zip: RESPONSIBLE PERSON'S DECLARA		Signature Date:		Date: 2022.12.20 14.40.07 -00 00
City/State/Zip: RESPONSIBLE PERSON'S DECLARA	5509 Bonanza Way		12/20/2	<u></u>
RESPONSIBLE PERSON'S DECLARA	<u> </u>	CEA/ HERS Certification Identif	fication (if applicable):	982514
RESPONSIBLE PERSON'S DECLARA	Marysville, CA 95901	Phone:	5308706739	
Certificate of Compliance confo 4. The building design features or compliance documents, worksh 5. I will ensure that a completed s to the enforcement agency for	mance specifications, materials, components, a irm to the requirements of Title 24, Part 1 and I system design features identified on this Certifications, plans and specifications sub igned copy of this Certificate of Compliance should applicable inspections. I understand that a couldes to the building owner at occupancy.	Part 6 of the California Code of Regu ficate of Compliance are consistent v omitted to the enforcement agency f all be made available with the buildi	lations. vith the information pro or approval with this bu ng permit(s) issued for t	ovided on other applicable ilding permit application. the building, and made availabl
Responsible Designer Name:	Dickson Mechanical	Responsible Designer Signatur	e: Eric DIckson	Digitally signed by Eric Dickson Date: 2022.12.28 14:46:38 -08'00'
Company :	Dickson Mechanical	Date Signed:	12/28/22	
Address:	5509 Bonanza Way	License:	982514	
City/State/Zip:	Loma Rica, CA 95901	Phone:	530-870-6739	

	(Created 11/18)						CALIF	ORNIA ENER	GY COMMISS	
Project Nai	TE OF COMPLIANCE me: Feather River Tribal F	Pharmacy		Report	Page					CC-MCH- Page 2 of
	dress: 2145 5th Avenue	Патпасу			repared:					2022-12-2
	FIONAL CONDITIONS									?
nis table i	s auto-Jillea with unealtable	comments because of selections made	or data enterea in table	s tnrougnou	it tne Jorm					
Selections	made in Table O have been	changed by the permit applicant. See T	able E. Additional Rema	irks for pern	nit applicar	nt's explan	ation.			
. ADDITI	ONAL REMARKS									?
his table i	includes remarks made by th	e permit applicant to the Authority Hav	ing Jurisdiction.							
. HVAC S	SYSTEM SUMMARY (DRY	& WET SYSTEMS)								2
	· · · · · · · · · · · · · · · · · · ·	ving equipment schedules to show comp	oliance with mandatory	reauiremen	ts found in	§110.1 and	d §110.2(a)	and preso	riptive real	uirements
		0.4(k) or <u>§141.0(b)2</u> for alterations.	,		,	<u></u>			,	
ry Systen	n Equipment Sizing (include	s air conditioners, condensers, heat pu	ımps, VRF, furnaces and	d unit heate	rs)					
01	02	03	04	05	06	07	08	09	10	11
				Equip	ment Sizin	ig per Mecl	hanical Sch	edule (Btu	/h) <u>§140.4</u>	(a&b)
			Smallest Size	Hea	ating Outpu	ut <sup>2,3</sup>		Output <sup>2,3</sup>	Load Calc	ulations <sup>3,</sup>
Name or   tem Tag	Equipment Category per Tables 110.2	Equipment Type per Tables 110.2 & Title 20	e per Available <sup>1</sup>	Per		Supp.	Sensible	<b>.</b>	Total	Total
terri rag	<u> 1abies 110.2</u>	Tables 110.2 & Title 20	§140.4(a)	Design	Rated (Btu/h)	Heating Output	Per Design	Rated (Btu/h)	Heating	Sensible Cooling
				(Btu/h)	(Btu/II)	(Btu/h)	(Btu/h)	(Btu/II)	Load	Load
						(	(			
AC-11		1		50,000	50,000	20,000	40,000	35,000	60,000	40,000
FOOTNOT	TES. Equipment shall be the	smallest size, within the available option	os of the desired equipm	ont line no	coccami to i	moot the d	osian hoati	na and so	olina loads	of tha
	er §140.4(a).	indilest size, within the available option	is of the desired equipm	ieni iine, nei	lessury to i	meet the u	esign neuti	ng unu coc	ning lodus	oj trie
		output capacity on the equipment sched	lule. Sensible cooling ou	tput comes	from speci	fication sh	eet tables.			
		oling output and load blank. If equipme		heating ou	tput and lo	ad blank.				
Authority	Having Jurisdiction may ask	for load calculations used for complian	nce per <u>§140.4(b)</u> .							
6. PUMPS	X2									?
his Section	n Does Not Apply									
	·	<del></del>								

IRCC-MCH-E (	ical Syst	3) CALIFORNIA EI	NERGY COMMIS	
	E OF COM			IRCC-MCH-E
Project Nam		her River Tribal Pharmacy Report Page:		Page 5 of 7
roject Add	iress: 2145	5th Avenue Date Prepared:		2022-12-28
D. DECLAR	RATION OI	REQUIRED CERTIFICATES OF ACCEPTANCE AND VERIFICATION		?
able E. Add <u>vww.energ</u>	ditional Rei y.ca.gov/2	ections have been made based on information provided in previous tables of this document. If any selection needs to be changed, paraks. These documents must be provided to the building inspector during construction and can be found online at <a href="http://">http://</a> 015publications/CEC-400-2015-033/appendices/forms/NRCA/ (for Certificates of Acceptance) and <a href="http://www.energy.ca.gov/2015">http://www.energy.ca.gov/2015</a> pendices/forms/NRCV/ (for Certificates of Verification).		
YES	NO	Form/Title	Field In	spector
163	NO	Formy fide	Pass	Fail
0	•	NRCA-MCH-02-A Outdoor Air must be submitted for all newly installed HVAC units.  Note: MCH02-A can be performed in conjunction with MCH-07-A Supply Fan VFD Acceptance (if applicable) since testing activities overlap.		
0	•	NRCA-MCH-03-A Constant Volume Single Zone HVAC NOTE: This form does not automatically move to "Yes". If constant volume, single zone unitary AC/HP Systems are included in the scope, permit applicant should move this form to "Yes".		
0	•	NRCA-MCH-04-A Air Distribution Duct Leakage		
0	•	NRCV-MCH-04-H Duct Leakage Test  NOTE: Must be completed by a HERS Rater		
0	•	NRCA-MCH-05-A Air Economizer Controls		
0	•	NRCA-MCH-06-A Demand Control Ventilation Systems Acceptance must be submitted for all systems required to employ demand controlled ventilation (refer to §120.1(c)3) can vary outside ventilation flow rates based on maintaining interior carbon dioxide (CO2) concentration setpoints.		
0	•	NRCA-MCH-07-A Supply Fan Variable Flow Controls		
0	•	NRCA-MCH-08-A Valve Leakage Test		
0	•	NRCA-MCH-09-A Supply Water Temperature Reset Controls		
0	•	NRCA-MCH-10-A Hydronic System Variable Flow Controls		
0	•	NRCA-MCH-11-A Automatic Demand Shed Controls		
0	•	NRCA-MCH-12-A FDD for Packaged Direct Expansion Units  NOTE: This form does not automatically move to "Yes". If package DX Systems are included in the scope, permit applicant should move this form to "Yes".		
•	0	NRCA-MCH-13-A Automatic FDD for Air Handling Units and Zone Terminal Units Acceptance		
0	•	NRCA-MCH-14-A Distributed Energy Storage DX AC Systems Acceptance  NOTE: This form does not automatically move to "Yes". If Distributed Energy Storage DX AC Systems are included in the scope, permit applicant should move this form to "Yes".		
0	•	NRCA-MCH-15-A Thermal Energy Storage (TES) System Acceptance		
Ō	•	NRCA-MCH-16-A Supply Air Temperature Reset Controls		
0	•	NRCA-MCH-17-A Condenser Water Temperature Reset Controls		
0	•	NRCA-MCH-18 Energy Management Control Systems		

NRCC-MCH-F (Cre	reated 11	stems						CALIFORNIA ENERGY O	OMMISSION
CERTIFICATE (		•						O'LLI O'NI II LITEROT C	NRCC-MCF
Project Name	e: Fe	ather River Trib	al Pharmacy			Report P	age:		Page 3 o
Project Addre	ess: 21	45 5th Avenue				Date Pre	pared:		2022-12-
H. FAN SYST	TEMS 8	AIR ECONO	MIZERS						<b>[</b>
This Section D	Does No	ot Apply							
I. SYSTEM CO		100.70.00.00							
			llowing Table to d ered space condit	demonstrate compliance v	vith mandatory con	trols in <u>§110.2</u> and	d <u>§120.2</u> and prescriptive	controls in <u>§140.4</u>	<u>f)</u> and <u>(n)</u> or
01	3 111 314.	02	03	04	05	06	07	08	09
		02	Conditioned				07		
6			Floor Area	Thermostats	Shut-Off	Isolation Zone	Demand Response	Supply Air	Window
System Nan	me S	ystem Zoning	Being Served	§110.2(b) & (c) or §141.0(b)2E	Controls §120.2(e)	Controls	§120.2(h)	Temp. Reset §140.4(f)	Interlocks pe §140.4(n)
			(ft²)	9141.0(b)2E	<u>9120.2(e)</u>	§120.2(g)		9140.4(1)	9140.4(11)
						A			
AC-11	s	ingle zone	≤ 25,000 ft²	Setback Thermostat	Auto ch	Auto ch	EMCS	Included	Provided
* NOTES: Con	ntrols w	ith a * require o	a note in the spac	Setback Thermostat re below explaining how co compliant with §140.4(d)	Timeswitch ch	Timeswitch ch	EMCS	Included	Provided
* NOTES: Con EX: System 1:	ntrols w : SA Ten	ith a * require o	a note in the spac	re below explaining how co	Timeswitch ch	Timeswitch ch	EMCS	Included	Provided
* NOTES: Con EX: System 1: J. VENTILAT	ntrols w : SA Ten	ith a * require on Reset: Exem	a note in the spac	re below explaining how co	Timeswitch ch	Timeswitch ch	EMCS	Included	Provided
* NOTES: Con EX: System 1:	ntrols w : SA Ten	ith a * require on Reset: Exem	a note in the spac	re below explaining how co	Timeswitch ch	Timeswitch ch	EMCS	Included	Provided
* NOTES: Con EX: System 1: J. VENTILAT	ntrols w : SA Ten	ot Apply	a note in the spac	re below explaining how co	Timeswitch ch	Timeswitch ch	EMCS	Included	Provided
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NRCC-MCH-E (Created 11/18)		CALI	FORNIA ENERGY COMMISSION
CERTIFICATE OF COMPLIANCE			NRCC-MCH
Project Name: Feather River Tribal Pharmacy		Report Page:	Page 6 o
Project Address: 2145 5th Avenue		Date Prepared:	2022-12-
P. MANDATORY MEASURES DOCUMENTATION LOCATIO	N		
Table Instructions: Indicate where mandatory measures are doc the plan sheet or construction document location as "N/A", any			sures that do not apply, mark
01		02	
01		Plan sheet or construction docur	nent location
Compliance with Mandatory Measures documented through MCH Mandatory Measures Note Block:	Yes	M1.0	

THIS WORK IS DESIGNED BY AND SHALL BE INSTALLED BY THE LISTED MECHANICAL CONTRACTOR PER CBC 107 & BUSINESS PROFESSIONS CODE SECTION 6737.3

FEATHER RIVER TRIBAL HEALTH
PHARMACY ADDITION/RENOVATION
2145 5TH AVENUE, OROVILLE, CA 95965 MECHANICAL TITLE 24 Date 12/28/22 Scale 3/16"=1'-0" Drawn E.DICKSON

GYMBO!	MED /MODEL		WASTE	COLD WATER	HOT WATER	PEMARKS
SYMBOL	MFR/MODEL	YENT	OUTLET	OUTLET	OUTLET	- REMARKS
$\left\langle \begin{array}{c} L \\ I \end{array} \right\rangle$	LAVATORY - KOHLER MODEL K-2005 FAUCET - CHICA60 802-VE2805-665ABCP	1 1/2"	2"	1/2"	1/2"	THIS FIXTURE SHALL MEET ALL ADA REQUIREMENTS FOR BOWL DEPTH AND CLEARANCES, AND SHALL BE INSTALLED AT THE CORRECT RIM HEIGHT, KNEE CLEARANCES PER ADA REQUIREMENTS
( <del>5</del> )	SINK - ELKAY MODEL HD32087LFR FAUCET - LK24T7CR (INCLUDED W/ SINK)	1 1/2"	2"	1/2"	1/2"	ACCESSIBLE APPROVED WITH APPROVED MIXING VALVE
(WC)	COMMODE - GERBER MODEL HE-20-318 PRESSURE ASSIST TANK ADA COMPLIANT	3"	3"	1/2"	~	THIS FIXTURE SHALL BE ELONGATED BOWL, OPEN FRONT SEAT AND 1.28 gal.PER FLUSH - PRESSURE ASSIST FLUSH UNIT.
MXV	WATTS - EXTERNAL THERMOSTATIC MIXING VALVE MODEL - LEMMV	~	~	1/2"	1/2"	

INSTALL ANY ACCESSORIES AS REQUIRED FOR A COMPLETE AND PROPERLY OPERATIONAL SYSTEM.

ALL FAUCETS SHALL BE PROVIDED AND INSTALLED WITH THERMOSTATIC MIXING DEVICES THAT CONFORM WITH CODE REQUIREMENTS. LIMITATION OF HOT WATER TEMPERATURE FOR PUBLIC LAVATORIES: HOT WATER DELIVERED FROM PUBLIC-USE LAVATORIES SHALL BE LIMITED TO A MAXIMUM TEMPERATURE OF 120 DEGREES F. BY A DEVICE THAT IS IN ACCORDANCE WITH ASSE 10709 OR CSA BI25.3. THE WATER HEATER THERMOSTAT SHALL NOT BE CONSIDERED A CONTROL FOR MEETING THIS PROVISION. (PER CBC)

### MASTE & VENT PIPING LEGEND

——SS———SANITARY SEMER LINE - SCHEDULE 40 PVC WASTE VENT LINE - SCHEDULE 40 PVC --- -- EXISTING SANITARY SEWER LINE ———————— EXISTING WASTE VENT LINE ovtr VENT THRU ROOF P.O.C. POINT OF CONNECTION MATER (OVERHEAD) 

---- EXISTING COLD WATER ---- - EXISTING HOT WATER

ROOF DRAIN

**—** —

ROOF WASTE LEADER

#### GENERAL NOTES

- ALL PLUMBING INSTALLATIONS SHALL CONFORM WITH THE 2019 CALIFORNIA BUILDING CODE AND THE 2019 CALIFORNIA PLUMBING CODE AND OTHER CURRENT, GOVERNING CODES.
- 2. THE CONTRACTOR WILL FIELD LOCATE EXISTING PIPING MAINS AND POINTS OF CONNECTION BEFORE STARTING THE WORK.
- 3. ALL PLUMBING DRAWINGS ARE SCHEMATIC. THE APPROXIMATE SIZE AND LOCATION OF EQUIPMENT IS SHOWN TO SCALE WHERE POSSIBLE.
- 4. WHERE APPLICABLE PROVIDE AND INSTALL APPROVED FIRE CAULK/SEALS AROUND ALL PIPES AND ETC. PENETRATING FIRE RATED WALLS AND PARTITIONS.
- 5. FLASH AND COUNTERFLASH ALL ITEMS PASSING THROUGH THE ROOF. PROVIDE AND INSTALL ROOF JACKS, SAFES, ETC AS REQUIRED.
- 7. ALL PIPING AND ETC SHALL BE SUPPORTED AND BRACED IN ACCORDANCE WITH THE CALIFORNIA BUILDING CODE REQUIREMENTS.
- 8 ALL WASTE AND VENT PIPING SHALL BE SCHEDULE 40 PVC OR OTHER CODE APPROVED PIPING.
- 9 . RESERVED
- 10 ALL ABOVE GROUND WATER PIPING SHALL BE TYPE M COPPER.
- 11 PLUMBING VENTS SHALL TERMINATE NOT LESS THAN 10 FEET FROM ANY OPENABLE WINDOW, DOOR, OPENING, AIR INTAKE, OR VENT SHAFT.
- 12 PIPING SHALL BE SECURED AT 72" O.C. MAXIMUM SPACING
- 13 CLEAN OUTS SHALL BE THE FULL SIZE OF THE PIPE BUT NO LARGER THAN 4" DIAMETER.
- 14 ANGLE STOPS SHALL BE PLUMBING CODE APPROVED.
- 15 ALL TRAPS SHALL BE SCHEDULE 40 PVC TRAPS COMPLETE WITH ALL ACCESSORIES INCLUDING TRAP TO WALL CONNECTION AND ESCUTCHEON PLATE.
- 16 MOUNTING HEIGHT OF FIXTURES AND ACCESSORIES SHALL BE IN ACCORDANCE WITH ALL ACCESSIBILITY REQUIREMENTS.
- 17 WATER HAMMER ARRESTERS SHALL BE INSTALLED AT FIXTURES.

SHEET INDEX

P1-0 PLUMBING SCHEDULE & NOTES

P1-1 WASTE & VENT PIPING PLAN


P2-1 WATER PIPING PLAN

P3-I ROOF DRAIN PLAN


REVISIONS


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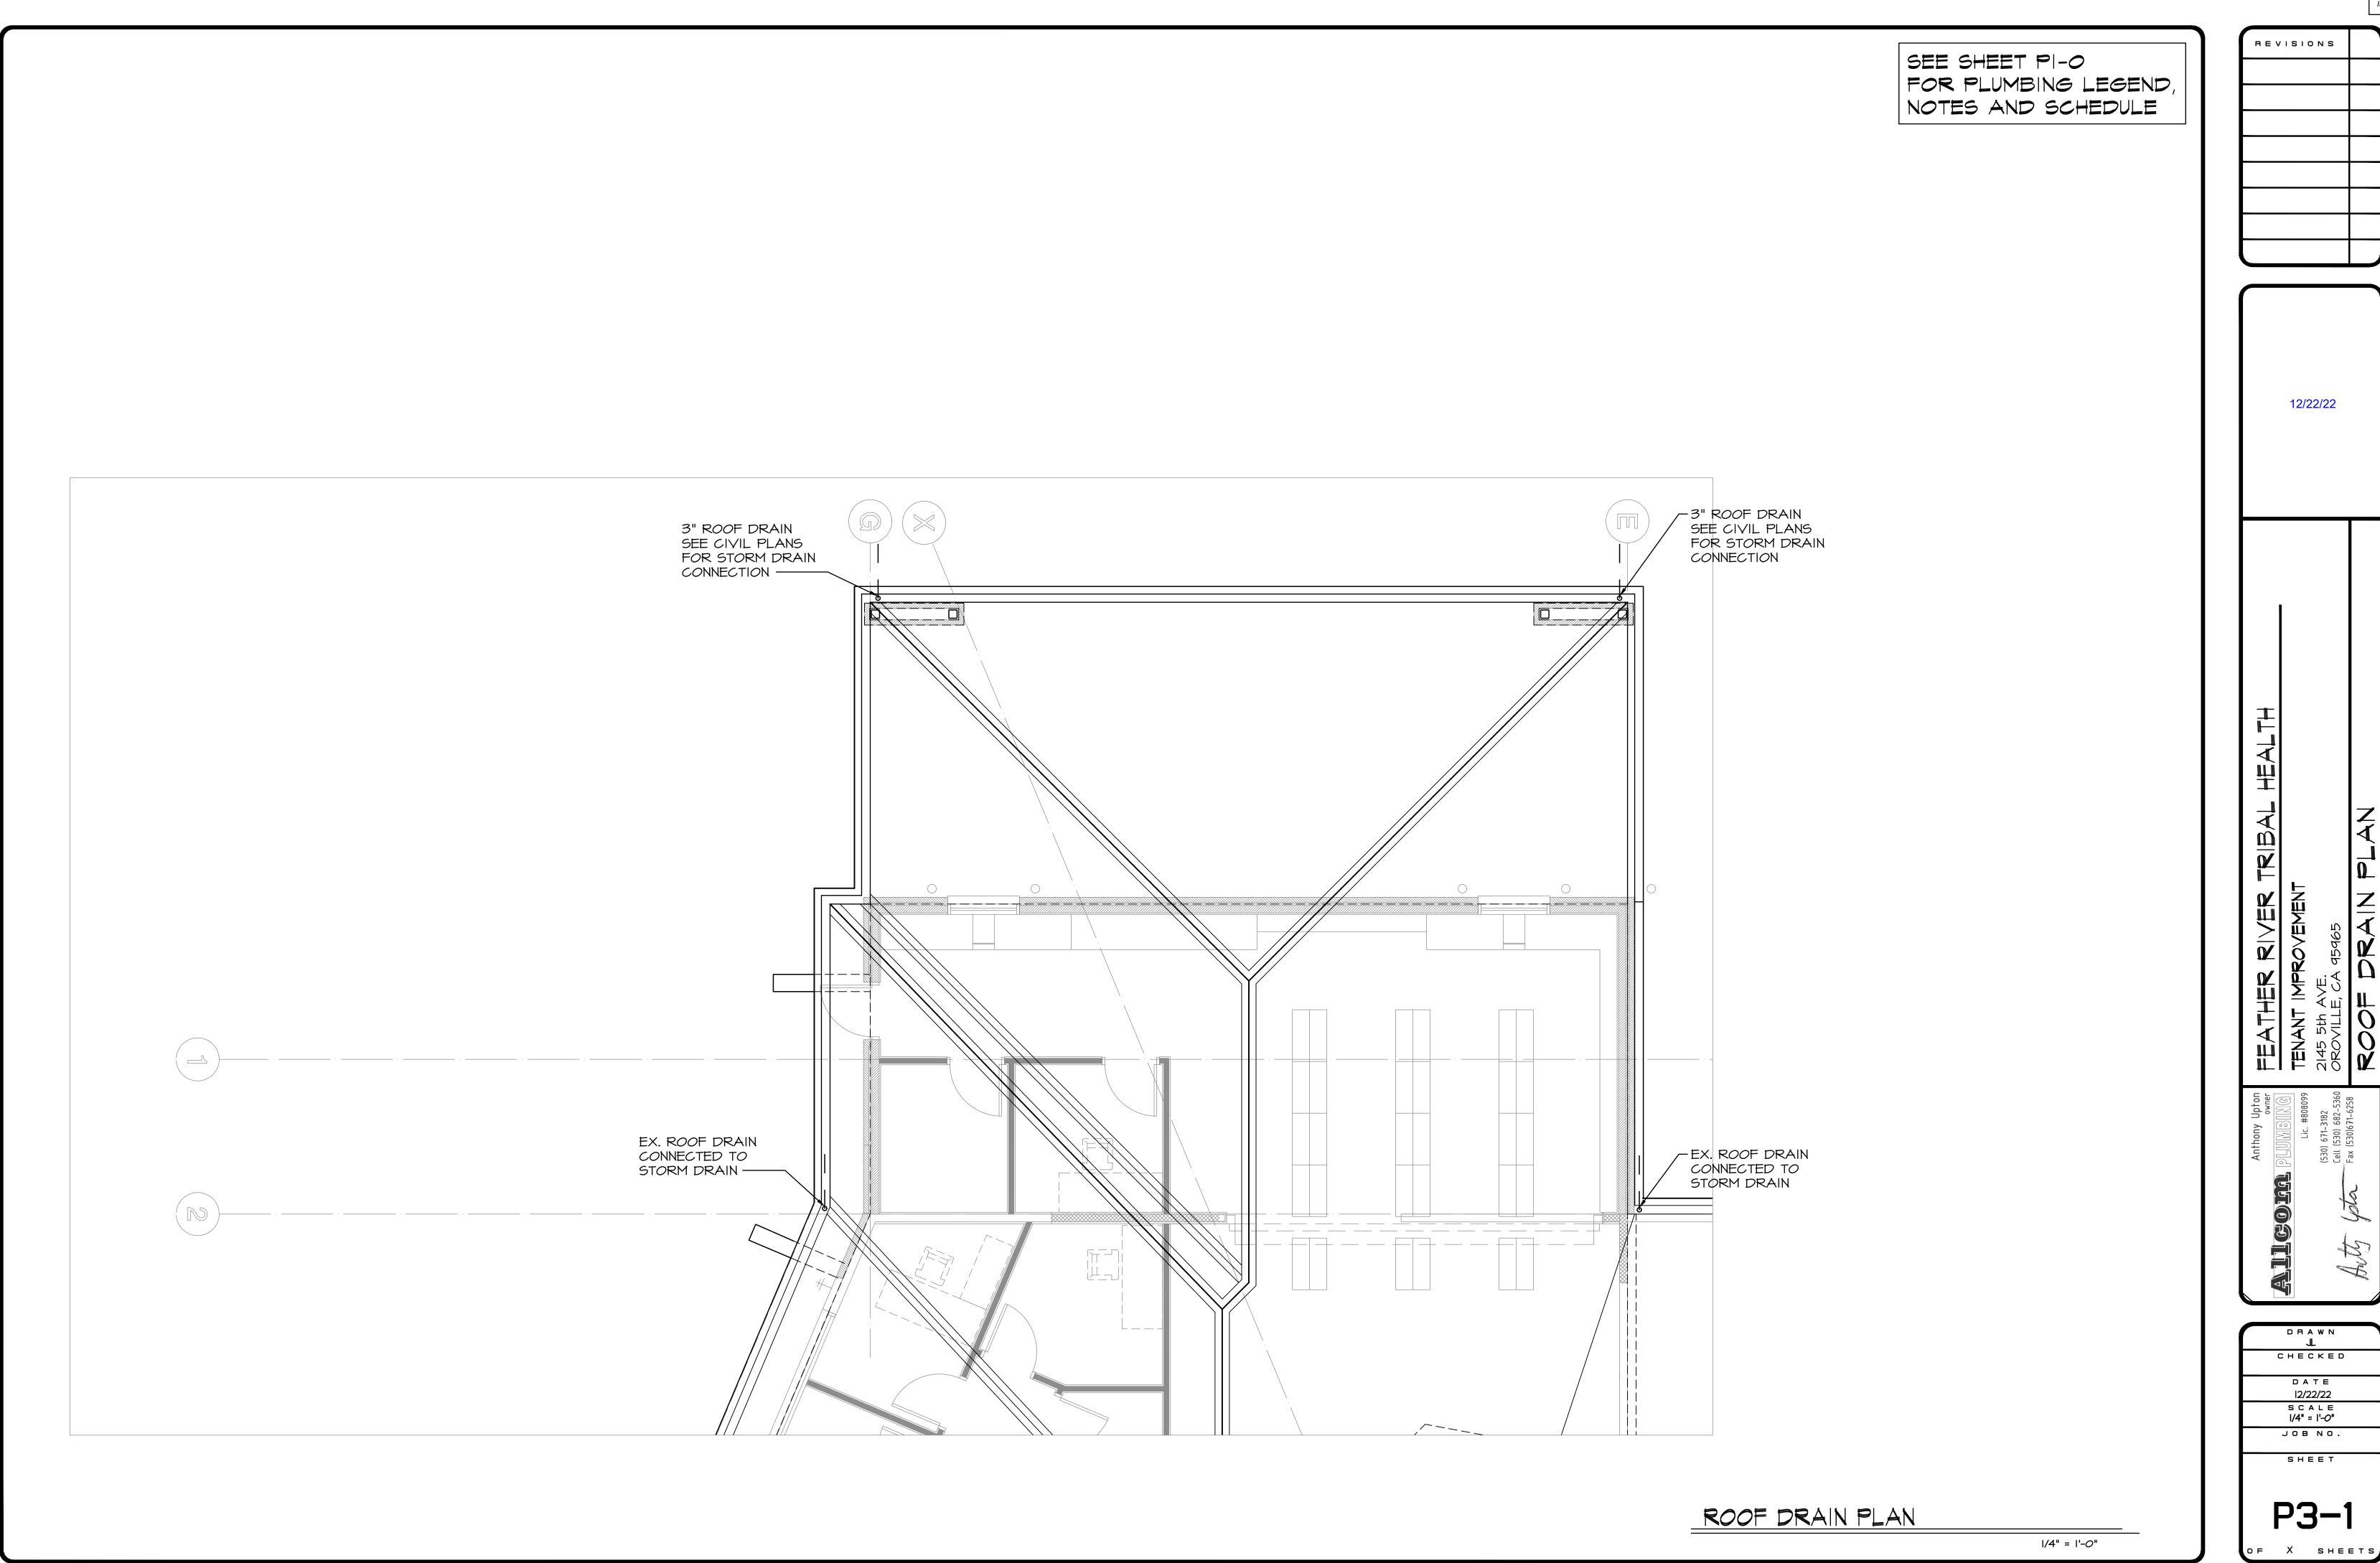
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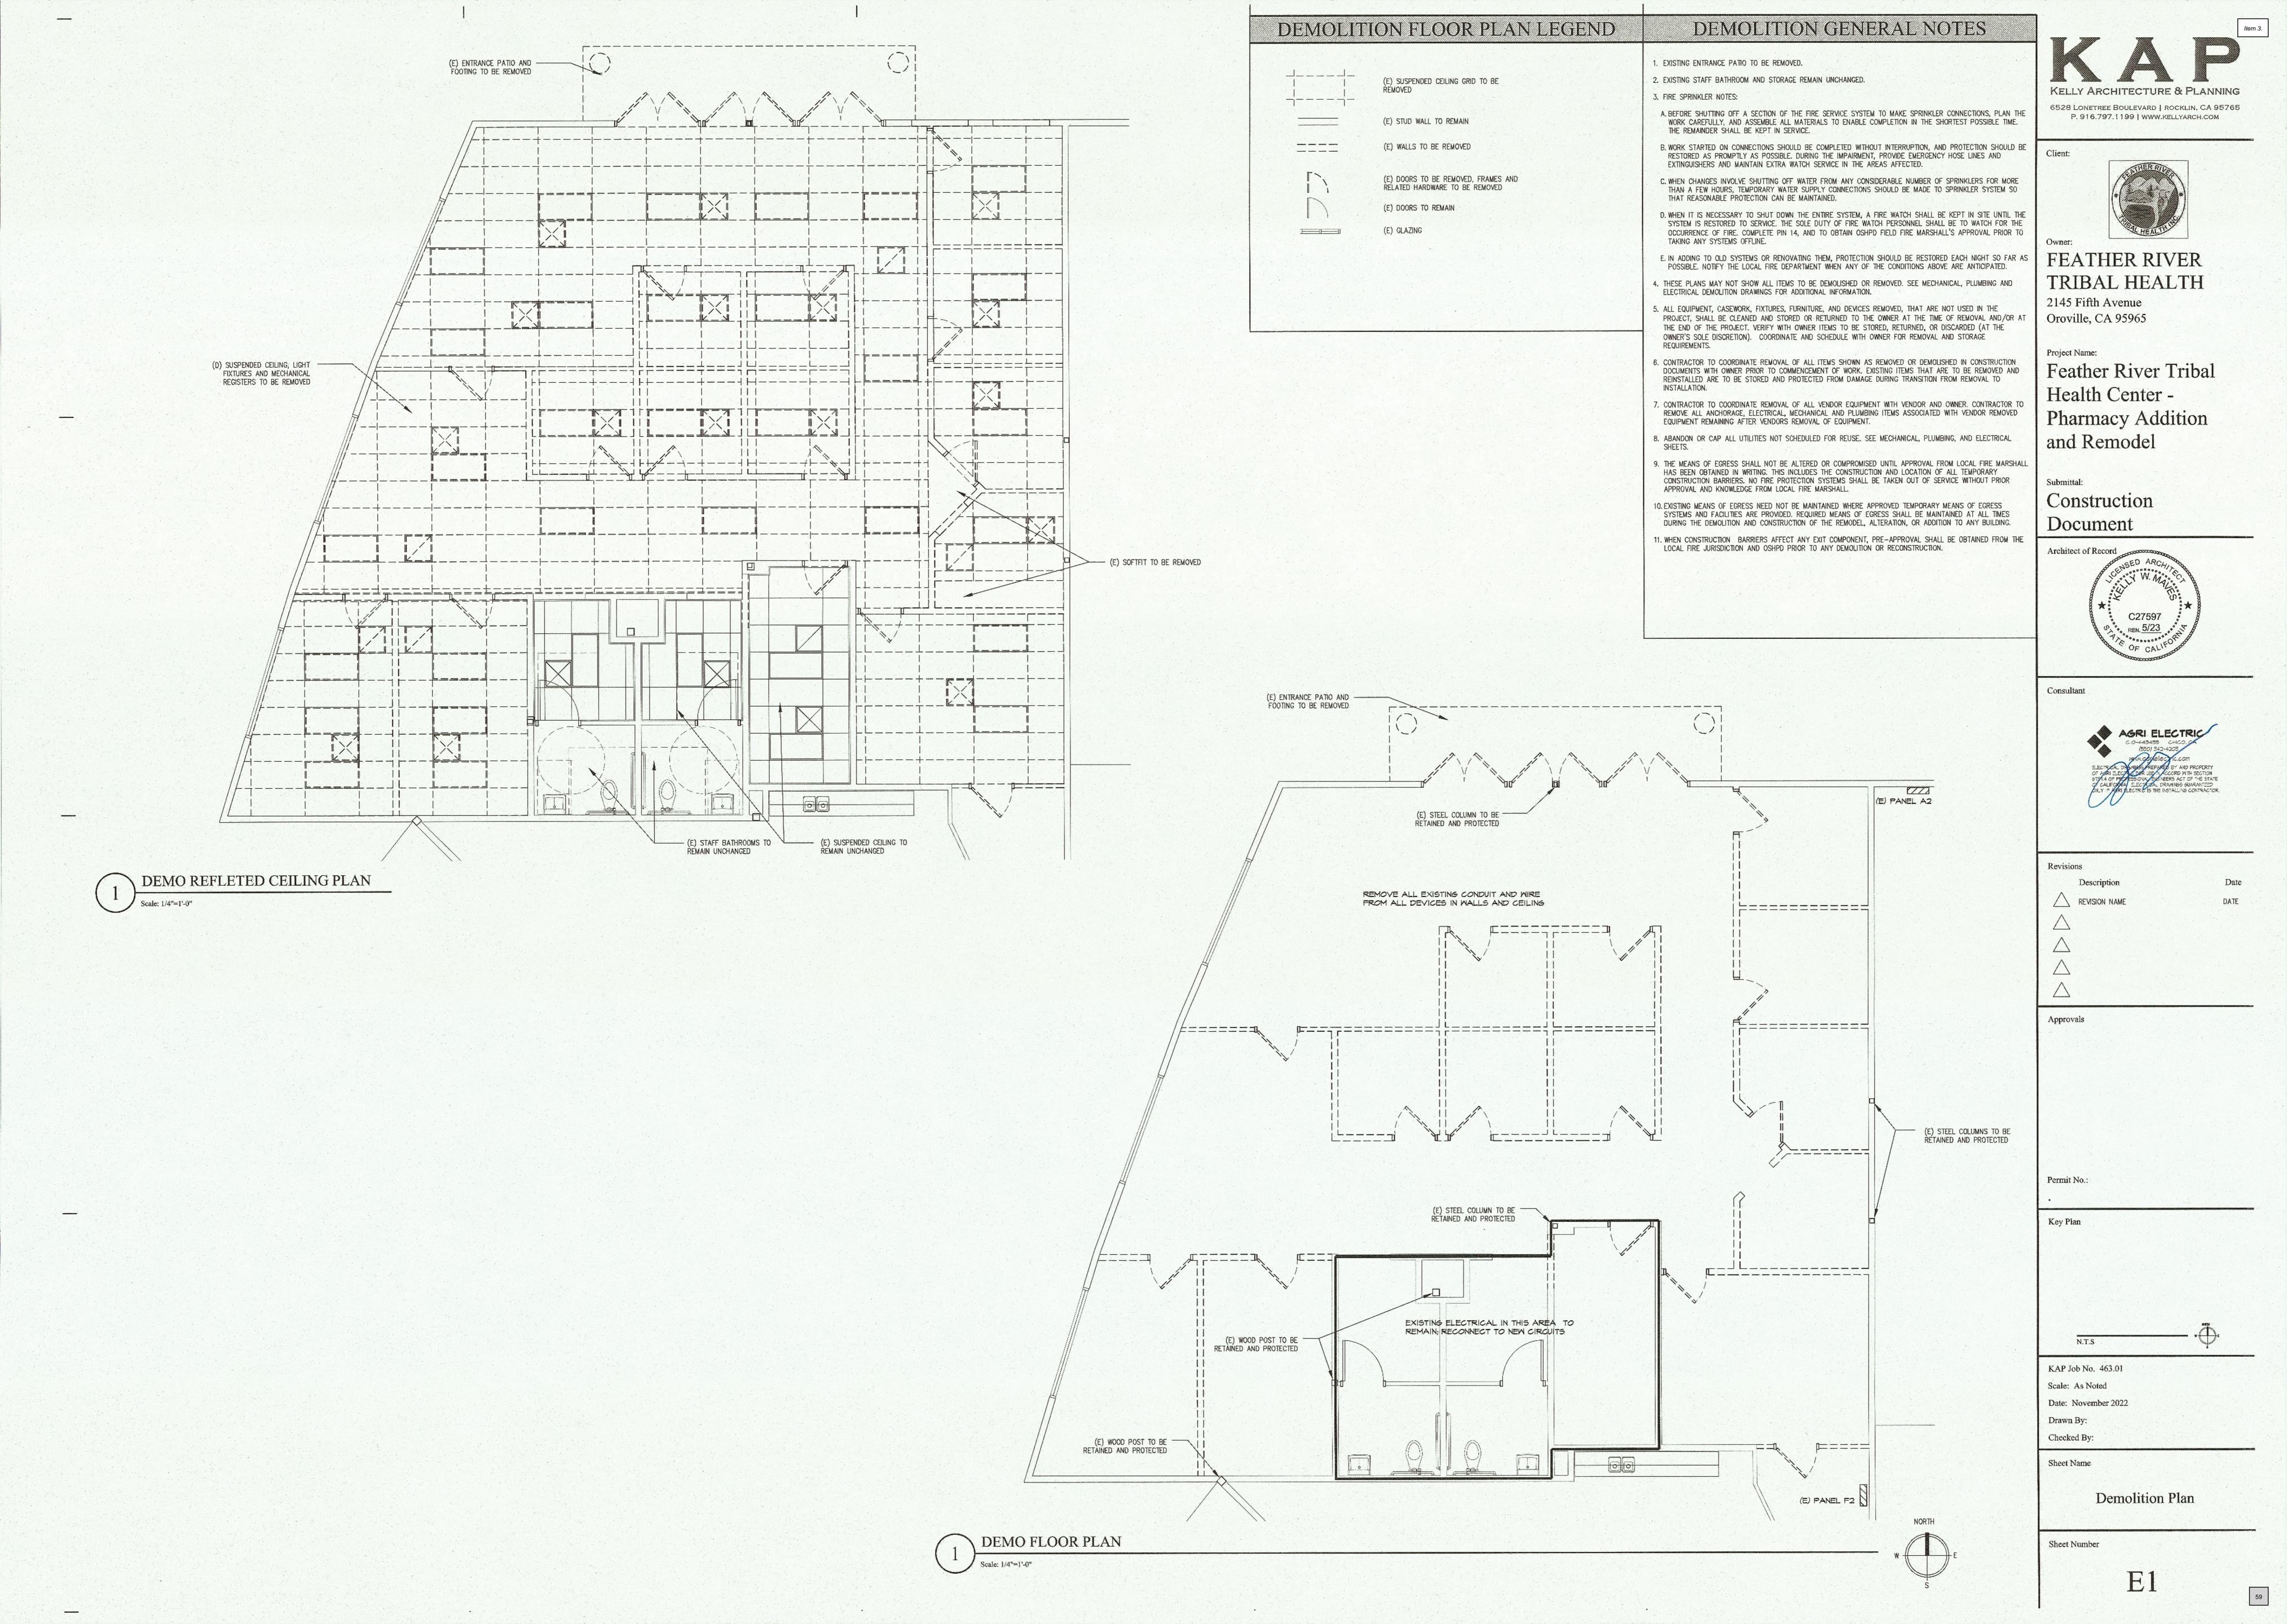
Item 3. REVISIONS 12/22/22 CHECKED DATE 12/22/22 S C A L E |/4" = |'-0" JOB NO. P1-1 OF X SHEETS




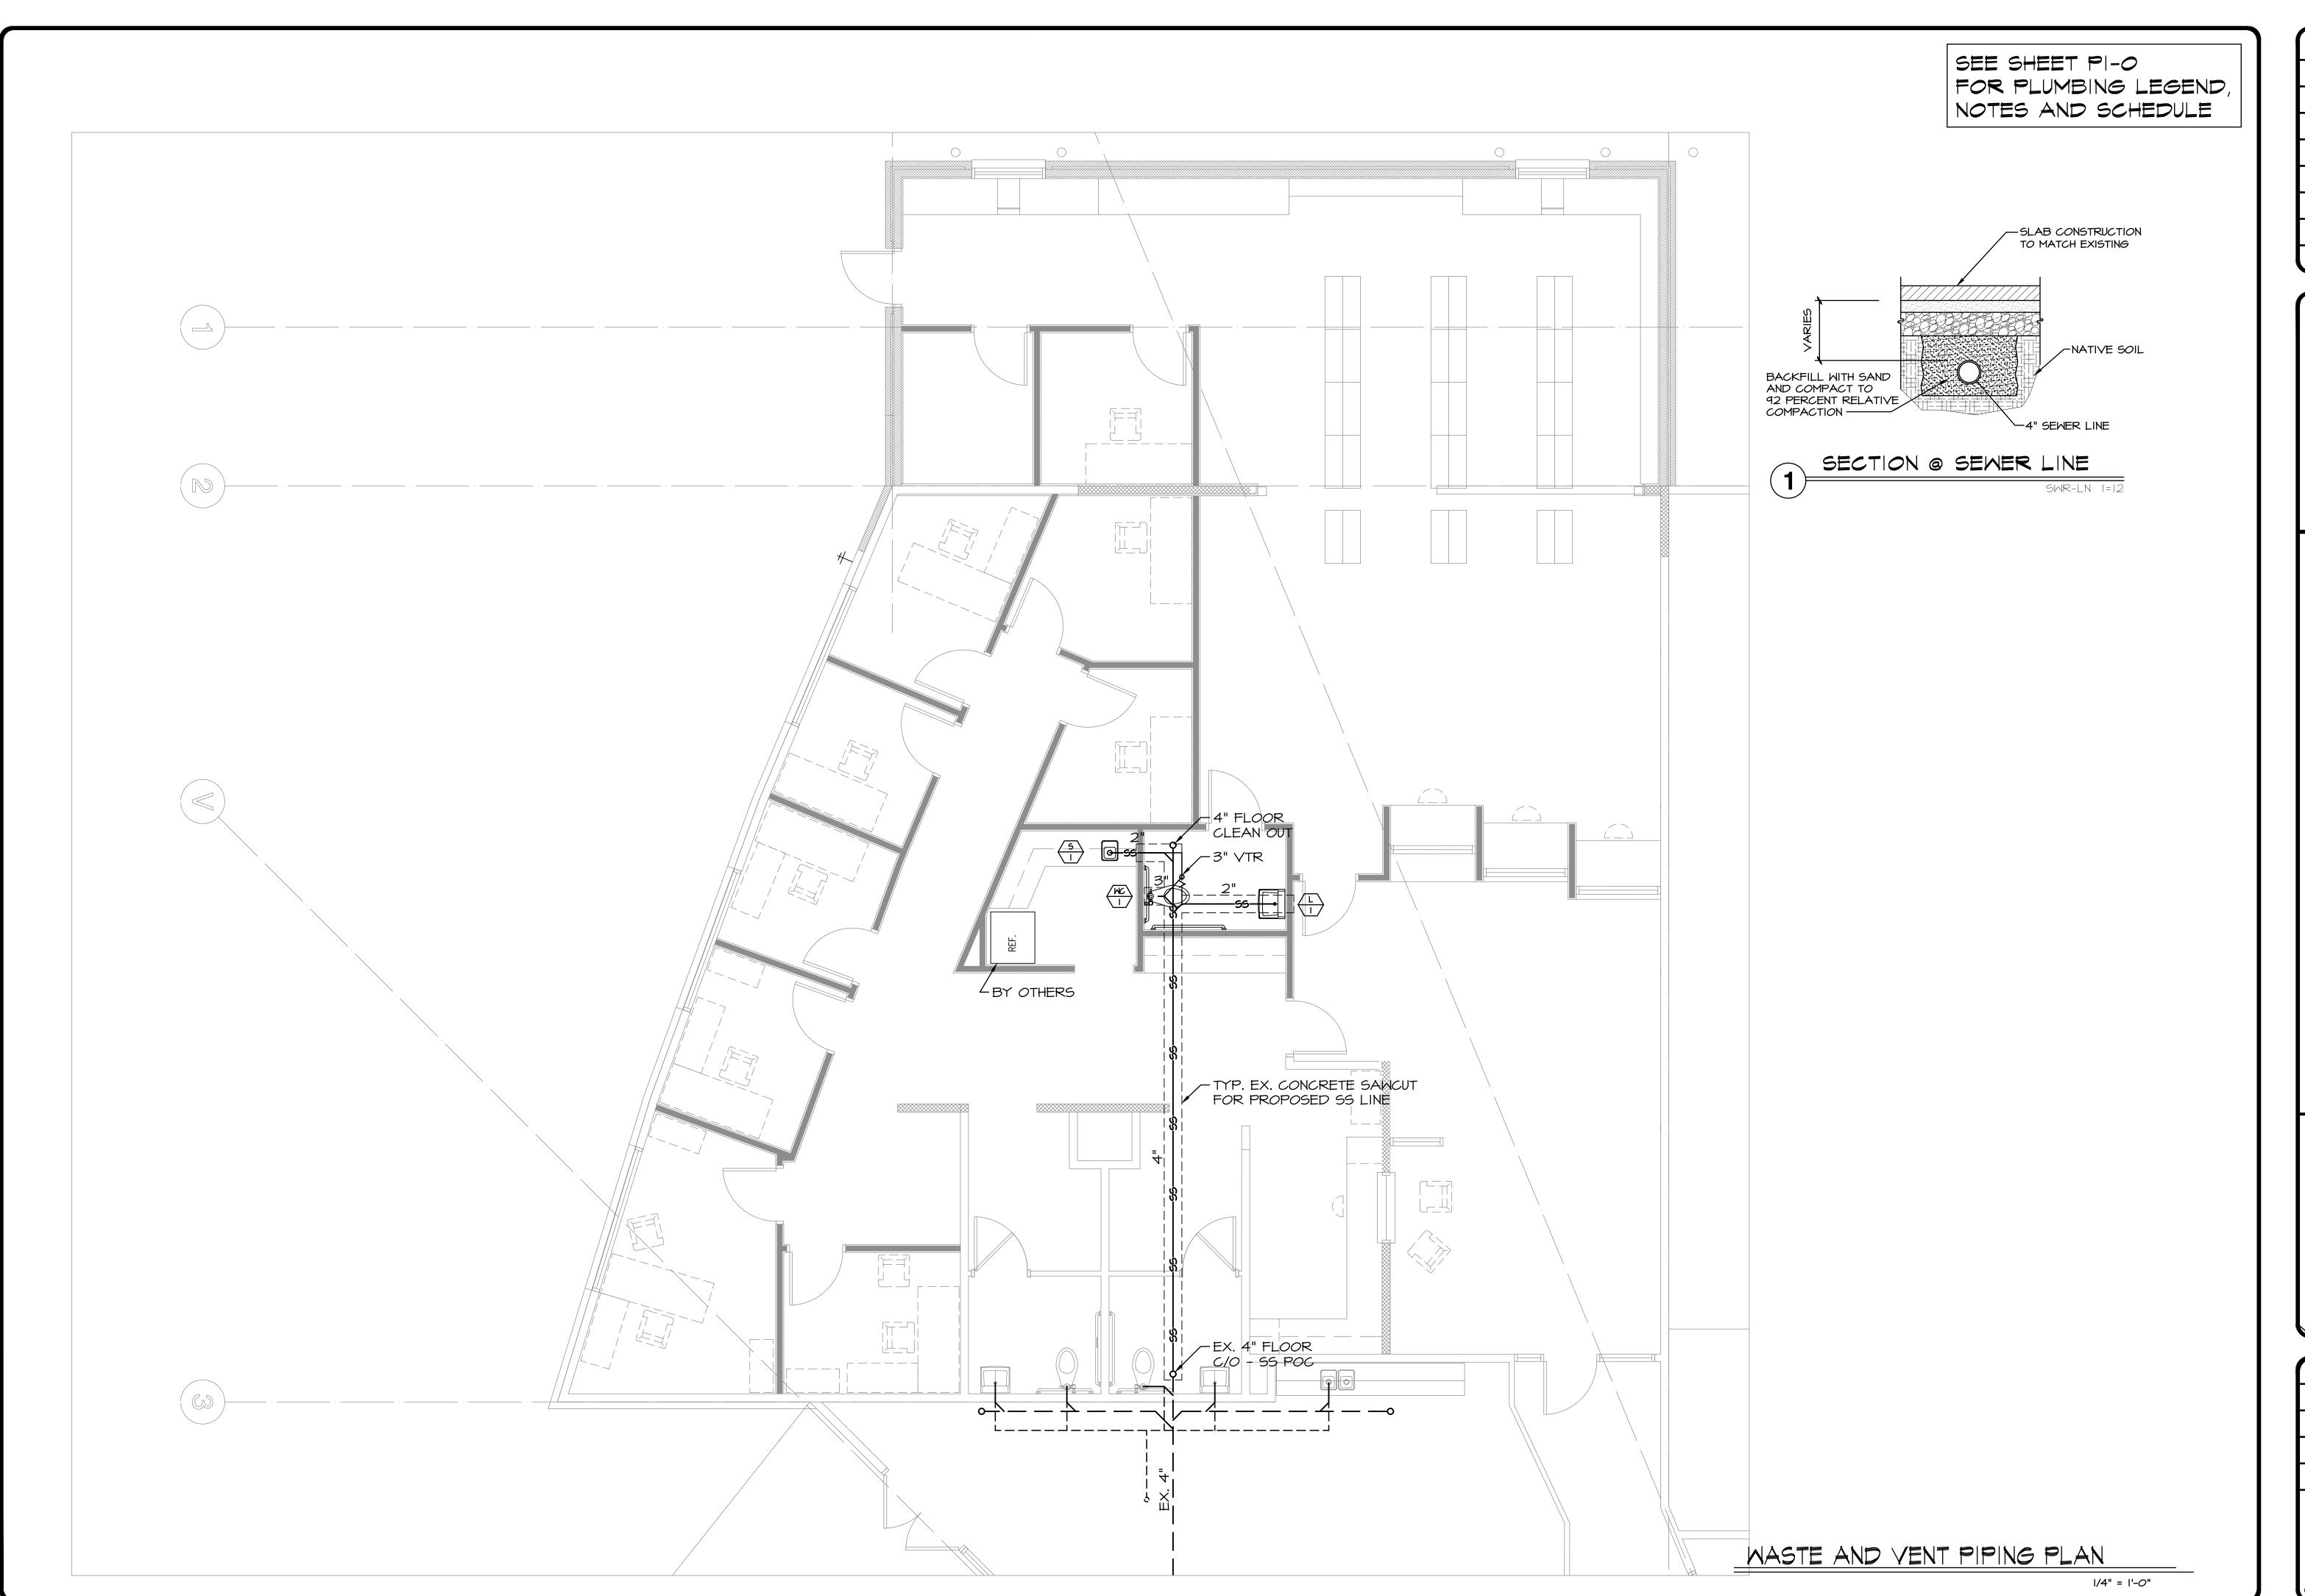


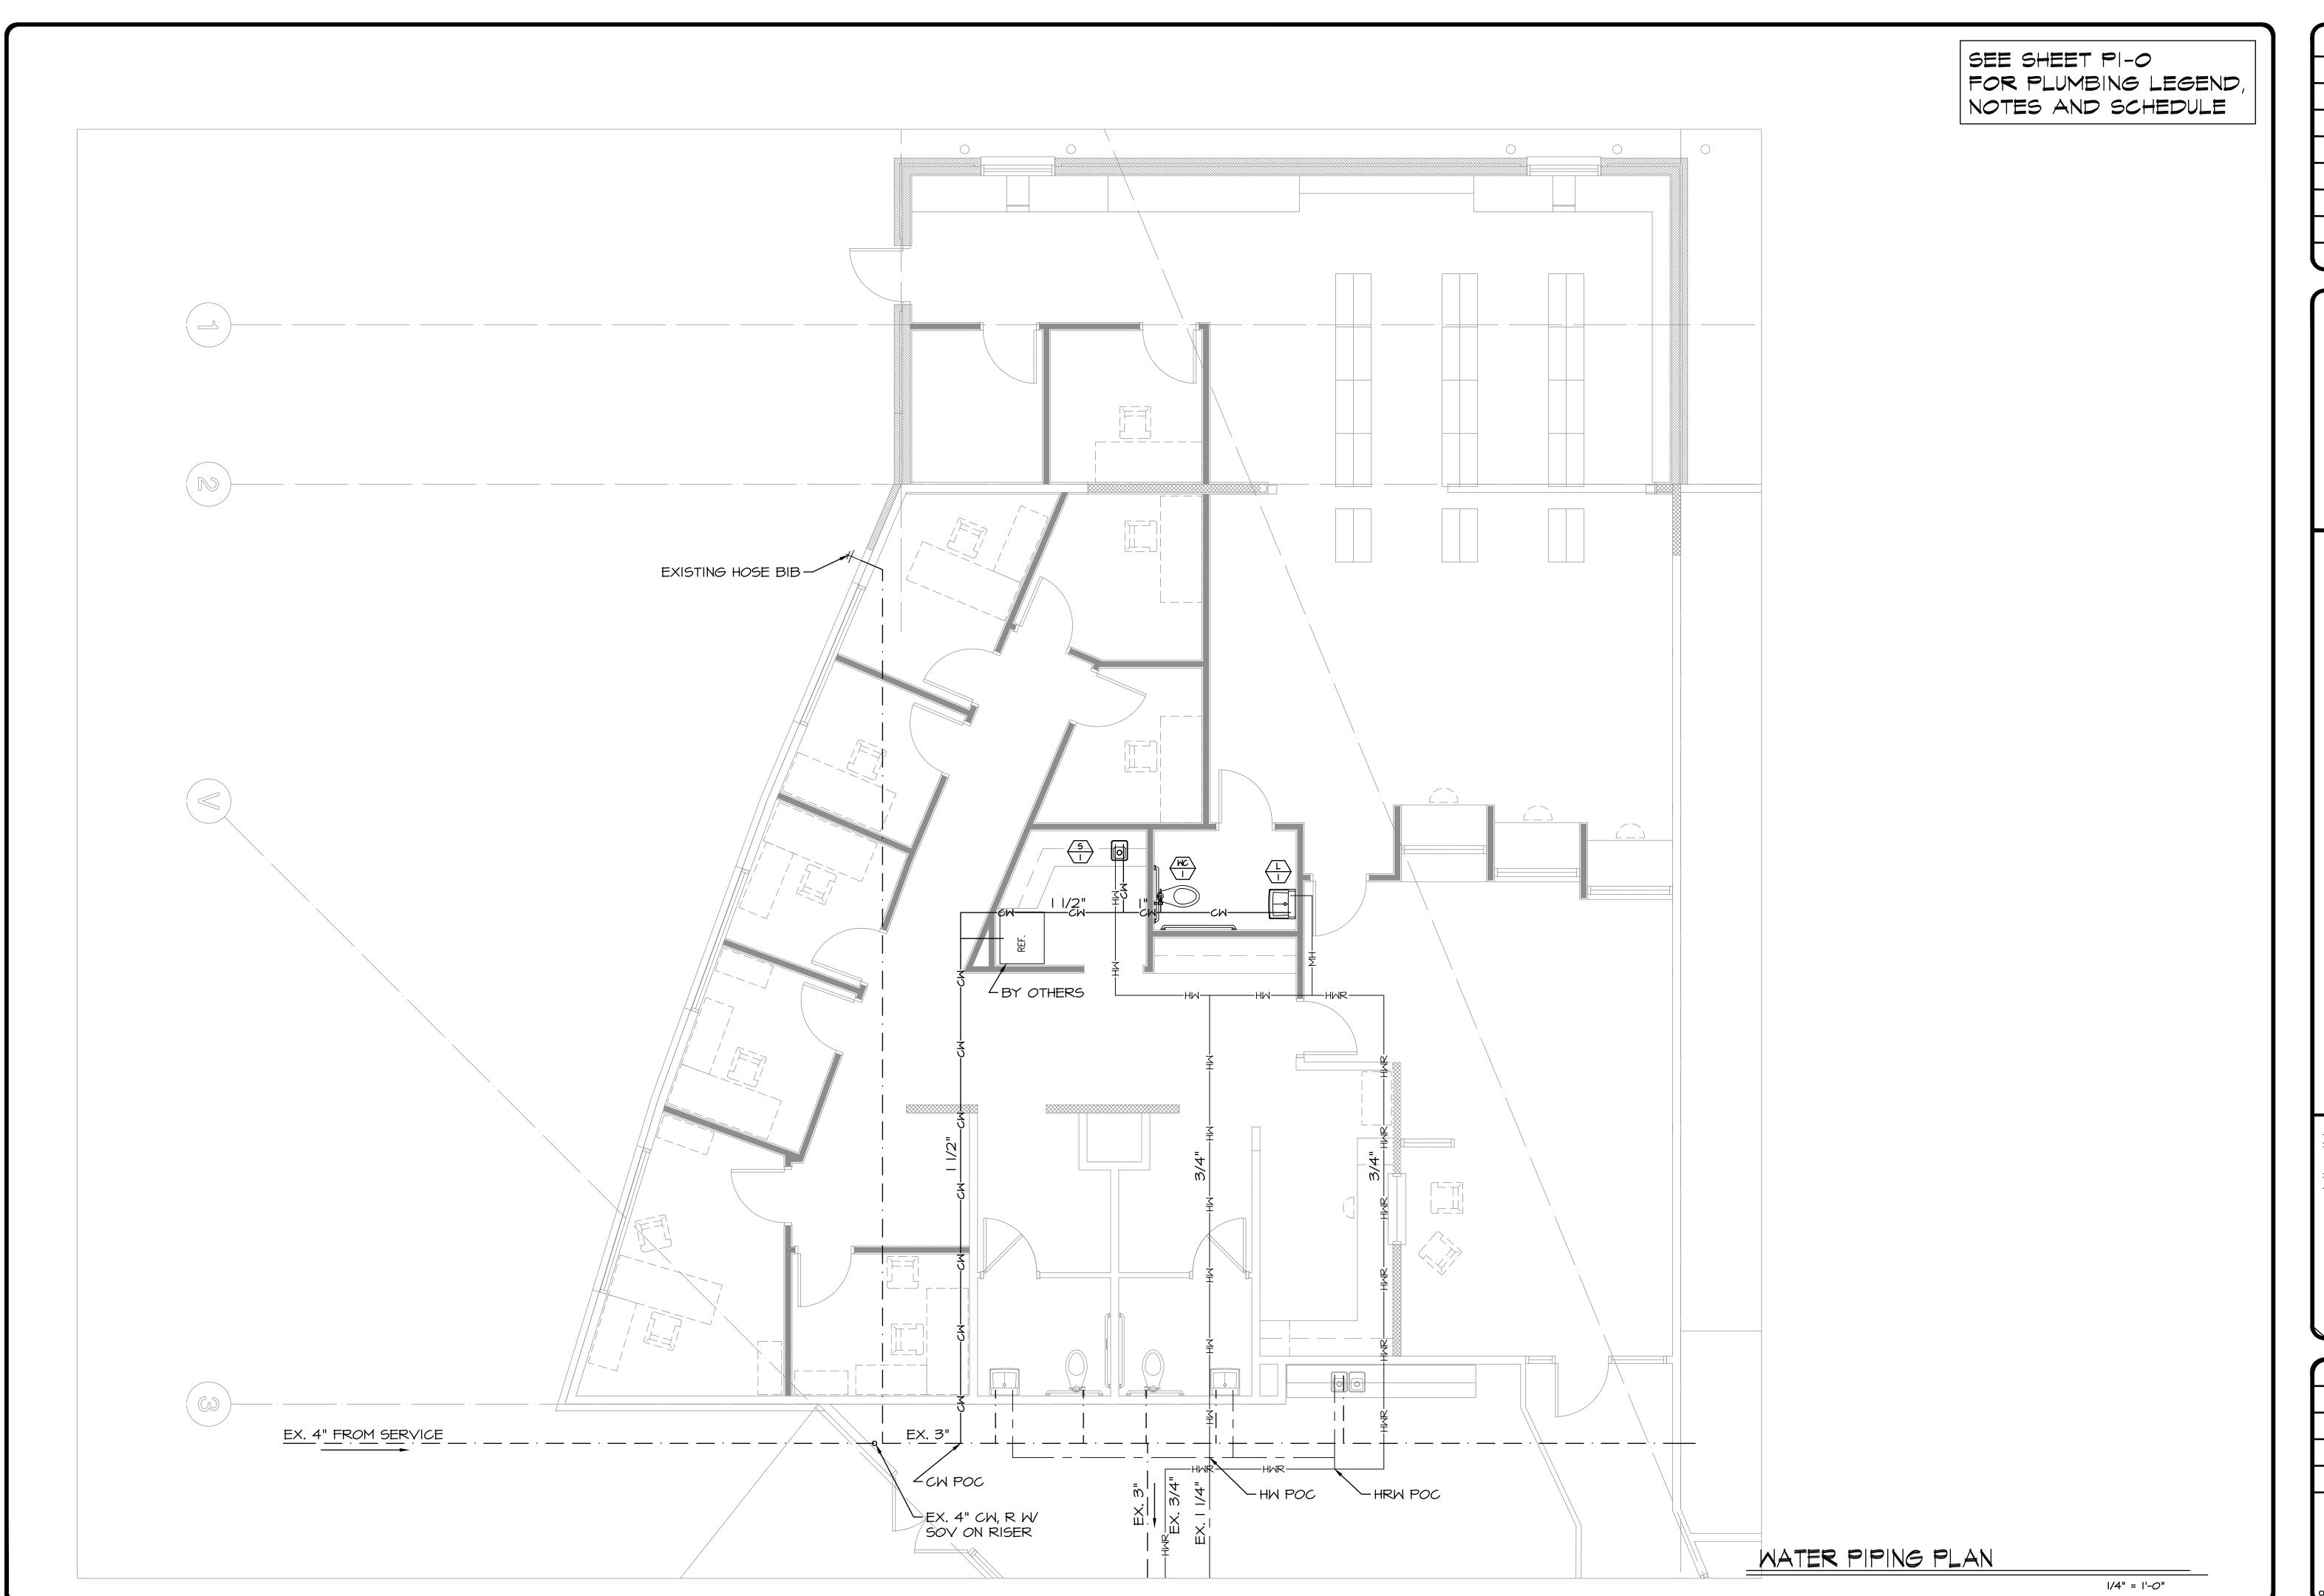


Item 3. REVISIONS 12/22/22 CHECKED DATE 12/22/22 S C A L E |/4" = |'-0" JOB NO. P3-1

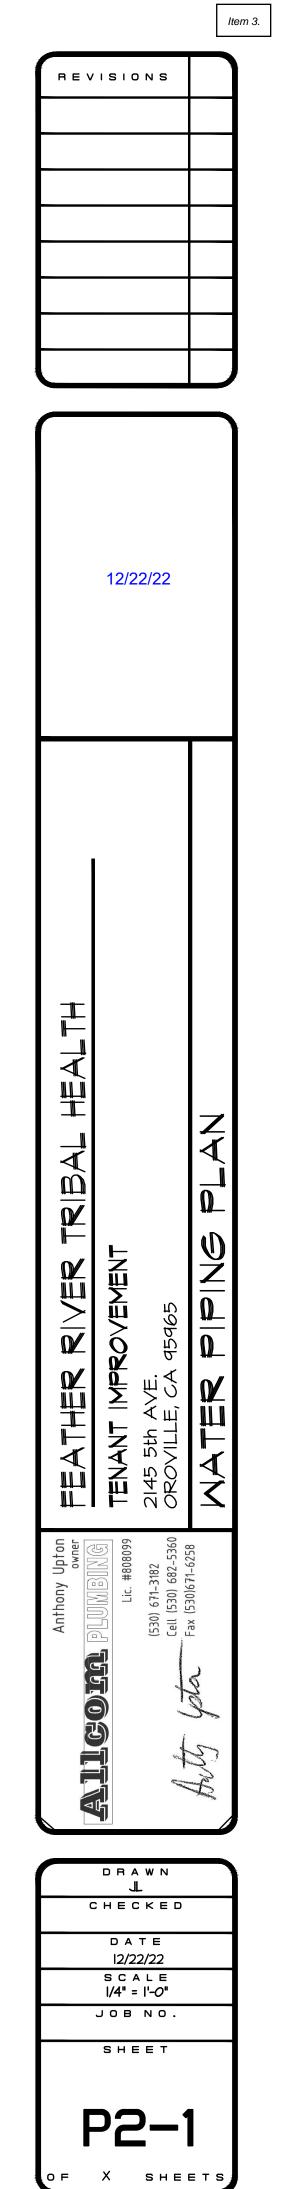

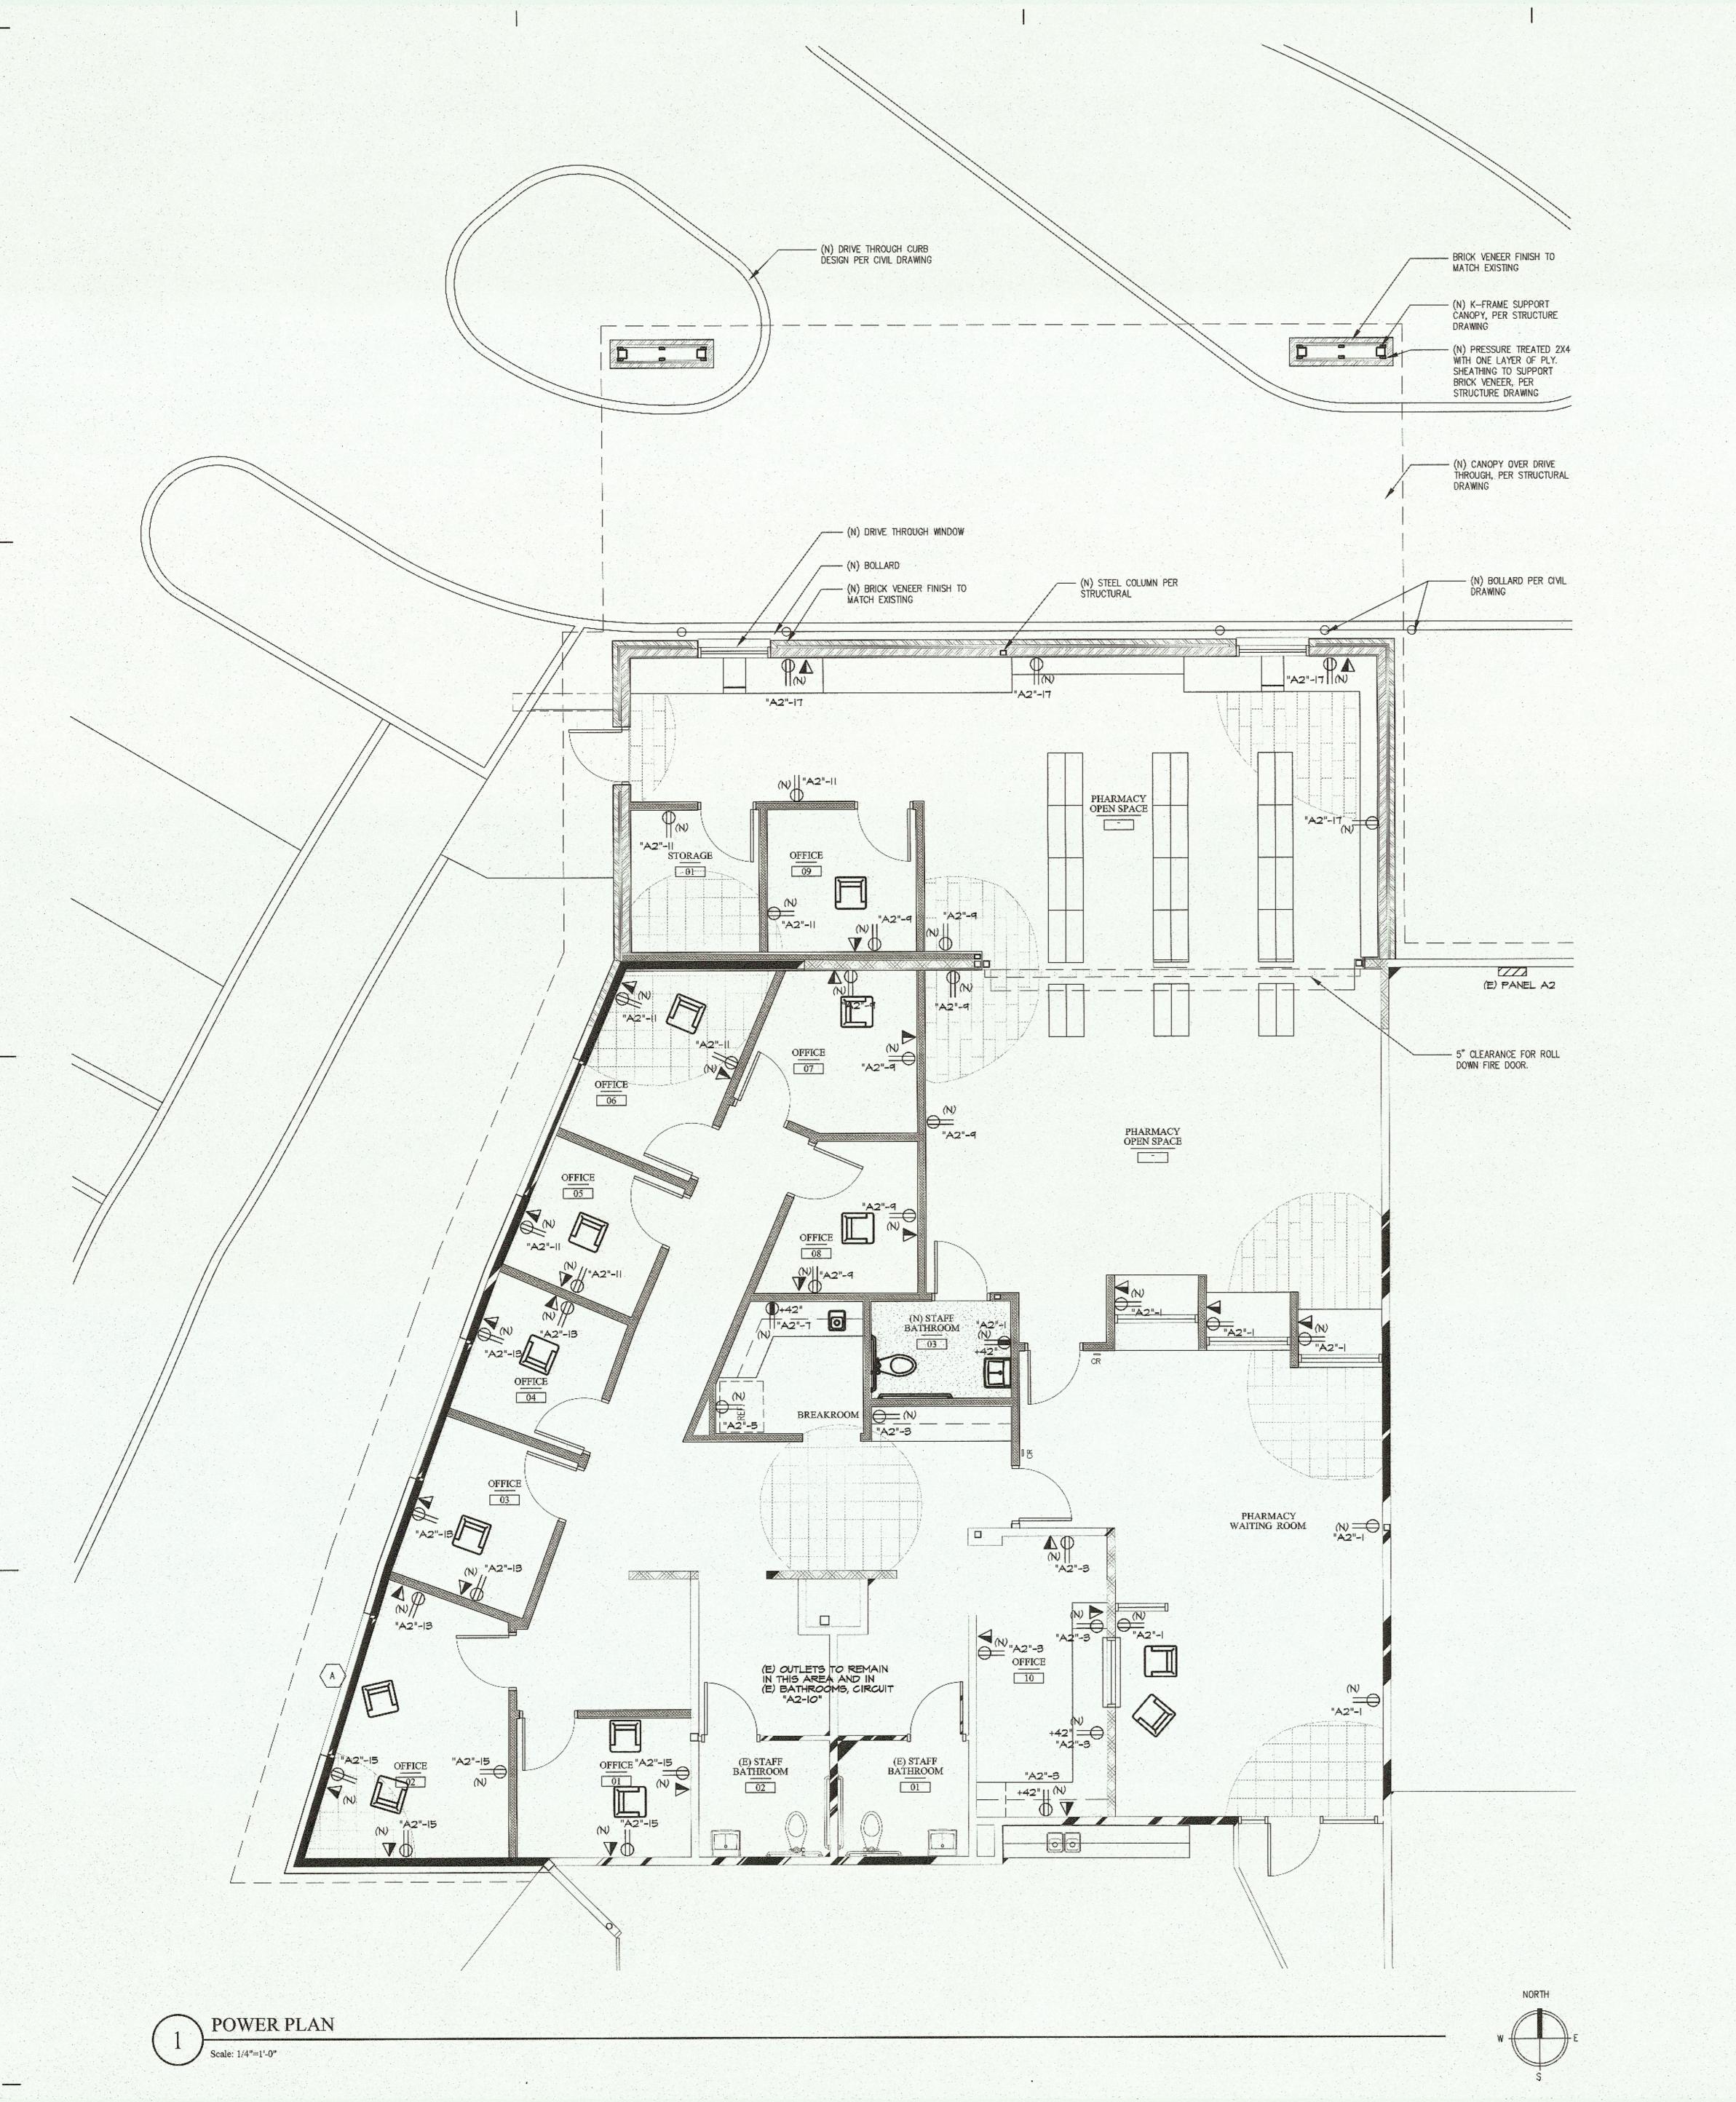

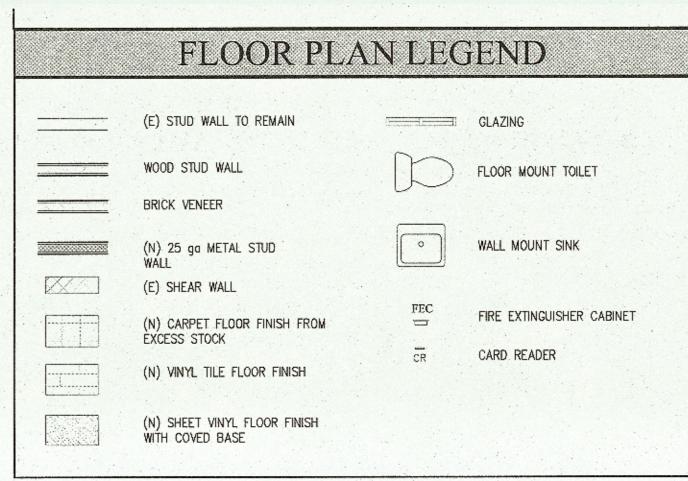

### ELECTRICAL SYMBOLS 15 OR 20 AMP 125V DUPLEX RECEPTACLE 9 +18" UNO 15 OR 20 AMP 125Y DOUBLE DUPLEX RECEPTACLE @ +18" UNO 15 OR 20 AMP 125V GFIC DUPLEX RECEPTACLE @ +18" UNO COMBINATION DATA/TELEPHONE OUTLET, RING & STRING TO ACCESSIBLE CEILING, OR PRE-WIRE DEVICES. RUN 2 DATA CABLES, U.N.O. (NUMBER OF CABLES TO BE NOTED BY DEVICE SYMBOL). S SINGLE POLE TOGGLE SWITCH, @ +46" UNO THREE-WAY TOGGLE SWITCH, @ +46" UNO SM MOTION SWITCH, @ +46' UNO OS ACUITY CMR 10 MOTION SWITCH, CEILING MOUNTED (OSD) ACUITY CMR PC ADC DIMMING DAYLIGHT SWITCH, CEILING MOUNTED JUNCTION BOX, SIZE & TYPE AS INDICATED OR REQUIRED FLOOR BOX WITH POWER AND DATA PANELBOARD, MOUNTED AS NOTED ON PANEL SCHEDULE T DISTRIBUTION TRANSFORMER, MOUNTING AS NOTED A FIXTURE TYPE LED OR FLUORESCENT LIGHT FIXTURE - SURFACE OR PENDANT MOUNTED LED OR FLUORESCENT STRIP LIGHT - SURFACE OR PENDANT MOUNTED -O- LIGHT FIXTURE - SURFACE MOUNTED LIGHT FIXTURE - WALL MOUNTED (CU) MECHANICAL EQUIPMENT DESIGNATION / MOTOR CONDUIT RUN CONCEALED BELOW FLOOR OR FINISHED GRADE, PVC SCH 40 CONDUIT CONCEALED IN WALL OR CEILING - HOMERUN TO RESPECTIVE PANEL OR TERMINAL CABINET - UNDERGROUND PVC SCH 40 HOMERUN TO RESPECTIVE PANEL OR TERMINAL CABINET - OVERHEAD DENOTES # OF WIRES. NO MARKS = 2-#12, 1/2" C; CURVED HATCH DENOTES GROUND WIRE. WIRE SIZE INDICATED WHEN OTHER THAN #12. DETAIL DESIGNATION: TOP NUMBER INDICATES DETAIL, BOTTOM LETTER NUMBER INDICATES SHEET WP WEATHERPROOF MT EMPTY CONDUIT WITH PULLSTRING (E) EXISTING NIES NOT IN ELECTRICAL SECTION OF THESE PLANS & SPECS UNO UNLESS NOTED OTHERWISE

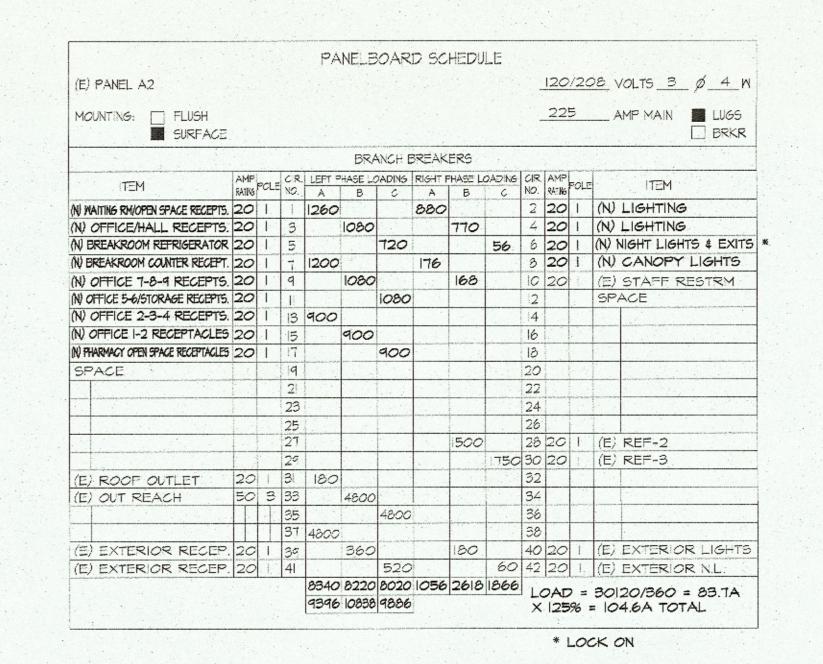






FEATHER RIVER TRIBAL HEALTH 2145 Fifth Avenue

Oroville, CA 95965

Project Name: Feather River Tribal Health Center -Pharmacy Addition and Remodel

Submittal: Construction Document

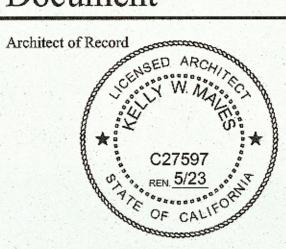

Consultant

Revisions

Description



REVISION	NAME	DATE
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Approvals		
Permit No.:		

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N.T.S
KAP Job No. 463.01
Scale: As Noted
Date: November 2022
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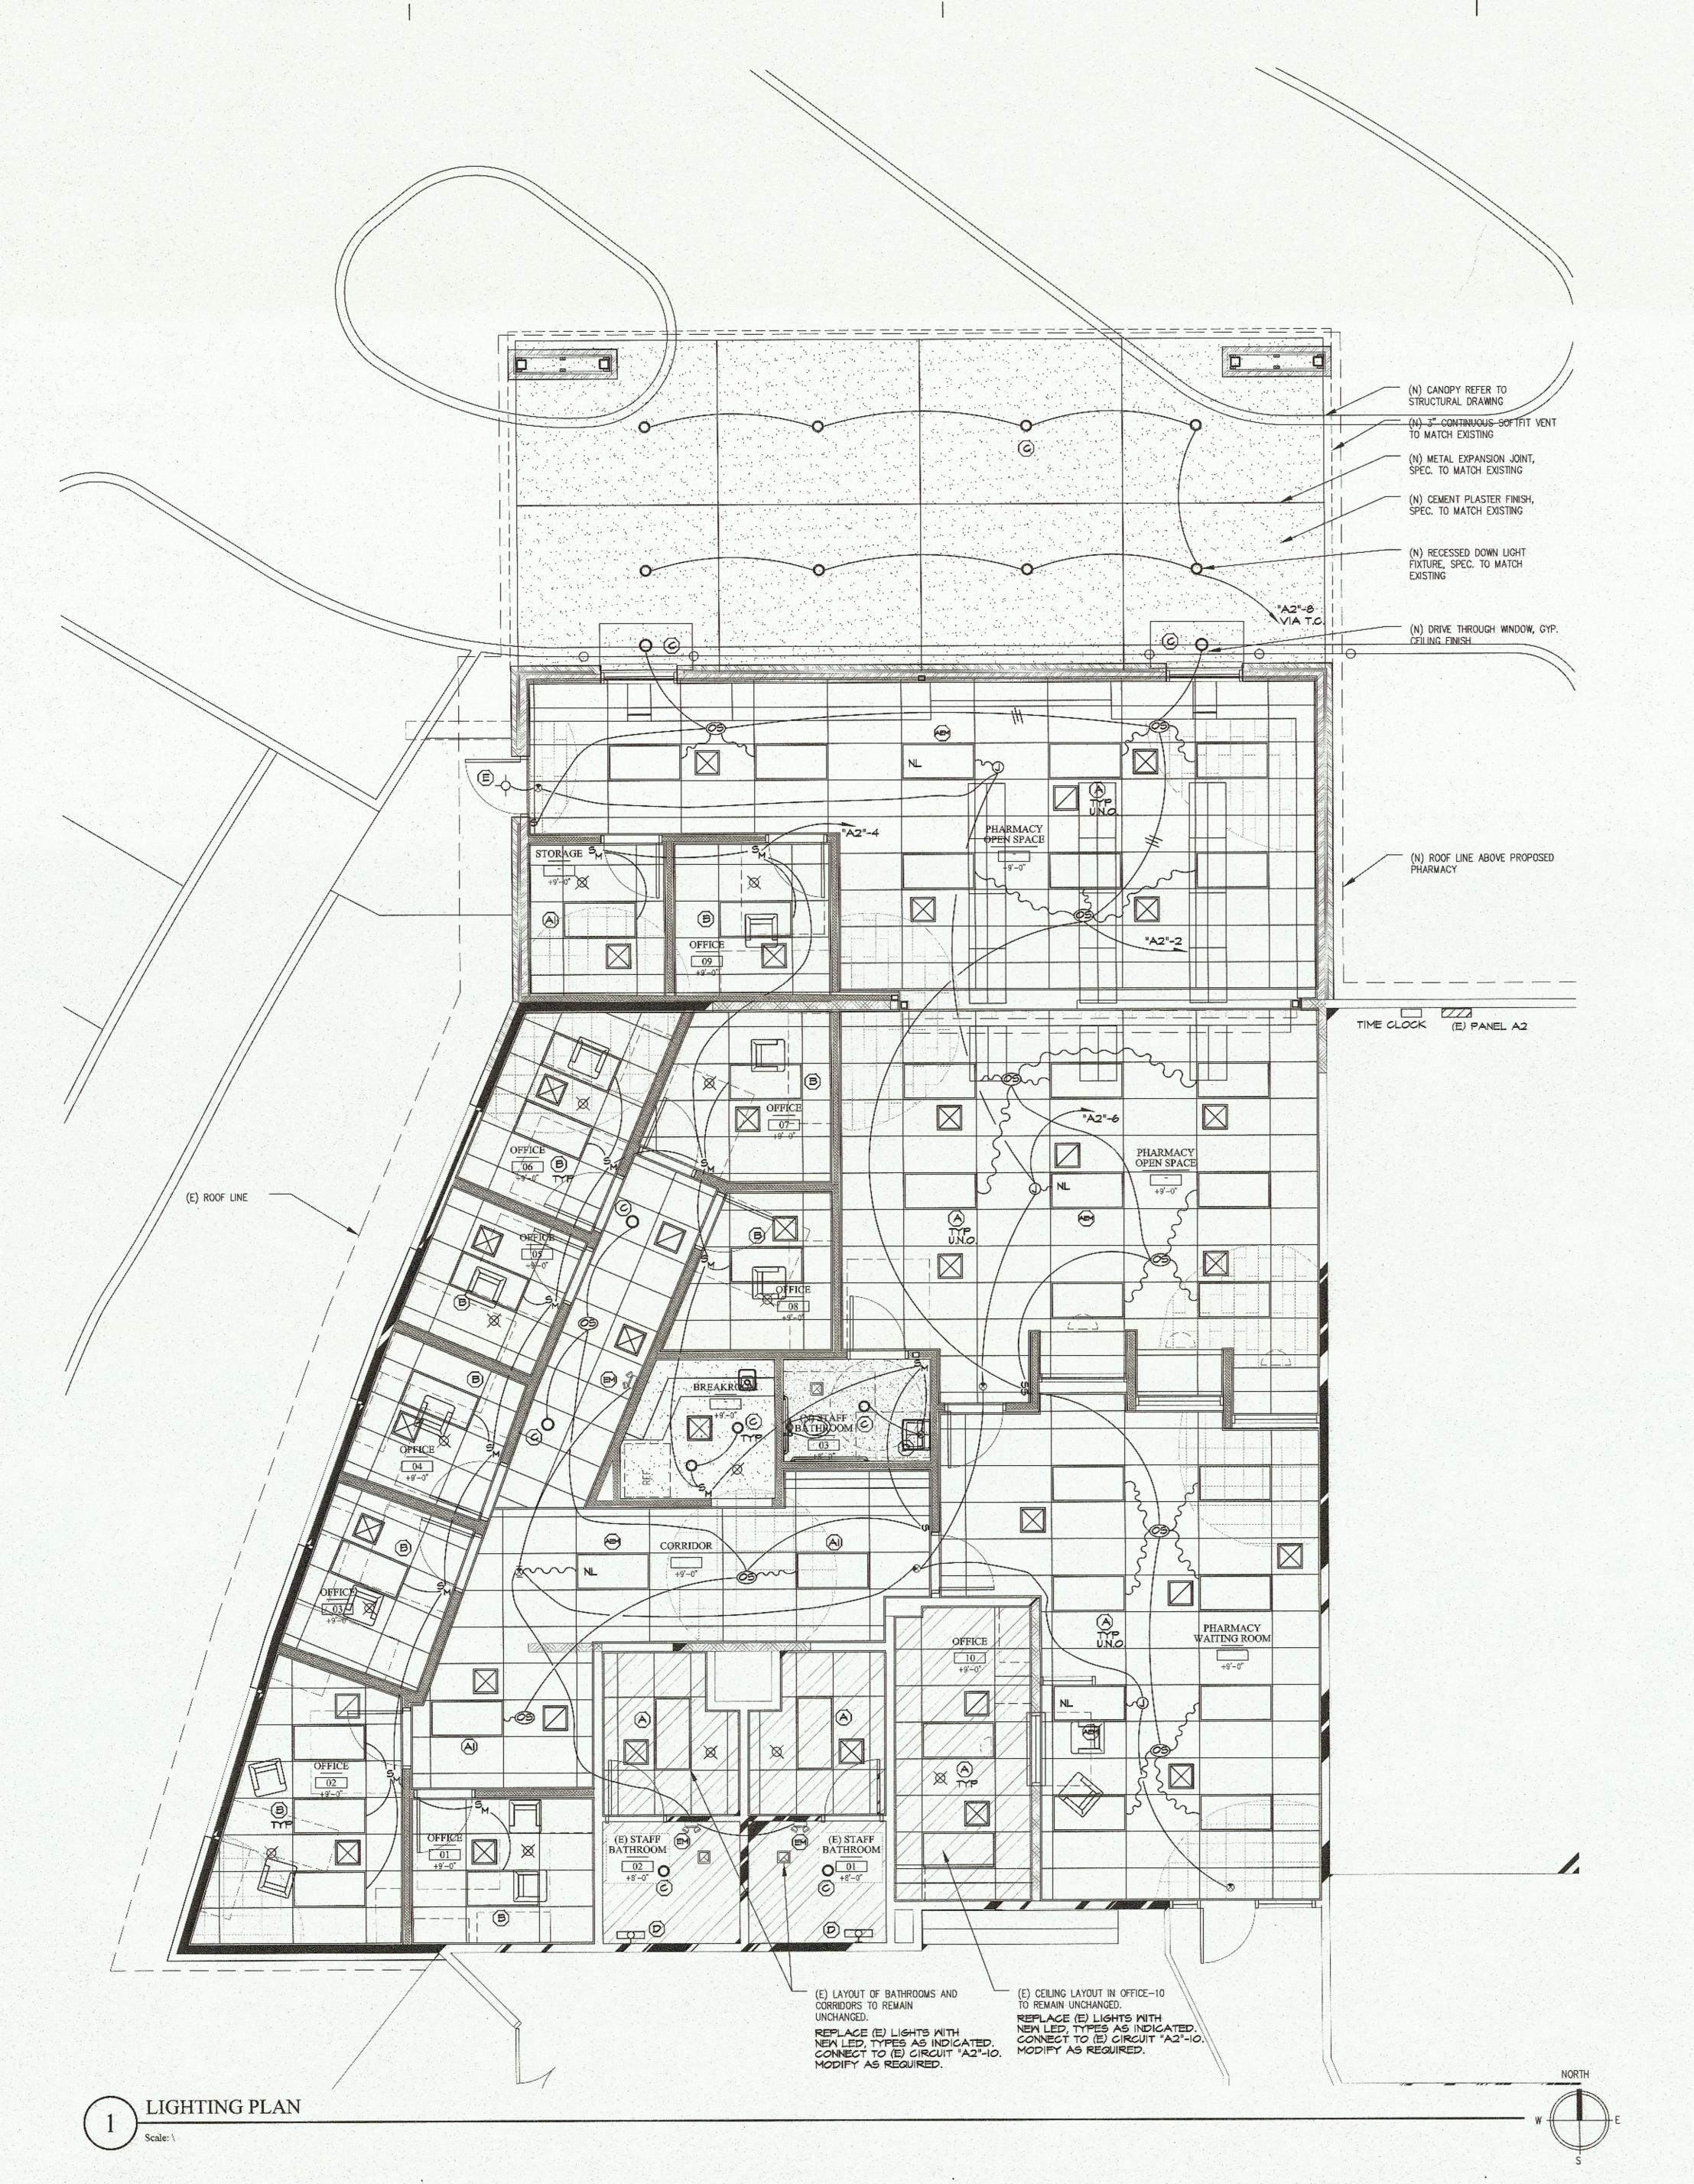
Drawn By:

Checked By: Sheet Name

Key Plan

Power Plan

Sheet Number



TYPE	MANUFACTURER	CATALOG NUMBER	DESCRIPTION	WATTS	LUMENS	MOUNTING
Α	LSI	SFP24 F52UNV DIM FCI5D	LED FLAT PANEL	40	4565	CEILING RECESSED
Al	rei	SFP24 FS2UNV DIM	LED FLAT PANEL	30	3800	CEILING RECESSED
AEM	LSI	SFP24 F32UNV DIM EM FCI6D	90 MIN EMERGENCY LIGHT	40	4565	CEILING RECESSED
В	ral	PEC24 LED SS LPWNWUE FCI5D	LED DIRECT/INDIRECT	44	5070	CEILING RECESSED
c	CREE	SDR8-18-9ACK-TRIIOV WH- UNV	RECESSED DOWN LIGHT	22	2280	CEILING RECESSED
D	LSI	W44	LED WALL LIGHT	22	3000	MALL OVER MIRROR
E	LSI	CSL-ACEM-DB	EMERGENCY EGRESS LIGHT WITH 90 MIN, BATTERY BACK UP	II	1080	ABOVE DOOR
EM	LSI	EAR-LED-UNV-SD-WHT	EMERGENCY LIGHT WITH 90 MIN. BATTERY BACK UP	3.4		MALL MT +8'0"
EXIT	LSI	C-EE-A-EX-2LDF-GRN-BB	EMERGENCY EXIT LIGHT WITH 90 MIN. BATTERY BACK UP	3.7	45 PER HEAD	CEILING

### LIGHTING LOAD SUMMARY

REMOVE 32 3-LAMP FIXTURES: 32 @ 97.9 WATTS = 3133 WATTS TOTAL INSTALL NEW LIGHT FIXTURES: 25 @ 40 WATTS = 1000 WATTS 3 @ 30 WATTS = 90 4 @ 40 WATTS = 160 12 @ 44 WATTS = 528 17 @ 22 WATTS = 374 3 @ 22 WATTS = 66 1 @ 11 WATTS = 11 3 @ 3.4 WATTS = 10.2 5 @ 3.7 WATTS = 18.5

2257.7 WATTS TOTAL

TOTAL SAVINGS = 875.3 WATTS / 120V = 7.3A SAVINGS






FEATHER RIVER TRIBAL HEALTH 2145 Fifth Avenue Oroville, CA 95965

Project Name:

Client:

Feather River Tribal Health Center -Pharmacy Addition and Remodel

Construction Document

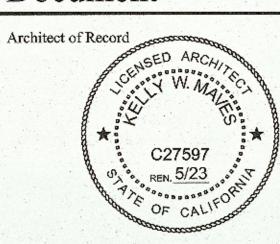

Consultant



Revisio	ns	
	Description	Date
	REVISION NAME	DATE
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	NEW RCP LEGEND
	2x4 ACOUSTIC CEILING PANELS, SEE FINISH SCHEDULE
	(N) 5/8 TYPE 'X' GYPSUM BOARD, SEE FINISH SCHEDULE
	(E) CEILING TO BE RETAINED
	NEW 2'-0"x4'-0" LIGHT FIXTURE, SEE LIGHT FIXTURE SCHEDULE FOR TYPE.
0	RECESSED DOWN LIGHT FIXTURE, SEE LIGHT FIXTURE SCHEDULE FOR TYPE.
	HVAC RETURN / SUPPLY, SEE MECHANICAL DRAWINGS.
	HVAC EXHAUST FAN, SEE MECHANICAL DRAWINGS.
<u> </u>	SURFACE MOUNTED INTERIOR LIGHT
×	FIRE SPRINKLER HEAD. SEE FIRE SPRINKLER DRAWINGS
(SD)	SMOKE DETECTOR
© .	CARBON MONOXIDE DETECTOR
	EXIT SIGN/LIGHT

Permit No.:

Key Plan

KAP Job No. 463.01 Scale: As Noted Date: November 2022 Drawn By:

Checked By: Sheet Name

LIGHTING PLAN

Sheet Number

# ATHER RIVER

#### Feather River Tribal Health, Inc.

Sponsoring Tribes: Berry Creek Rancheria, Mooretown Rancheria & Enterprise Rancheria

OROVILLE CLINIC
2145 5<sup>th</sup> Avenue ◆ Oroville CA 95965
(530) 534-5394

YUBA CITY CLINIC 555 West Onstott Road ◆ Yuba City CA 95993 (530) 751-8454

January 24, 2023



Planning Commission City of Oroville 1735 Montgomery Street Oroville, CA 95965

RE: Application by Feather River Tribal Health, Inc. to remodel its pharmacy

Dear Esteem Members of the Planning Commission:

It is my understanding that an application for the remodel of our pharmacy is on the agenda for the January 26, 2023 meeting at 6:00 p.m. We received a telephone call indicating that further information was needed explaining our project. I would like to provide you with the following information.

Feather River Tribal Health (FRTH) currently operates an in-house pharmacy at our Oroville facility. We serve all Native Americans residing in the 3-county service area of Butte, Yuba and Sutter counties. The facility is licensed through the State of CA as part of our licensure as a Community Clinic. At this time, our pharmacy is only open to Native Americans served by our program. Non-Natives are not eligible to access this service.

With the advent of COVID, there was a hardship created when patients needed their medications. Our Board of Directors decided to develop a method that would allow our patients to be able to get their medications without having to enter the building. It was determined that we would create a drive-thru window for patients to be able to get their medications without entering the building.

During the development of the plans, we realized that the current location of our pharmacy did not lend itself to the design. In reviewing the layout of our building, we decided to move the pharmacy from its current location to another wing of our building that would allow for the patients to drive up and get their medications.

It is our understanding that the contractor for the project, Hilber's Construction, submitted an application stating that we were opening a public pharmacy. That is not correct. The only patients that would be eligible for use of this pharmacy

are patients that are registered as patients of our facility and have had a prescription written by one of our providers or for a Native patient for which we referred out for specialty care and had a prescription written to address the needs of the specific referral.

This action was taken in response to the COVID-19 pandemic. As a community clinic, we have seen numerous emergencies in our service area. Our Board's response to this next emergency is to plan for our patients' future by expanding the pharmacy service to make it more accessible to the patients we serve.

We are happy to answer any questions you might have regarding our application. Representatives from our agency will be present at the Planning Commission meeting on 1/26/23 to answer any questions you might have.

We thank you for your consideration of our request.

Sincerely,

Maria Hunzeker

Chief Executive Officer

Maria Hunseker

cc: Board of Directors, FRTH



#### **City of Oroville**

Planning Division - Community Development Department

1735 Montgomery Street Oroville, CA 95965-4897 (530) 538-2430 FAX (530) 538-2426 www.cityoforoville.org

TRAKIT#: PL 2212-010

#### **USE PERMIT APPLICATION**

(Please print clearly and fill in/provide all that apply)

	PEOI	JIRED FOR A COMPLETE		ICATION	1111111	Jiovide all tila	t app	<del>-</del>	
	1			ICATION				PERMIT	TYPE
	Complet	ed and signed Application F	orms			New Use Peri \$2,889.98 (De	posit	) + \$173.4	0(6% Tech Fee) = \$3,063.38
Ш	Applicati	on Fee Paid			X	Amendment to \$1,024.09 + \$	61.45	sting Use F 6 (6% Tech	Permit: n Fee) = \$1,085.54
				PROJEC	T PL	ANS			
All p	lans and o graphic fe	drawings shall be drawn to seatures and all information n	scale t ecess	o the extent feasibl ary to make a full e	e and	shall indicate to tion of the proje	he ful	l dimensio ease inclu	ns, contours and other de the following:
	1. Site	and floor plans, including	the lo	cation, square foots	age a	nd use of all str	ucture	es.	***************************************
	2. Arc	<b>hitectural drawings</b> showir	ng pro	posed building elev	ation	3,			
	3. Lan	dscape plans showing the ty	/pes, s	sizes and location o	of veg	etation to be pla	anted	and the in	rigation system to be installed
	4. Plar	s for the configuration & lay	out of	all off-street parkin	ng spa	ices, including e	entran	ices, exits	and internal circulation routes.
	5. Plan	s for all lighting to be install	ed on	the site, including t	he lo	cation, type, hei	ght ai	nd brightne	ess of each lighting fixture.
2 72	6. Drav	wings of all signs that are	propos	sed in association v	vith th	e project.			
	7. Plan	s showing the location, sq f	ootage	e and capacity of a	ny exi	sting or propose	ed su	rface storr	n-water detention facilities,
	8. Plan	s showing the location and	square	e footage of any ex	isting	or proposed ou	tdoor	storage a	reas.
83 G <u>.</u>	9. Desc	criptions of any off-site infra	structu	ure improvements to	o be p	rovided in conj	unctic	n with the	project.
	10. Hou	rs of operation for all propos	ed lar	nd uses.					
	11. Num	ber of employees and fleet	vehicl	es for all proposed	land (	uses			
	12. A let	ter authorizing the use pe	rmit a	application from the	ne ow	ner of the prop	perty.		
				CLASSIF	ICAT	ION			
	Alcohol &	Beverage Sales		Nonconforming l	Jses	& Structures		Uses in	Industrial Districts
	Agricultur	al Uses		Outdoor Storage				Uses M	ini-Storage Overlay(MS-O)
	Animal K	eeping (Commercial)		Parking Requirer	ment	Exceptions		Uses in	Residential Districts
	Barbed/R	azor Wire Fence		Temporary Use				Uses in	Special Purpose Districts
	Density B	onus & Other Incentives		Uses in a Condit			х	Uses no	ot Specified but Allowed
	Exception	s to Height Limits	х	Uses in Commer Districts	cial &	Mixed-Use		Wireless	S Communication Facilities
	Other: (Pl	ease Specify)						4	
				APPLICANT'S					
	-	I hereby certify that the inf	ørmati	on provided in this	applic	cation is, to my	knowl	edge, true	and correct.
Signa	ture:	Fal 11	2					Date:	12-31-22
				OFFICE US	SE ON	ILY		Was a little	7
	ved By:							Date:	
Paym	ent:							Number:	

PROJECT DESCRIPTION									
Present or Previous Use:	Offices / Patio								
Proposed Use:	Drive Thru Pharamcy								

**Detailed Description:** 

To add drive thru with additional building square footage of 791 Sq Ft to existing 2730 square foot area. And covered drive of 844 square feet. This area will be for the relocated pharmacy with new proposed drive thru.

At this time the pharmacy will be open to member of FRTH only but in the future it may be open to the general public.

Hours of operation are from Monday thru Friday 7am to 6pm.

No exterior storage is proposed with this construction.

No off site construction is proposed or will be required with this construction.

No fleet vehicles or additional personal are required per this construction.

The owner is submitting this application.

Any additional lighting, sign-age, striping, traffic flow required for this addition is shown on drawings.

The Community Development Department operates on a full cost recovery for processing of permits. Staff will charge their time and any expenses associated with processing the application against the initial deposit. Fees that have been captured for the reimbursement of City expenses are non-refundable.



#### **City of Oroville**

Planning Division - Community Development Department

1735 Montgomery Street Oroville, CA 95965-4897 (530) 538-2430 FAX (530) 538-2426 www.cityoforoville.org

TRAKIT#:

### PLANNING DIVISION GENERAL APPLICATION

(Please print clearly and fill in all that apply)

Name: Feather River Tribal Health Name: Mark Hadrick  Address: 2145 5th Avenue Company: Hilbers Inc  Phone: 530-762-9115 Address: 770 North Walton Avenue  Final: art.thomas@frth.org Phone: 530-701-2792  Is the applicant the Owner? Project Same Application Phone: 530-701-2792  Is the applicant the Owner? Mark Incomplete Incompany: Phone: 530-701-2792  Is the applicant the Owner? Mark Incomplete Incompany: Phone: 530-701-2792  Is the applicant the Owner? Mark Incomplete		APPLIC	AN'	T'S INFO	RM.	ATION	Project's: Contractor								
Address: 2145 th Avenue Company: Hilbers Inc Phone: 530-762-9115 Address: 770 North Walton Avenue  Email: art.thomas@frth.org Phone: 530-701-2792  Is the applicant the Owner? Please provide of the avenue, please provide of the applicant on the retrieval please provide of the applicant of the owner. Please provide of the avenue, please provide of the applicant of the avenue, please provide of the applicant of the avenue of the avenue please provide of the avenue of the avenue please provide of the avenue of the avenue please provide of the avenue of the avenue of the avenue please provide of the avenue of the avenue of the avenue please provide of the avenue of the a	Name:		_					+			1.7.7				
Phone: 530-762-9115  Address: 770 North Walton Avenue  Email: art.thomas@frth.org  Is the applicant the Owner? Image of a profession of the resease and additional professional profe			_		пе	alli	ivame;	IVI	ark	Had	Irick				
Email: art.thomas@frth.org   Phone: 530-701-2792    Is the applicant the Owner?     If applicant is Not the owner, please grounds   Phone: 530-701-2792    Is the applicant the Owner?     If applicant is Not the owner, please grounds   Phone: 530-701-2792    Is the applicant the Owner?     If applicant is Not the owner, please grounds   Phone: The propose of project. Please include any site plans, maps, aerials, photos, and other relevant information that will help us in processing your application.  Project Name: Feather River Tribal Health   Proposed Structure(s) (Sq Ft.): 1,635   Application: Provider is provided in the submitted. Provider: Call Water Assessor Parcel Number: 035-250-080   Poteic Use Ponity   Poteic Use Ponity   Poteic Use Ponity   Poteic Use Provider: Call Water Call Plans is population. Project Use Provider: Call Water Call Plans   Proposed Structure(s) (Sq Ft.): 1,635   Application: Proposed Structure(s) (Sq Ft.): 1,635   Poteic Use Ponity   Proposed Structure(s) (Sq Ft.): 1,635   Poteic U	Address	2145 5th A	ve	nue			Company:	Hil	ber	s In	С				
Is the applicant the Owner?	Phone:	530-762-9°	115	5			Address:	77	0 N	orth	ı Wal	ton A	ver	านе	
Email:   mhadrick@hilbersinc.com	Email:	art.thomas	<b>@</b> f				Phone:	53	0-7	01-2	2792				
Annexation   Landmark / Modification/Demolition   Tentative Parcel Map	Is the appl	icant the Owner?		owner /agent	Not the	e owner, please provide ization on the reverse	Email:	mr	nadr	ick(	@hilb	ersir	ic c	om	
Appeal Mining and Reclamation Plan Tentative Parcel Map  Development Review Pre-Application Use Permit  Final Map Residential Density Bonus Variance  General Plan Amendment/Rezone Temporary Use Wireless Communication Facilities  Landmark Designation Tentative Map Extension Zoning Clearance  ✓ Other: (Please Specify) Application to add additional building footage and drive up windows @ pharmace  ADMINISTRATIVE PERMITS (Please check all that apply)  Adult Oriented Business Outdoor Storage Special Event  Home Occupation Unidoor Display & Sales Street Closure  Large Family Day Care Second Dwelling Unit Tree Removal  Mobile Food Vendor Sign/Temporary Sign Permit  ✓ Other: (Please Specify) Pharamcy with drive up windows and addition of 4,365 square feet  *Please provide a letter addressed to the Planning Division with a detailed description for the proposed project. Please include any site plans, maps, aerials, photos, and other relevant information that will help us in processing your application.  **Any time a set of plans is required, three (3) sets of drawings shall be submitted, unless otherwise directed.  PROJECT INFORMATION  Project Name: Feather River Tribal Health Proposed Structure(s) (Sq Ft.): 1,635  Existing Structure(s) (Sq Ft.): 47,490  Nearest Cross Street: Mitchell Avenue Water Provider: Cal Water  Assessor Parcel Number: 035-250-080 School District: Oroville School Dist  Lot Size (Acres): 8.39 acers Number of Dwelling Units:  APPLICANT'S SIGNATURE  I hereby certify that the information provided in this application is, to my knowledge, true and correct.  Signature: **Mark Market Planning** Zoning: Zoning: Zoning: Conformity: Apn:    Date:   12-30-202:		DEVELO	)PN	ENT PRO	OJE	CTS & OTHER	APPLICATION	S (Please check all that apply)							
Appeal Mining and Reciamation Plan Tentative Subdivision Map  Development Review Pre-Application Use Permit  Final Map Residential Density Bonus Variance  General Plan Amendment/Rezone Tentative Map Extension Zoning Clearance  Landmark Designation Tentative Map Extension Zoning Clearance  ADMINISTRATIVE PERMITS (Please check all that apply)  Adult Oriented Busines Dutdoor Storage Second Dwelling Unit Tree Removal  Large Family Day Care Second Dwelling Unit Sign/Temporary Sign Permit Sign/Temporary Sign Permit Sign/Temporary Sign Permit Sign/Temporary Sign Permit Sign Second Dwelling Unit Sign Permit Sign Second Dwelling Unit Sign Second Dwelling Unit Sign Second Dwelling Unit Sign Permit Sign Second Dwelling Unit Sign Permit Sign Permit Sign Second Dwelling Unit Sign Permit Sign Permit Sign Permit Sign Second Dwelling Unit Sign Permit Sign Permit Sign Second Dwelling Unit Sign Permit Sign Per	Ann														
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General Plan Amendment/Rezone  Landmark Designation  Cher: (Please Specify)  Application to add additional building footage and drive up windows @ pharmace  ADMINISTRATIVE PERMITS (Please check all that apply)  Adult Oriented Business  Outdoor Storage  Large Family Day Care  Large Family Day Care  Second Dwelling Unit  Tree Removal  Mobile Food Vendor  Other: (Please Specify)  Pharamcy with drive up windows and addition of 4,365 square feet  Please provide a letter addressed to the Planning Division with a detailed description for the proposed project. Please include any site plans, maps, aerials, photos, and other relevant information that will help us in processing your application.  Any time a set of plans is required, three (3) sets of drawings shall be submitted, unless otherwise directed.  PROJECT INFORMATION  Project Name: Feather River Tribal Health  Proposed Structure(s) (Sq Ft.): 1,635  Address: 2145 5th Avenue  Existing Structure(s) (Sq Ft.): 47,490  Nearest Cross Street: Mitchell Avenue  Sessesor Parcel Number: 035-250-080  School District: Oroville School Dist  APPLICANT'S SIGNATURE  I hereby certify that the information provided in this application is, to my knowledge, true and correct.  Signature:  Mark Humburk  OFFICE USE ONLY  Zoning:  Zoning:  Zoning Conformity:  APN:	Deve	elopment Review				Pre-Application				-					
Landmark Designation    Tentative Map Extension   Zoning Clearance	Fina	Мар				Residential Der	sity Bonus			Var	iance				
Landmark Designation	Gen	eral Plan Amendme	ent/R	lezone		Temporary Use		Wireless Communication Facilit							 cilities
ADMINISTRATIVE PERMITS (Please check all that apply)  Adult Oriented Business  Outdoor Storage  Home Occupation  Large Family Day Care  Large Family Day Care  Second Dwelling Unit  Other: (Please Specify)  Other: (Please Specify)  Pharamcy with drive up windows and addition of 4,365 square feet  Please provide a letter addressed to the Planning Division with a detailed description for the proposed project. Please include any site plans, maps, aerials, photos, and other relevant information that will help us in processing your application.  *Any time a set of plans is required, three (3) sets of drawings shall be submitted, unless otherwise directed.  PROJECT INFORMATION  Project Name: Feather River Tribal Health  Proposed Structure(s) (Sq Ft.): 1,635  Address: 2145 5th Avenue  Nearest Cross Street: Mitchell Avenue  Water Provider: Cal Water  Assessor Parcel Number: 035-250-080  School District: Oroville School Dist  Number of Dwelling Units:  APPLICANT'S SIGNATURE  I hereby certify that the information provided in this application is, to my knowledge, true and correct.  Signature:  Date: 12-30-202:  OFFICE USE ONLY  Zoning Conformity:  APN:	Land	lmark Designation		Tentative Map E	Extension	tension Zoning Clearance									
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Adult Oriented Business  Outdoor Storage  Special Event  Street Closure  Street Closure  Second Dwelling Unit  Tree Removal  Mobile Food Vendor  Other: (Please Specify)  Pharamcy with drive up windows and addition of 4,365 square feet  Please provide a letter addressed to the Planning Division with a detailed description for the proposed project. Please include any site plans, maps, aerials, photos, and other relevant information that will help us in processing your application.  Any time a set of plans is required, three (3) sets of drawings shall be submitted, unless otherwise directed.  PROJECT INFORMATION  Project Name: Feather River Tribal Health  Proposed Structure(s) (Sq Ft.): 1,635  Address: 2145 5th Avenue  Existing Structure(s) (Sq Ft.): 47,490  Nearest Cross Street: Mitchell Avenue  Nearest Cross Street: Mitchell Avenue  Nearest Cross Street: Mitchell Avenue  Number: 035-250-080  School District: Oroville School Dist  Number of Dwelling Units:  APPLICANT'S SIGNATURE  I hereby certify that the information provided in this application is, to my knowledge, true and correct.  Signature:  Mack Hachach  OFFICE USE ONLY  Seneral Plan:  Zoning:  Zoning Conformity:  APN:				ADMINIS	TR/	TIVE PERMITS	(Please check	all th	nat a	oply)				pridi	maoy.
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OFFICE USE ONLY  General Plan: Zoning: Zoning Conformity: APN:	Signature:					provided in time	application is, to	IIIy KI	lowie	uge,	true and		T		0000
General Plan: Zoning: Zoning Conformity: APN:				11 - 2011 - 3		OFFICE US	SE ONLY			J J	5 Et 17	Date	12	:-3U <b>-</b>	2022
	Seneral Pla	in:		Zoni	ng:			ty:			APN:	F	J.	3.8	11/5
File# Overlay Zoning: Minimum Setbacks: FY RY SY	Fi	le#		Overlay Zo	ning	T I		-	FY				T	SY	

	AGENT AUT	HORIZATION								
To the City of Oroville,	Department of Community Development									
NAME OF AGENT:	Art Thomas	PHONE NUMBER:	530-762-9115							
COMPANY NAME: Feather River Tribal Health EMAIL: art.thomas@frth.org										
ADDRESS: 2145 5th Avenue CITY/ST/ZIP: Oroville, Ca. 95965										
AGENT SIGNATURE	<b>≒</b>									
Is hereby authorized t	o process this application on my/our prop	erty, identified as Butte	County Assessor Parcel Number (s):							
	035-25									
inis authorization allo said processing, but n	ws representation for all applications, hea ot including document (s) relating to recor	irings, appeals, etc. and d title interest.	to sign all documents necessary for							

#### Owner(s) of Record (sign and print name)

1) Art Thomas	Lo France	12/20/22
Print Name of Owner	Signature of Owner	Date
2) Print Name of Owner	Signature of Owner	Date
Print Name of Owner  4)	Signature of Owner	Date
Print Name of Owner	Signature of Owner	Date
2145 5th Ave Oroville, CA.	art.thomas@frth.org	530-762-9115
Owner's Mailing Address	Owner's Email	Owner's Phone #

The Community Development Department operates on a full cost recovery for processing of permits. Staff will charge their time and any expenses associated with processing the application against the initial deposit. Fees that have been captured for the reimbursement of City expenses are non-

Technology cost recovery fees are non-refundable



#### **City of Oroville**

Building Division - Community Development Department

1735 Montgomery Street Oroville, CA 95965-4897 (530) 538-2401 – FAX (530) 538-2426 www.citvoforoville.org



#### **BUILDING PERMIT APPLICATION**

Please keep in mind, if you are planning an improvement, you need to check with your local homeowner's association, and architectural review committee for Conditions, Covenants, & Restrictions (CC&R's). The City of Oroville has no regulatory authority to neither enforce or notify applicants of CC&R requirements nor deny permits for non-compliance. *Permit applications expire 180 days after* 

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	J	OB SI	TE INFOR	MATI	ON	& L	OCATION	CONTR	RACT	OR AN	D/OR A	OHTU	RIZED	AGEN'	T INFO
APN	I.	035-2	250-080					Name:	Hilb	ers Inc.					
Add	ress:	2145	5th Avenue	, Orov	ille, (	CA.	95965	Address:	770	North V	Valton A	ve.			
	N-11 S	AUJ. M	TYPE	OF W	VOR	K		City/State/	ZIP:	Yuba (	City, CA	. 95993			
V	Additi	ion/Alt	eration				Deck/Patio	Phone:	(530	701-2	792	Fax:	(530) 6	74-9578	
<b>V</b>	Electr	ical/Plu	ımbing /Me	chanic	al*	<b>√</b>	Demolition	Email mhadrick@hilbersinc.com							
	New S	Single-l	Family				Garage	LICENSED CONTRACTOR'S DECLARATION							
<b>V</b>	New Commercial/Commercial TI Remodel							I hereby affirm <i>under penalty of perjury</i> that I am licensed under provisions of Chapter 9 (commencing with Section 7000) of Division 3 of the Business and Professions Code, and my license							
	Swimr	ning P	ool			Re-roof*	is in full fo	orce ar	nd effect	t.	roressio	ns Code	, and my	license	
	Sign			]		Solar	LICENSE	NUM	BER:	5479	70				
	Other: Storage building - Ground up construction							CLASS:	A	EXPIRATION DATE: 11-30-2024					2024
Com	plete I	Descrip	tion of Wo	rk:						OF	FICE U	JSE ON	LY	X P TY	g a phy z
Addit	ion to	existin	g building.	To be i	used	ลร ล	pharmacy with			PERM	IT SUB	MITTA	L FEES		Resistan,
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public								Fire Plan Review Fee 708.						08.	76
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			TYPE OF	T - T				GOOTCAL CHAPTIT PISAUTOCITIC 120.							60
=		ory Bu					cial/Industrial	Sign Permit: Building Plan Review Fee							
		/Multi					amily Dwelling	I				view Fe	e		
	Other:					exi	sting building.	Check#	66	685		Tota	1 \$		
-			N VALUA	Riner - the	<u>:                                    </u>		\$ 825,000.00	Cash		CC		2/30			
			trial sq. ft.:	70	11	T// (	addition		11.2	PERM	IT ISSU	JANCE	FEES		
	le sq.							Building/El	lectric	al/Plum	bing/Me	chanica	l		
	ge sq. i											Fire Fee	s		
Deck/	eck/Patio sq. ft.: 844										C	reen Fe	2		
l'en,	PROPERTY OWNER								Г	evelopi	nent Im	act Fee	5		
Name							h			St	trong Mo	otion Fee			
	ddress: 2145 5TH Avenue							Tech. Cost Recovery Issuance Fee							
	ity/State/ZIP: Oroville Ca. 95965							Check#	-			Total	<b>S</b>		
Phone								Cash		CC					
Email	:							*Addition	al na	namuai	ek to be	a a man I a	t a d	nu to inn	

#### **OWNER-BUILDER DECLARATION**

permit to cons statement that Division 3 of	k(s) I have placed next to struct, alter, improve, demo- he or she is licensed purs the Business and Professi	that I am exempt from the Contractors' State License Law the applicable item(s) (Section 7031.5, Business and Profe- olish, or repair any structure, prior to its issuance, shall also re- mant to the provisions of the Contractors' State License Law ons Code) or that he or she is exempt from licensure and the apermit subjects the applicant to a civil penalty of not more to	ssions Code: Any city or county that requires a quire the applicant for the permit to file a signed (Chapter 9 (commencing with Section 7000) of that for the alleged exemption. Any violation
does not apply are not intende	and the structure is not int to an owner of property ved or offered for sale. If, h	inployees with wages as their sole compensation, WILL DO tended or offered for sale (Section 7044, Business and Profession, through employees' or personal effort, builds or improvowever, the building or improvement is sold within one year improved for the purpose of sale)	sions Code: The Contractors' State License Law
Code: The Cor	ntractors' State License La	sively contracting with licensed contractors to construct the paw does not apply to an owner of property who builds or imprese Contractors' State License Law.)	project (Section 7044, Business and Professions oves thereon, and who contracts for the projects
I am exemp	ot from licensure under Co	ontractors' State License Law for the following Reason:	
	W	ORKERS' COMPENSATION DECLARA	ATION
up to one hund	Failure to secure workers dred thousand dollars (\$1 and attorney's fee.	s' compensation coverage is unlawful and shall subject an e [00,000], in addition to the cost of compensation, damages	mployer to criminal penalties and civil fines as provided for in Section 3706 of the Labor
Check ONE B	OX only: I hereby affirm	under penalty of perjury one of the following declarations:	
I have and v	will maintain a certificate of 3700 of the Labor Code, f	of consent to self-insure for workers' compensation, issued befor performance of the work for which this permit is issued.	y Director of Industrial Relations, as provided POLICY #:
✓ I have and which this perm	will maintain workers' cor nit is issued.	mpensation insurance, as required by Section 3700 of the Lab	or Code, for the performance of the work for
CARRIER: N	Newfront 777 Mariners	Island Blvd, Suite 250 San Mateao, CA. 94404	
	Newfront 777 Mariners 4326390	Island Blvd, Suite 250 San Mateao, CA. 94404  EXPIRATION DATE:	12/31/2022
I certify that to the workers'	t in the performance of the compensation laws of Ca		person in any manner so as to become subject
POLICY#: 5  I certify that to the workers' of the Labor Co	t in the performance of the compensation laws of Ca	EXPIRATION DATE:  e work for which this permit is issued, I shall not employ any alifornia and agree that if I should become subject to the work	person in any manner so as to become subject
I certify that to the workers' of the Labor Cocorrect.	t in the performance of the compensation laws of Ca	EXPIRATION DATE:  e work for which this permit is issued, I shall not employ any alifornia and agree that if I should become subject to the world ply with those provisions. My signature certifies the above VAPPLICANT'S DECLARATION	person in any manner so as to become subject
I certify that to the workers' of the Labor Cocorrect.  By my signature I am;	t in the performance of the compensation laws of Caode, I shall forthwith computer below, I certify to e	EXPIRATION DATE:  e work for which this permit is issued, I shall not employ any alifornia and agree that if I should become subject to the world ply with those provisions. My signature certifies the above VAPPLICANT'S DECLARATION	person in any manner so as to become subject
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### City of Oroville

#### **COMMUNITY DEVELOPMENT DEPARTMENT**

1735 Montgomery Street Oroville, CA 95965-4897 (530) 538-2430 FAX (530) 538-2426 www.cityoforoville.org

#### NOTICE OF EXEMPTION

TO Butte County Clerk FROM City of Oroville

155 Nelson Avenue 1735 Montgomery Street Oroville, CA 95965 Oroville, CA 95965

<u>Project Title</u>: Minor Use Permit UP23-02 for an addition and new drive-through to be used as a member's only pharmacy.

Project Location - Specific: APN (035-250-080)

Project Location - City: City of Oroville

Project Location - County: Butte

<u>Description of Nature, Purpose, and beneficiaries of project:</u> The project applicant, Mark Hadrick, has applied for a Use Permit for the operation of a drive through at 2145 South 5<sup>th</sup> Avenue (APN: 035-250-080). The subject property has a zoning designation of Public Quasi-Public (PQ) and General Plan Land Use Designation of Public Facilities and Services (PUB).

Name of Public Agency Approving Project: City of Oroville

Name of Person or Agency Carrying Out Project: Mark Hadrick, Feather River Tribal Health

#### Exempt Status (Check One):

	Ministerial (	(Sec.	21080	(b)	(1):	15268)
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- Declared Emergency (Sec. 21080(b)(3); 15269(a))
- Emergency Project (Sec. 21080(b)(4); 15269(b)(c))
- ☐ Categorical Exemption: State type & section number:
  - General Rule Exemption; Title 14, CCR, §15061(b)(3)
  - In-Fill Development Projects, Title 14, CCR, §15332

Statutory Exemption: State code number:

Reasons why project is exempt: This action has been determined to be exempt from the California Environmental Quality Act (CEQA) review as follows:

#### General Rule Exemption: Title 14. CCR. §15061(b)(3)

This project involves the use of a property zoned Intensive Commercial (C-2). The intent of the C-2 zoning designation is to provide for more intensive commercial establishments, including those that deal in large, low-volume items and major repair services, or that require large outdoor display and storage areas. As the building is existing, no significant new construction is proposed, minor interior and exterior alterations will occur, all business activities will be contained within the building, and the proposed use

Item 3.

will be subject to comply with all applicable City, County, State, Federal, and other local agencies as applicable, it has been determined that there is no possibility that the use permit request will have a significant effect on the environment. Thus, this action is exempt from CEQA.

#### In-Fill Development Projects, Title 14, CCR, §15332

Class 32 categorical exemptions consists of projects characterized as in-fill development meeting specific conditions a-e as described in this section. This project meets all conditions, including being consistent with the General Plan and Zoning Designation, occurs within City limits, has no value as habitat, will not result in any significant effects, and can be adequately served by all required utilities. The project is a permitted use in a PQ zone, subject to a use permit for the drive-through.

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<ol> <li>Attach certified document of exemption finding.</li> <li>Has a notice of exemption been filed by the pub</li> </ol>	olic agency approving the project? ☐ Yes ☐ No
Lead Agency Contact Person: Daniel Kopshever	<u>Telephone</u> : (530) 538-2517
Signature:	Date:
<ul><li>Signed by Lead Agency</li><li>Signed by Applicant</li></ul>	

1735 Montgomery Street Oroville, CA 95965-4897 (530) 538-2402 FAX (530) 538-2426 www.cityoforoville.org

### ZONING INTERPRETATION NO. 23-02 Pertaining to a proposed use in a PQ Zone that is not listed in Table 17.40.010-1

The Zoning Administrator has determined under OMC 17.08.090 that the proposed use of APN 035-380-060 is appropriate, substantially similar to, and less intensive than several uses approved in the Public Quasi-Public (PQ) Zone, such as a hospital. Thus, the proposed use as a members only drive-through pharmacy for Feather River Tribal Health is allowed, but like these other uses requires a use permit to be decided by the Planning Commission.

#### **BACKGROUND**

Feather River Tribal Health has applied to expand their existing facility located at 2145 South 5<sup>th</sup> Avenue. APN 035-250-080 is an 8.39-acre parcel fronting South 5<sup>th</sup> Avenue.

"Drive-through pharmacy" is not listed as an allowed use in the PQ Zoning Table 17.40.010-1. However, several similar and more intense uses are listed as requiring a use permit, including hospital, airport, vehicle depot and public safety facility.

This private, members only pharmacy drive-through is smaller and is less intensive than the above-named uses. Nevertheless, a Use Permit is required, the same as for those other uses.

This project will be occupied by a nonprofit agency sanctioned by and supported by Butte County and other local jurisdictions, and its expansion will benefit many citizens.

#### **REQUIRED FINDINGS**

The above background allows the Zoning Administrator to make all Findings a-d, based on substantial evidence:

- a. The characteristics of, and activities associated with, the proposed use are equivalent to those of one or more of the allowable uses for the zoning district.
- b. The proposed use will not involve a higher level of activity, density or intensity than other allowable uses for the district.

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Item	3.

- c. The proposed use will meet the purpose and intent of the applicable zoning district.
- d. The proposed use will be consistent with the goals, objectives and policies of the general plan.

Approved		
Zoning Administrator		
Date:		



# City of Oroville

# COMMUNITY DEVELOPMENT DEPARTMENT

1735 Montgomery Street Oroville, CA 95965-4897 (530) 538-2430 FAX (530) 538-2426 www.cityoforoville.org

# PLANNING COMMISSION STAFF REPORT

Thursday, February 23, 2023

RE: Minor Use Permit UP23-01 for the construction of a new 7,800 square foot metal building used for office space and warehouse at 2640 South 5<sup>th</sup> Avenue (APN 035-380-060)

**SUMMARY:** The Oroville Planning Commission will review and consider approving Use Permit No. UP23-01 for the construction of a new 7,800 square foot metal building used for office space and warehouse storage serving and adjacent to the North Valley Food Bank at 2640 South 5<sup>th</sup> Avenue. Project# PL2301-003

# **RECOMMENDATION: Staff recommends the following actions:**

- Conduct a Public Hearing on the proposed project;
- 2. Adopt the Notice of Exemption as the appropriate level of environmental review in accordance with the California Environmental Quality Act (CEQA);
- 3. Adopt the recommended Findings for Use Permit No. UP23-01;
- 4. Approve Use Permit UP23-01 and recommended Conditions of Approval;
- 5. Adopt Resolution No. P2023-01

APPLICANT:	Brody Billson, for the Butte Community Action Agency				
LOCATION: 26 (APN 035-380-0	40 South 5 <sup>th</sup> Ave Blvd 60)	GENERAL PLAN: RBS (Retail and Business Service) ZONING: C-2 (Intensive Commercial) FLOOD ZONE: Zone X			
<b>ENVIRONMENTAL DETERMINATION:</b> Categorically Exempt per Section 15332 of Title 14, California Code of Regulations, In-Fill Development Projects.					
REPORT PREP	ARED BY:	REVIEWED BY:			
•	er, Assistant Planner elopment Department	Dawn Nevers, Assistant Director Community Development Department			

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# DISCUSSION

The Community Action Agency of Butte County is proposing a new 7,800 square-foot building, with 1,950 square feet of office space and 5,850 square feet of warehouse area. The project site is located on approximately 1.69 acres of undeveloped land on the west side of 5<sup>th</sup> Avenue and less than half a mile south of Oroville Dam Boulevard (Adjacent to 2640 South 5<sup>th</sup> Avenue APN: 035-380-060). The project is to expand the North Valley Food Bank's operations. Proposed site improvements include a trash enclosure, a loading dock with forklift ramp, compact and accessible parking, and a parking and loading area for delivery vans and box trucks. Site will be fenced and gated with manual entry gates and automatic exit gates. The intended hours of operation are Monday through Friday 7:30am to 5:30pm. The property has a zoning designation of Intensive Commercial (C-2). While warehousing as a primary use is not allowed in the C-2 zoning district, the adjacent property also owned and operated by the Community Action Agency of Butte County is zoned Intensive Industrial (M-2). The Zoning Administrator has provided the attached zoning interpretation under **OMC 17.080.090**, and has determined that proposed use is allowable with a Use Permit.

# Required Findings for Use Permits (OMC 17.48.010)

Before approving a use permit, the Planning Commission must consider each of the following issues and make appropriate findings (Staff's comments are in *italics*, draft findings are in the Resolution):

1. The granting of the permit will not be incompatible with or detrimental to the general health, safety or public welfare of the surrounding area or of the city as a whole.

The project will be located in an area surrounded by active commercial development. The project has been reviewed and conditioned to minimize or prevent any potential impacts to the general health, safety, or public welfare of the surrounding area and the city as a whole.

2. The proposed use follows sound principles of land use by having a suitable location relative to the community as a whole, as well as to transportation facilities, public services and other land uses in the vicinity.

The proposed use will provide a needed service to the community and is located in an area with significant employment and transportation access.

3. Public utilities and facilities, including streets and highways, water and sanitation, are adequate to serve the proposed use or will be made adequate prior to the establishment of the proposed use.

All infrastructure is in and available. Any utilities not already provided on site will be installed by the property owner, subject to all applicable fees and permits.

4. The location, size, design and operating characteristics of the proposed use will be harmonious and compatible with the surrounding neighborhood and will not adversely affect abutting properties.

As required by OMC Chapter 17.52, the project underwent development review and the applicant made revisions based on the committee's comments. The North Valley Food Bank is located near other like uses, and this project constitutes an expansion in their existing use. The site plan, design, lighting, landscaping, and other improvements have been reviewed and the project conditioned to minimize any adverse impacts on abutting properties. Code enforcement will monitor for compliance on an ongoing basis.

5. The subject site is physically suitable for the type and intensity of land use being proposed.

Applicant has submitted a set of drawings demonstrating that the site is physically suitable for the proposed type and intensity of use. The site will provide adequate capacity for the use.

6. The size, intensity and location of the proposed use will provide services that are necessary or desirable for the neighborhood and community as a whole.

The North Valley Food Bank provides a valuable service for the community as a whole.

7. The permit complies with all applicable laws and regulations, including the requirements of the general plan, of this title and of the city municipal code.

The use is permitted, subject to a use permit, and is compatible with the General Plan, Zoning codes, and the Oroville Municipal Code.

# **FISCAL IMPACT**

None. The project is subject to all customary fees.

### PUBLIC NOTICE

A request for comments was prepared and circulated to the local agencies and surrounding property owners within 300 feet of the property. Additionally, the meeting date, time, and project description were published in the Oroville Mercury Register and posted at City Hall.

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#### **ATTACHMENTS**

- 1. Resolution P2023-01
- 2. Notice of Exemption (CEQA)
- 3. Application Package
- 4. Zoning Administrator's Zoning Interpretation

### **RESOLUTION NO. P2023-01**

A RESOLUTION OF THE OROVILLE CITY PLANNING COMMISSION MAKING FINDINGS AND CONDITIONALLY APPROVING UP#23-01 FOR THE CONSTRUCTION OF A NEW 7,800 SQUARE FOOT METAL BUILDING USED FOR OFFICE SPACE AND WAREHOUSING AT 2640 SOUTH 5TH AVE

**WHEREAS**, the City has received a Use Permit application for a new 7,800 square foot metal building used for office and warehousing at 2640 South 5<sup>th</sup> Ave; and

WHEREAS, the property is zoned Intensive Commercial (C-2); and

**WHEREAS**, pursuant to Section (OMC) Table 17.32.010-1, an office is a use that is permitted by right, subject to a zoning clearance, in (C-2) districts. However, warehousing is not a permitted use. The zoning administrator has made a determination that the use may be permitted subject to a use permit. As a condition of approval, the applicant will be required to comply with all requirements of the City's Zoning Code as found in the OMC Chapter 17, including, but not limited to, development standards, permit requirements and development review; and

**WHEREAS**, at a duly noticed public hearing, the Planning Commission considered the comments and concerns of public agencies, property owners, and members of the public who are potentially affected by the approval of the use permit described herein, and also considered the City's staff report regarding the change.

# NOW, THEREFORE, BE IT RESOLVED BY THE PLANNING COMMISSION as follows:

- This action has been determined to be exempt from the California Environmental Quality Act (CEQA) review pursuant to Title 14, California Code of Regulations, Section 15332 "In-Fill Development Projects."
- 2. The Planning Commission approves the findings required by Section 17.16.160 of the Oroville City Code, as described in the Staff Report;
- 3. The Planning Commission approves the permit conditions described in this Resolution.

# **REQUIRED FINDINGS FOR USE PERMITS (OMC 17.48.010)**

a) The granting of the permit will not be incompatible with or detrimental to the general health, safety or public welfare of the surrounding area or of the city as a whole.

The project will be in a location surrounded by active commercial and industrial development;

- b) The proposed use follows sound principles of land use by having a suitable location relative to the community as a whole, as well as to transportation facilities, public services and other land uses in the vicinity.
  - The proposed use will provide a desired community service, and is located in an area with significant transportation access;
- c) Public utilities and facilities, including streets and highways, water and sanitation, are adequate to serve the proposed use or will be made adequate prior to the establishment of the proposed use.
  - All infrastructure is in and available, especially if applicant meets all proposed conditions, and any future conditions imposed by the City or Caltrans,
- d) The location, size, design and operating characteristics of the proposed use will be harmonious and compatible with the surrounding neighborhood and will not adversely affect abutting properties.
  - All abutting properties are either commercial or industrial. The proposed use is compatible with the surrounding neighborhood;
- e) The subject site is physically suitable for the type and intensity of land use being proposed.
  - Applicant has submitted a set of drawings demonstrating that the site is physically suitable for the proposed type and intensity of use. The site will provide adequate capacity for the use;
- f) The size, intensity and location of the proposed use will provide services that are necessary or desirable for the neighborhood and community as a whole.
  - The commercial pad has been vacant for years, and the proposed use is desirable for the entire community;
- g) The permit complies with all applicable laws and regulations, including the requirements of the general plan, of this title and of the city municipal code.
  - The use has been determined to be permitted by the Zoning Administrator, subject to a use permit, and is otherwise compatible with the General Plan, Zoning codes, and the Oroville Municipal Code.

# **CONDITIONS OF APPROVAL**

**Approved project:** The Planning Commission hereby conditionally approves Use Permit No. 23-01, permitting the proposed building on 2640 South 5<sup>th</sup> Avenue (APN 035-380-060). The subject property has a zoning designation of Intensive Commercial (C-2) and a General Plan Land Use Designation of Retail Business Services (RBS).

# **General Conditions**

- 1. The applicant shall hold harmless the City, its Council members, Planning Commissioners, officers, agents, employees, and representatives from liability for any award, damages, costs, and/or fees incurred by the City and/or awarded to any plaintiff in an action challenging the validity of this permit or any environmental or other documentation related to approval of this permit. Applicant further agrees to provide a defense for the City in any such action.
- 2. The project shall remain in substantial conformance with the Conditions of Approval, as adopted by the Oroville Planning Commission. Any subsequent minor changes in the project (as determined by the Zoning Administrator) may only occur subject to appropriate City review and approval. Any subsequent substantive changes in the project (as determined by the Zoning Administrator) may only occur subject to discretionary review by the Oroville Planning Commission.
- 3. The applicant shall annually pay for and obtain a City of Oroville business license.
- 4. All private facilities, improvements, infrastructure, systems, equipment, common areas, etc. shall be operated and maintained by the applicant in such a manner, and with such frequency, to ensure the public health, safety and general welfare.
- All costs of operation and maintenance of private facilities, improvements, infrastructure, systems, equipment, common areas, etc. shall be the responsibility of the applicant.
- 6. Pursuant to Section 17.12.010, the proposed use of the site shall conform to the performance standards of the Oroville Municipal Code to minimize any potential negative effects that the building, structure, lighting or use could have on its surroundings, and to promote compatibility with surrounding uses and areas.
- 7. Applicable construction plans, calculations, specifications, applications, forms, etc. shall be submitted to the Building Division for review prior to the start of any construction activities requiring a building permit. All applicable plan review and development impact fees shall be paid at time of submittal.
- 8. The applicant shall ascertain and comply with the requirements of all of City, County, State, Federal, and other local agencies as applicable to the proposed project.
- The project shall comply with the City's noise ordinance as found in the OMC Chapter 9.20.
- 10. Each use permit shall be issued subject to the condition that the zoning administrator may inspect the premises for which the use permit is issued at any reasonable time to ensure compliance with the conditions of the use permit. Refusal to permit the zoning administrator to inspect the premises shall be rebuttably presumed to be grounds for revocation of the use permit.
- 11. Pursuant to Section 17.48.010(F) of the City Code, the Planning Commission, upon its own motion, may modify or revoke any use permit that has been granted pursuant

to the provisions of this section upon finding any of the following, based on substantial evidence:

- Any of the conditions of the permit have not been satisfied within 1 year after it was granted.
- II. Any of the terms or conditions of the permit have been violated.
- III. A law, including any requirement in the Municipal Code Chapter 17, has been violated in connection with the permit.
- IV. The permit was obtained by fraud.
- 12. Applicant hereby certifies that any and all statements and information provided as part of the application are true and correct to the best of their knowledge and belief. Any misinformation provided, whether intentional or unintentional, that was considered in the issuance of this permit may be grounds for revocation.
- 13. Any roof mounted or ground placed utilities (HVAC, generators, etc.) shall include an architecturally compatible method of screening. This can include screening by landscaping or a decorative fence for ground placed utilities.
- 14. Building shall be addressed per City requirements. Building numbers shall comply with City Code 17.20.050(A).
- 15. The applicant shall submit to the City details of exterior lighting for review and approval.
- 16. The applicant or property owner shall apply for the proper permits as required by OMC Chapter 17.20 prior to any new signage being erected.
- 17. No more than 25% of any window area shall be covered with signs. This includes both permanent and temporary signs used to identify the business, products sold, or services offered.
- 18. The exterior of the building, including windows and doors, shall be maintained, and with such frequency, to ensure the public health, safety and general welfare of the city.
- 19. Windows and doors shall not be boarded up or blocked unless the appropriate approvals are received to ensure the public health, safety and general welfare. This does not include the use of plywood or other material used to cover a window for a temporary period of time that constitutes a safety hazard and/or invites trespassers and malicious mischief.
- 20. Minor changes may be approved administratively by the Community Development Director or designee upon receipt of a written request by the applicant or designee. Changes deemed to be major or significant in nature shall require a formal application for amendment.
- 21. Applicant and/or property owner will take appropriate measures to provide property maintenance of the building exterior, including provisions to keep the premise free of litter and debris.

- 22. Applicant and/or property owner shall ensure adequate lighting of exterior areas, including parking lots, to discourage loitering outside of the buildings.
- 23. Applicant and/or property owner will ensure protection of adjacent properties from noise, odors and undue light and glare, as well as illegal activity.
- 24. Applicant and/or property owner will maintain adequate onsite security, both inside and outside the building, to satisfy any concerns raised by the chief of police or general public. Substantial camera surveillance and written security protocols approved by the chief of police will suffice.

# **Specific Project Permit Conditions**

- 1. Applicant shall post signage prohibiting truck access other than delivery traffic.
- 2. Any driveway and/or sidewalk improvements in the Public Right of Way are subject to an encroachment permit, design requirements, and or other conditions the City Engineer may require.
- 3. A refuse collection enclosure shall be provided in accordance with City Code 17.12.110. The refuse area shall be large enough to provide adequate storage for solid waste and recyclable materials generated by the use.
- 4. Applicant has submitted a preliminary landscape plan. A Landscape Maintenance Agreement shall be executed to ensure proper maintenance of the property. The agreement shall be in a form approved by the City Attorney and Zoning Administrator and suitable for recordation with the Butte County recorder. The agreement shall be binding upon the property owner and any successors in interest.
- 5. Signage is not included in this Use Permit. Signage will require a new building permit submittal.
- 6. The quantity, locations and striping of all primary and shared parking shall be shown in the building plans upon permit submittal.

\*\*\*End of Conditions\*\*\*

February 2023, by the following vote:	, , , , , , , , , , , , , , , , , , , ,
AYES:	
NOES:	
ABSTAIN:	
ABSENT:	
ATTEST:	APPROVE:
JACKIE GLOVER, ASSISTANT CITY CLERK	CARL DURLING, CHAIRPERSON

I HEREBY CERTIFY that the foregoing resolution was duly introduced and passed at a regular meeting of the Planning Commission of the City of Oroville held on the 26<sup>th</sup> of

Item 4.



City of Oroville
Planning Division - Community Development Department

1735 Montgomery Street Oroville, CA 95965-4897 (530) 538-2430 FAX (530) 538-2426 www.cityoforoville.org TRAKIT#: PLQ301-003

# **USE PERMIT APPLICATION**

	(Please print clearly and fill in/provide all that apply)							
	REQUI	RED FOR A COMPLETE A	PPLIC	CATION		/	PERMIT TY	/PE
	Complete	d and signed Application Fo	ms		V			(6% Tech Fee) = \$3,063.38
	Applicatio	n Fee Paid				Amendment to Existing Use Permit: \$1,024.09 + \$61.45 (6% Tech Fee) = \$1,085.54		
	PROJECT PLANS							
All p	All plans and drawings shall be drawn to scale to the extent feasible and shall indicate the full dimensions, contours and other topographic features and all information necessary to make a full evaluation of the project. Please include the following:							
J	Site and floor plans, including the location, square footage and use of all structures.							
<b>V</b>		tectural drawings showing						
1	3. Lands	scape plans showing the typ	es, siz	zes and location o	of veg	getation to be plante	ed and the irri	gation system to be installed
1	4. Plans	for the configuration & layo	ut of a	III off-street parkin	g sp	aces, including entr	ances, exits a	nd internal circulation routes.
1	5. Plans	for all lighting to be installed	d on th	ne site, including t	he lo	cation, type, height	and brightnes	ss of each lighting fixture.
	6. Draw	ings of all signs that are pr	opose	ed in association v	vith t	he project.		
1	7. Plans	showing the location, sq foo	otage	and capacity of a	ny ex	sisting or proposed	surface storm	-water detention facilities.
1	8. Plans	showing the location and so	quare	footage of any ex	isting	or proposed outdo	or storage are	eas.
1	9. Desc	riptions of any off-site infrast	ructur	e improvements t	o be	provided in conjunc	tion with the	oroject.
$\checkmark$	10. Hours	s of operation for all propose	d land	d uses.				
<b>√</b>	11. Numb	per of employees and fleet v	ehicle	s for all proposed	land	uses		
1	12. A lett	er authorizing the use per	mit a	oplication from t	he o	wner of the proper	ty.	
				CLASSIF	ICA	TION		
	Alcohol &	Beverage Sales		Nonconforming	Uses	& Structures	Uses in	Industrial Districts
	Agricultur	al Uses		Outdoor Storage	<del>)</del>		Uses Mi	ni-Storage Overlay(MS-O)
	Animal Ke	eping (Commercial)		Parking Require	men	t Exceptions	Uses in	Residential Districts
	Barbed/R	azor Wire Fence		Temporary Use			Uses in	Special Purpose Districts
	Density B	onus & Other Incentives		Uses in a Condi			Uses no	t Specified but Allowed
	Exception	s to Height Limits	$\checkmark$	Uses in Comme Districts	rcial	& Mixed-Use	Wireless	Communication Facilities
	Other: (PI	ease Specify)						
		*		APPLICANT'S				
		I hereby certify that the info	rmati	on provided in this	app	lication is, to my kn	owledge, true	and correct.
Sign	nature:	(500	>		0.5	NAM V	Date:	1/19/23
				OFFICE U	SE (	JNLY	Detail	
App	roved By:						Date:	
Payı	ayment: Number:					The state of the s		

PROJECT DESCRIPTION			
Present or Previous Use:	None		
Proposed Use:	Office/Warehouse		

**Detailed Description:** 

The proposed project would include a new 7,800 S.F. metal building with 1,950 S.F. of office space, and 5,850 S.F. of warehouse area. The 1.69 acre site will be developed with new standard and compact vehicle parking, accessible parking, a trash enclosure, and loading dock with a forklift ramp. The building will be used as an office for the North State Food Bank with warehouse storage. The site will have parking for loading vans and box trucks used for food bank delivery. The project is located on undeveloped land owned by the Community Action Agency of Butte County, Inc., behind its current building at 2640 S. 5th Ave. in Oroville, California. The site will be fenced with manual entry gates and automatic exit gates. The typical hours of operation will be Monday - Friday 7:30 am to 5:30 pm. During disaster/emergency response, the hours would likely be extended and operated 7 days a week. There will be 8 employees and 5 fleet vehicles operated at the site.

The Community Development Department operates on a full cost recovery for processing of permits. Staff will charge their time and any expenses associated with processing the application against the initial deposit. Fees that have been captured for the reimbursement of City expenses are non-refundable.



# Community Action Agency of Butte County, Inc.

Helping People. Changing Lives.

January 5, 2023

Subj: Owner's Authorization to Submit Use Permit Application

Dear Gary Hawkins,

This letter is to provide authorization to you to submit a use permit application to the City of Oroville on behalf of the Community Action Agency of Butte County, Inc.'s North State Food Bank expansion project on S. 5<sup>th</sup> Ave. in Oroville. Please note the classification as Manufacturing with office use, which includes our need for connected warehouse space.

Together in Service

Timothy J. Hawkins Chief Executive Officer

Community Action Agency of Butte County, Inc.



City of Oroville
Planning Division - Community Development Department

1735 Montgomery Street Oroville, CA 95965-4897 (530) 538-2420 FAX (530) 538-2426 www.cityoforoville.org

TRAKIT#:


# PLANNING DIVISION GENERAL APPLICATION

	APPLICANT'S INFOR	MATION	Project's:			
	APPLICANT 5 IN 67.	***	Name:	1	. In Adian Among of	
Name: Brody Billson			3	Commi	unity Adion Agency of	
Address: 15 Commerce. Ct. Suite 150		Company:		The state of the s		
(ACOILS)		Address:	264	O. S. 5th Ave Oranilla		
'ho	one: (530) 774 - 3554		Phone:	(531	0 693-2055	
Email: brody @billson Construction. Com If applicant is Not the owner, please provide		F3.	11	wkins abutte Caa.		
th	owner/agent a	authorization on the reverse	Email:	1+ha	chack all that apply)	
-	DEVELOPMENT PRO	JECTS & OTHER	APPLICATION	NS (Please	Tentative Parcel Map	
	Annexation		dification/Demoli	tion	Tentative Subdivision Map	
-	Appeal	Mining and Re	clamation Plan	-		
ᅥ	Development Review	Pre-Application	n <sub>20</sub>	V	Use Permit	
닉		Residential De	ensity Bonus		Variance	
_	Final Map	Temporary Us	e diameter		Wireless Communication Facilities	
-	General Plan Amendment/Rezone	Tentative Map			Zoning Clearance	
	Landmark Designation	Temative	1			
	Other: (Please Specify)	STRATIVE PERMIT	rs (Please che	ck all that	apply)	
		Outdoor Stora			Special Event	
	Adult Oriented Business	Outdoor Displ	10 FE - 1124 Y 4 F - 24 h.		Street Closure	
	Home Occupation		The second of the second of		Tree Removal	
200	Large Family Day Care	Second Dwelling Unit		4-4-		
	Mobile Food Vendor	Sign/Tempora	ary Sign Permit	× *		
				et Cadha	assaced project. Please include any	
-PI	Other: (Please Specify)  lease provide a letter addressed to the Please plans, maps, aerials, photos, and other	anning Division with	a detailed descri that will help us i	n processin	g your application.	
site	e plans, maps, aerials, photos, and other Any time a set of plans is required, three	(3) sets of drawings:	shall be submitte	d, unless of	therwise directed.	
- 1	Any time a set of piece in a	PROJECT				
Pro	oject Name:			Proposed Structure(s) (Sq Ft.):  Existing Structure(s) (Sq Ft.):		
Address:		Water Provider.				
Nearest Cross Street:		School District:				
Assessor Parcel Number:		Number of D		s:		
_0	ot Size (Acres):	APPLICAN	TIC SICNATURE			
_	I hereby certify that the inf	ormation provided in	this application is	, to my kno	wledge, true and correct.	
C.	.017 -				17 1 17 0	
210	gnature:	OFFICE	USEIONLY	14339 N. S. 1974	APN	

	AGENT AUTHORIZATION		
To the City of Oroville, Department of Co	Ommunity Development		
NAME OF AGENT:	, Development		×
COMPANY NAME:	PHONE NUMBE	ER:	189
	EMAIL:		8, 14 874
DDRESS:	CITY/ST/ZIP:	Table 1 and 14	
GENT SIGNATURE:	. GH HSHZIP.		
hereby authorized to process this		=1	
y wasted to process this app	plication on mylour property, identified as B	utte County Asses	Ssor Parcel Number (
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aid processing, but not including de-	n for all applications, hearings, appeals, etc. ment (s) relating to record title interest.	and to cier ii	
31 out not including docur	ment (s) relating to record title interest	and to sign all do	cuments necessary fo
	and meigst.		
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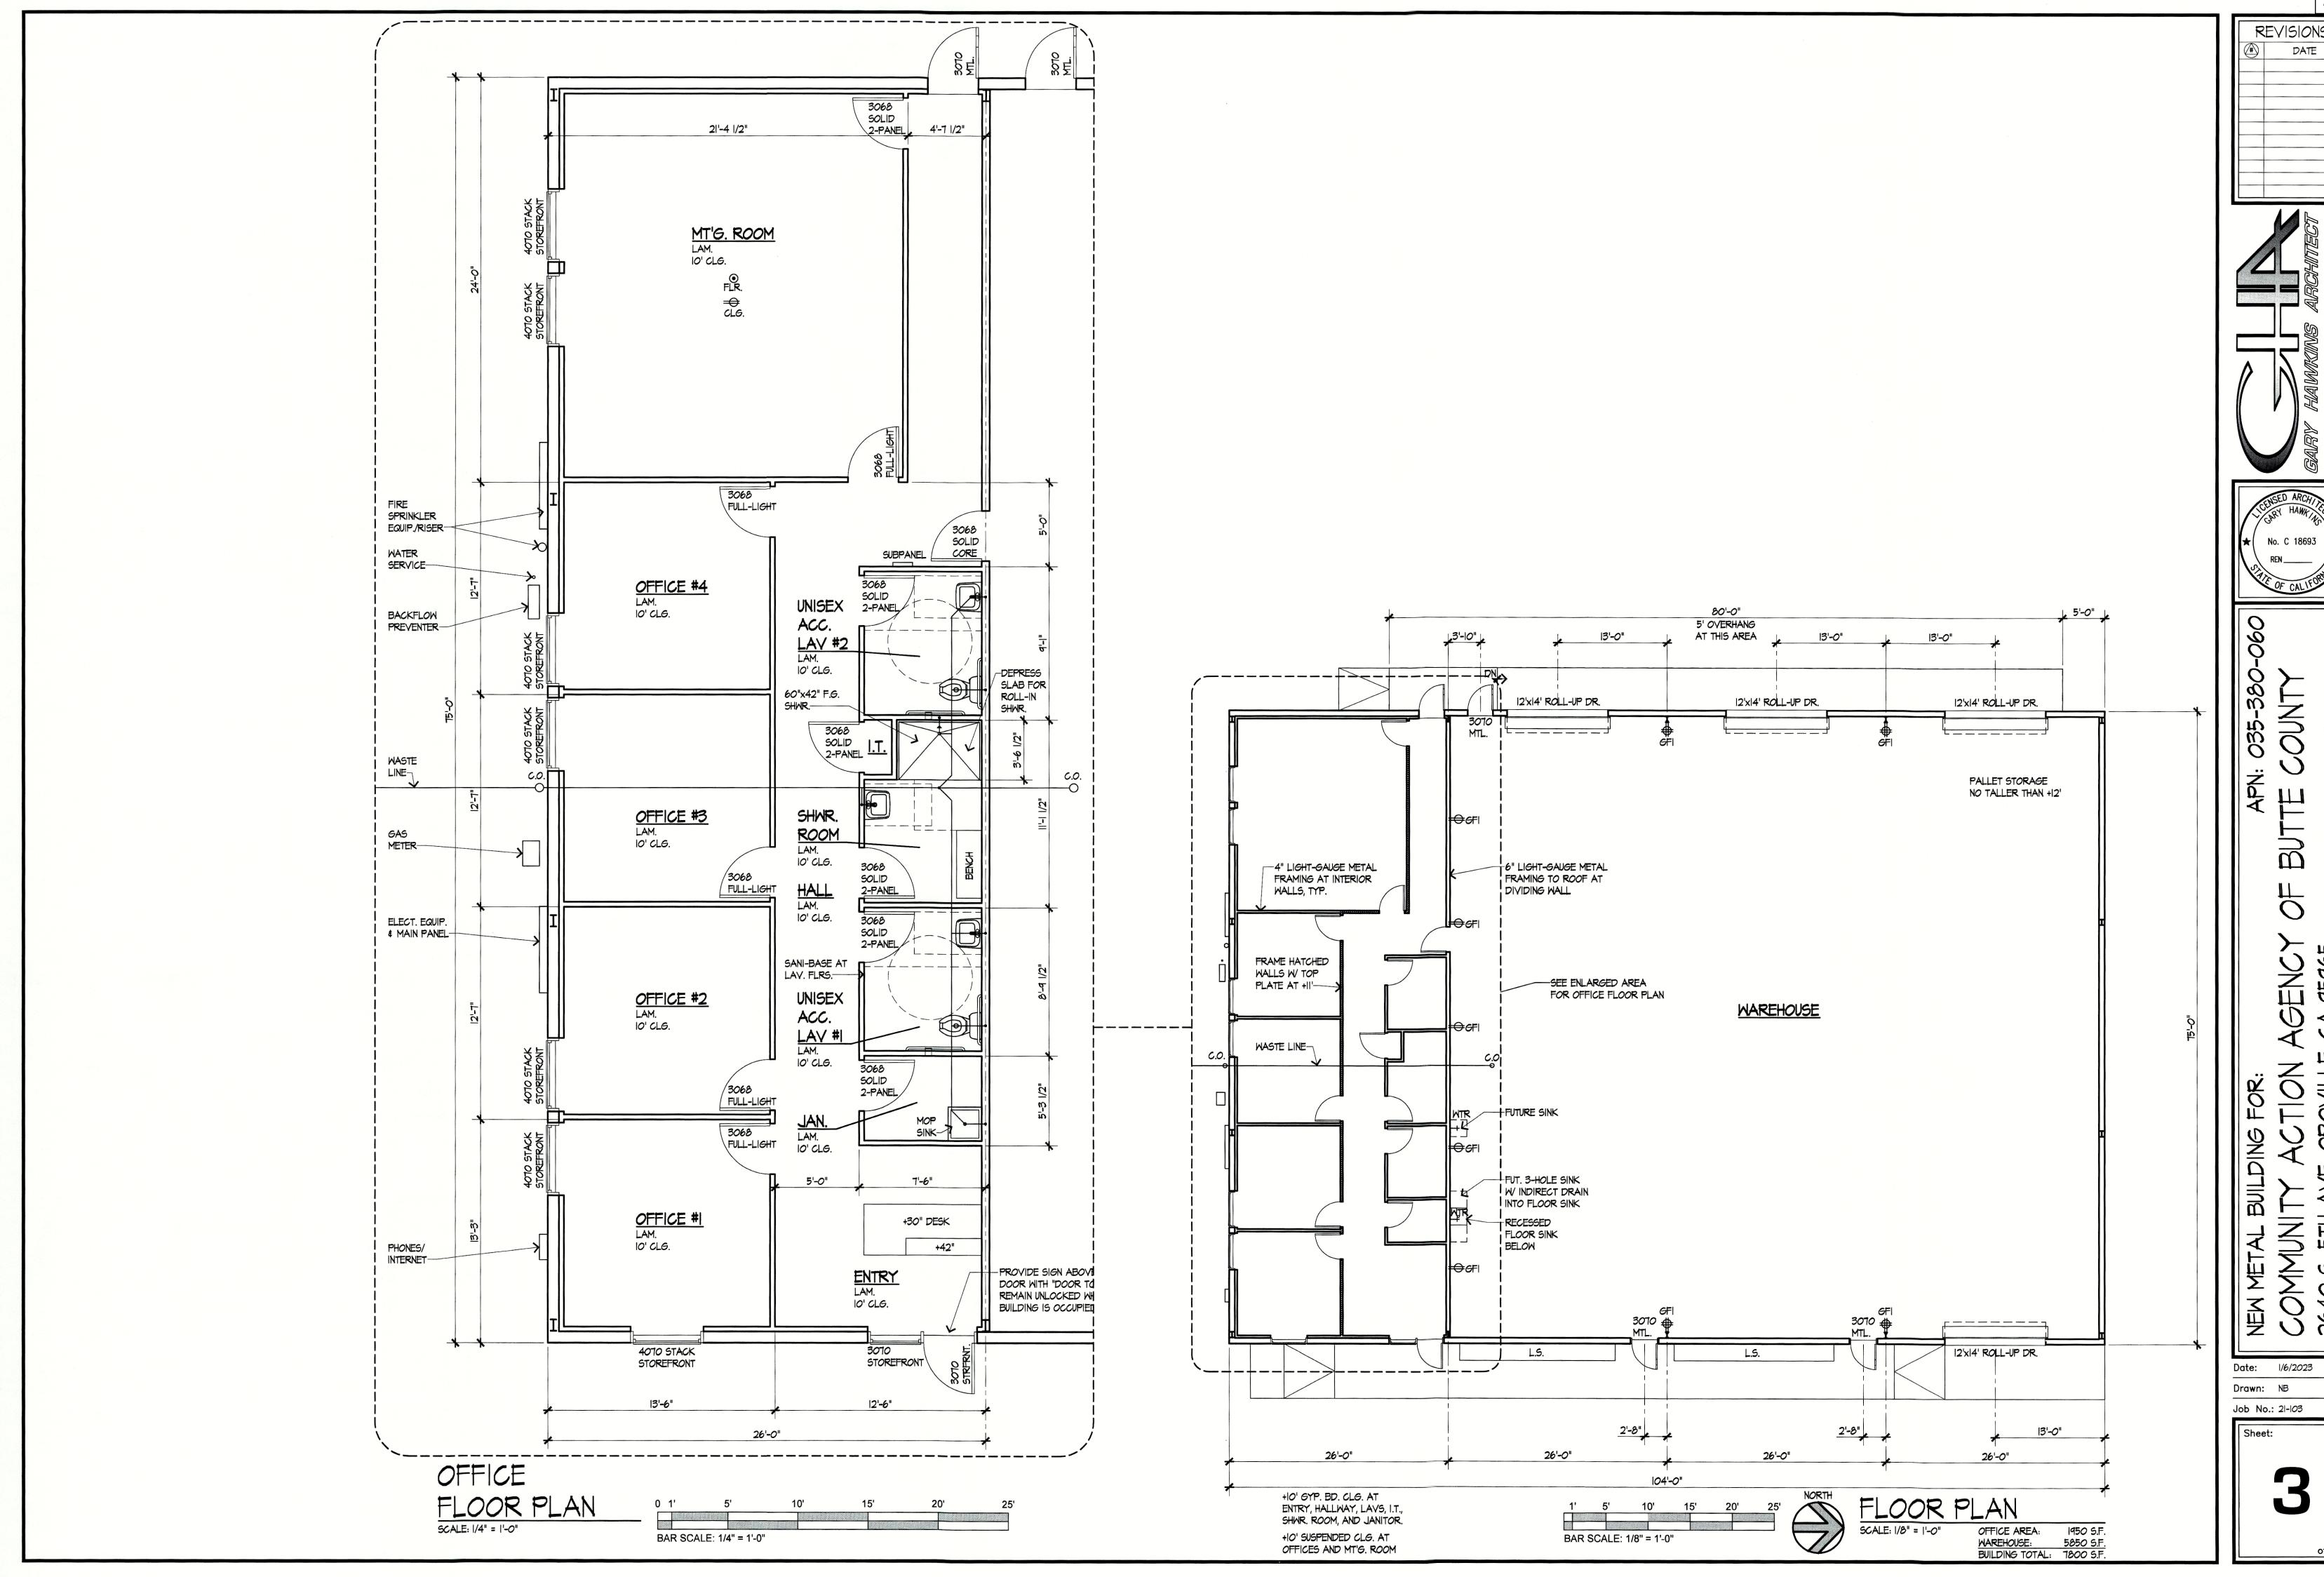
refundable. Fees that have been captured for the reimbursement of City expenses are non-


Technology cost recovery fees are non-refundable

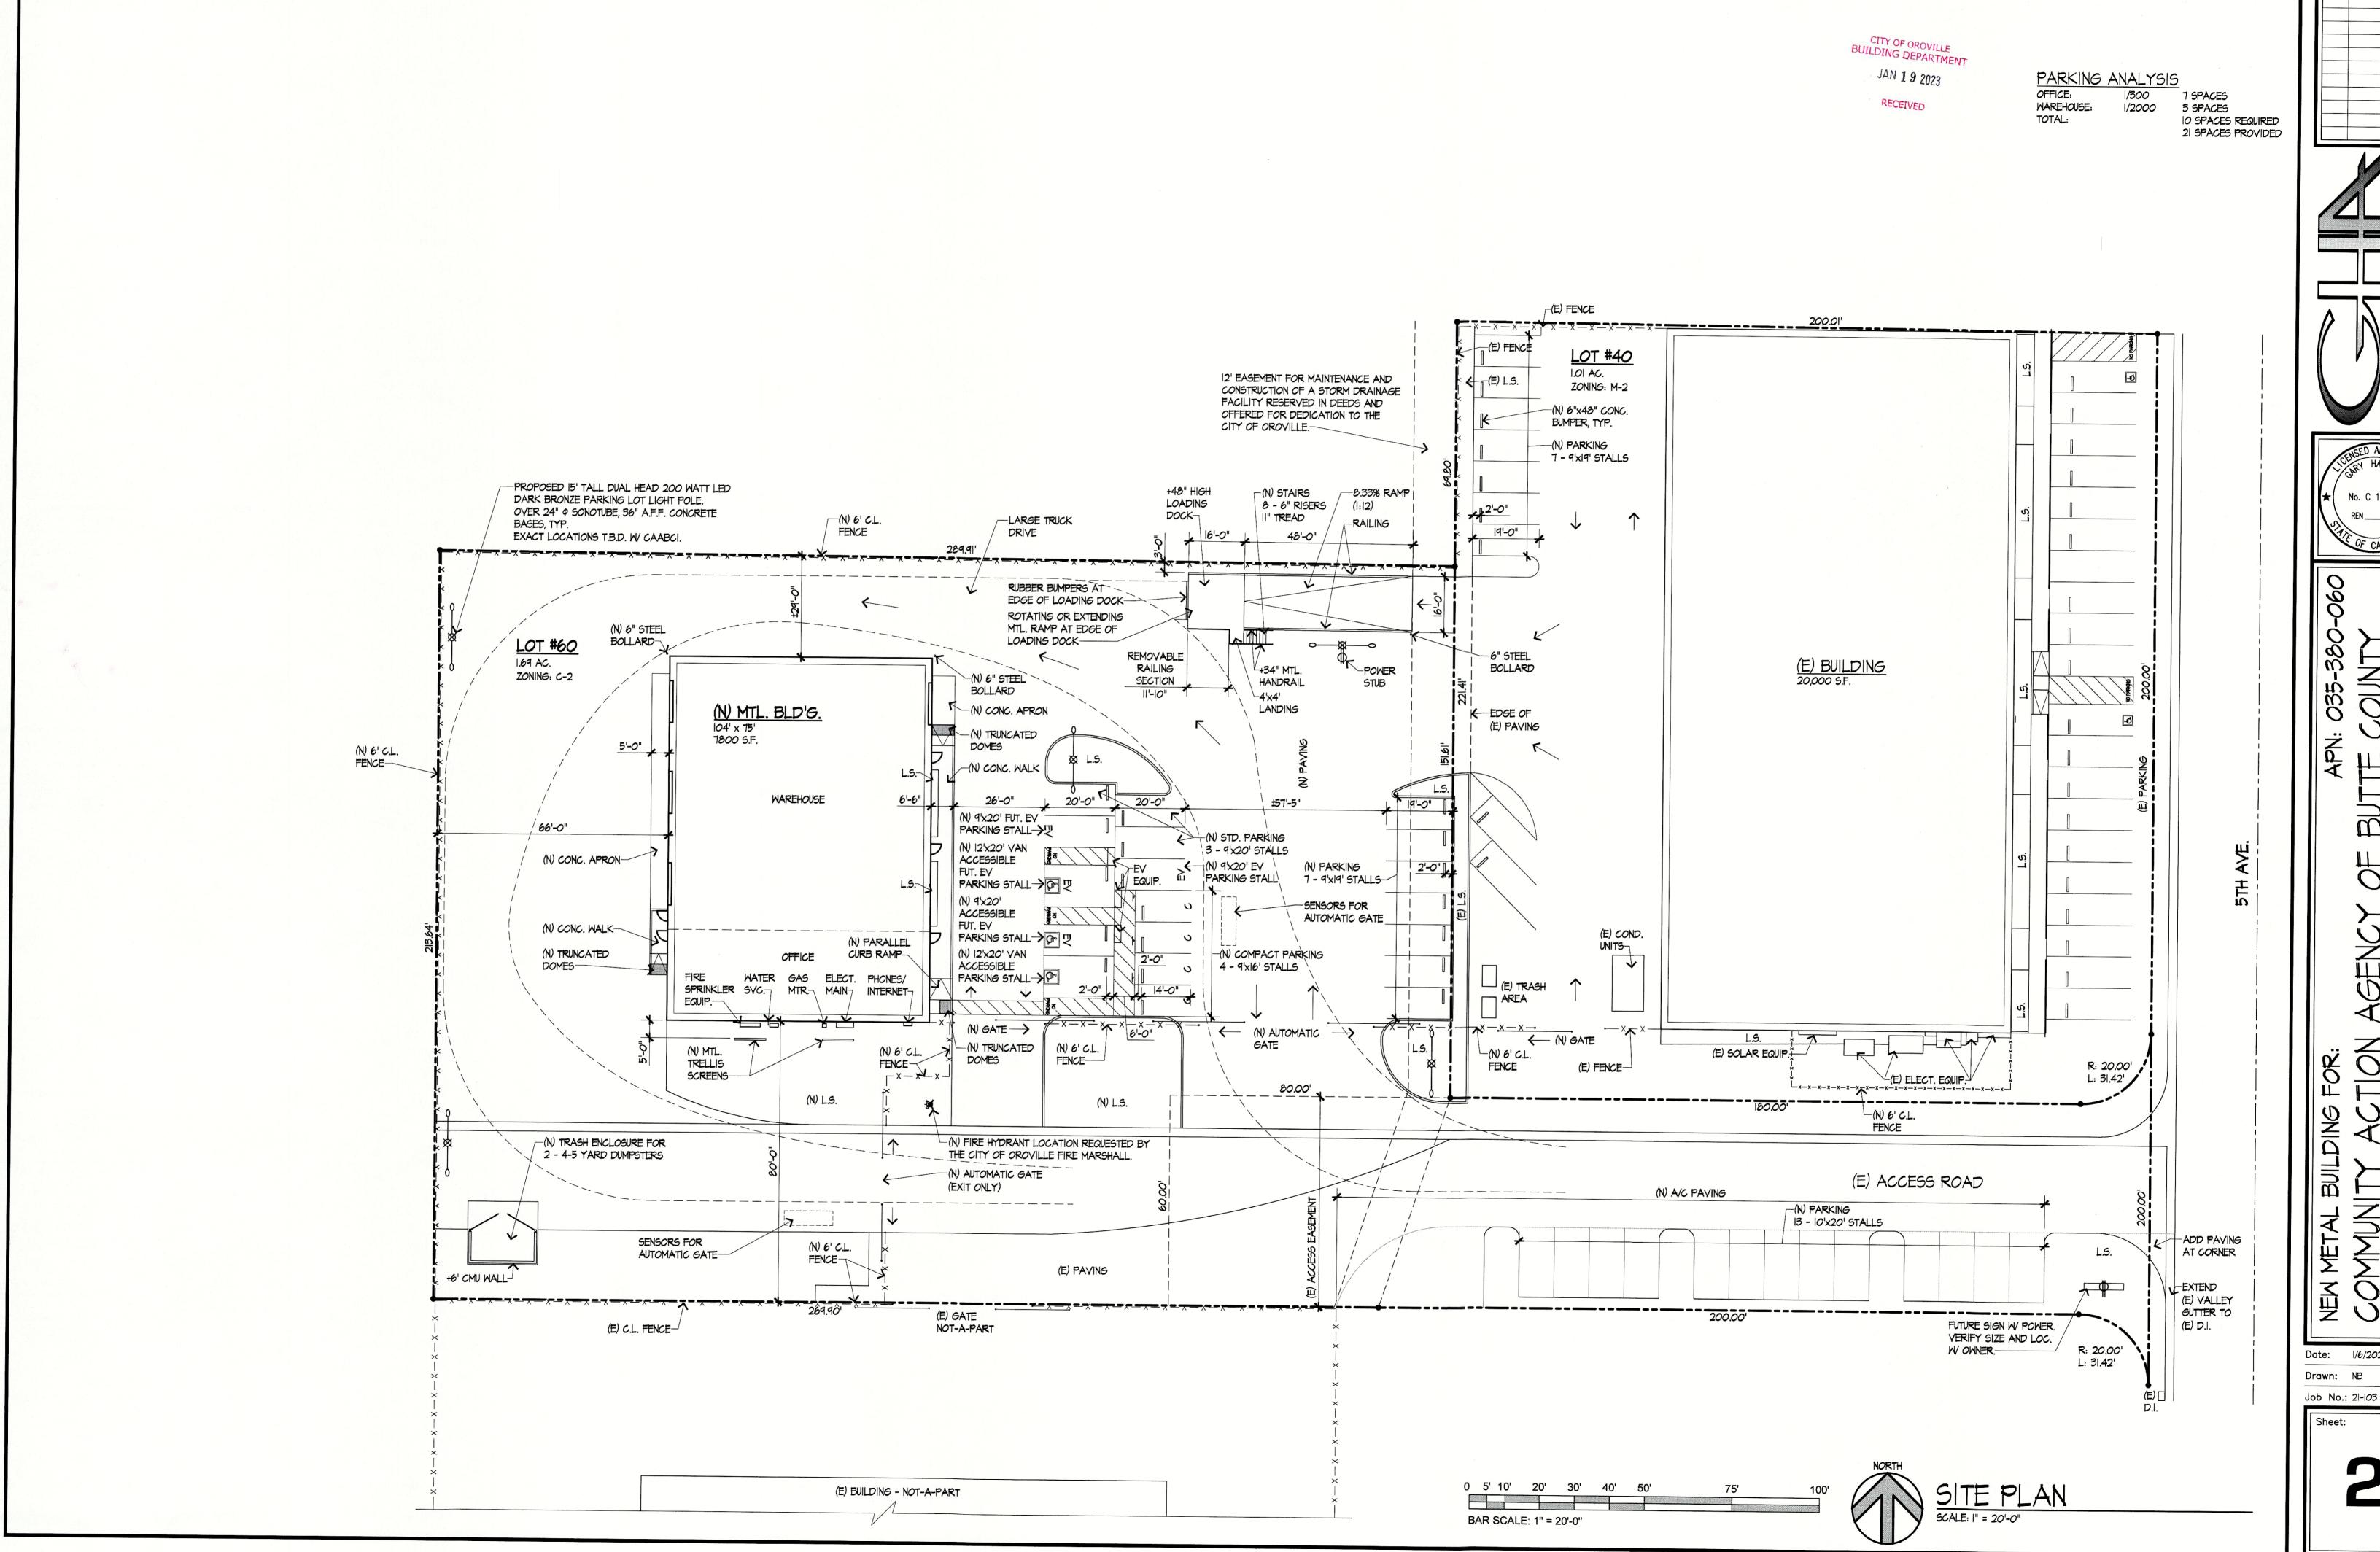

DATE

Date: 1/6/2023 Drawn: NB



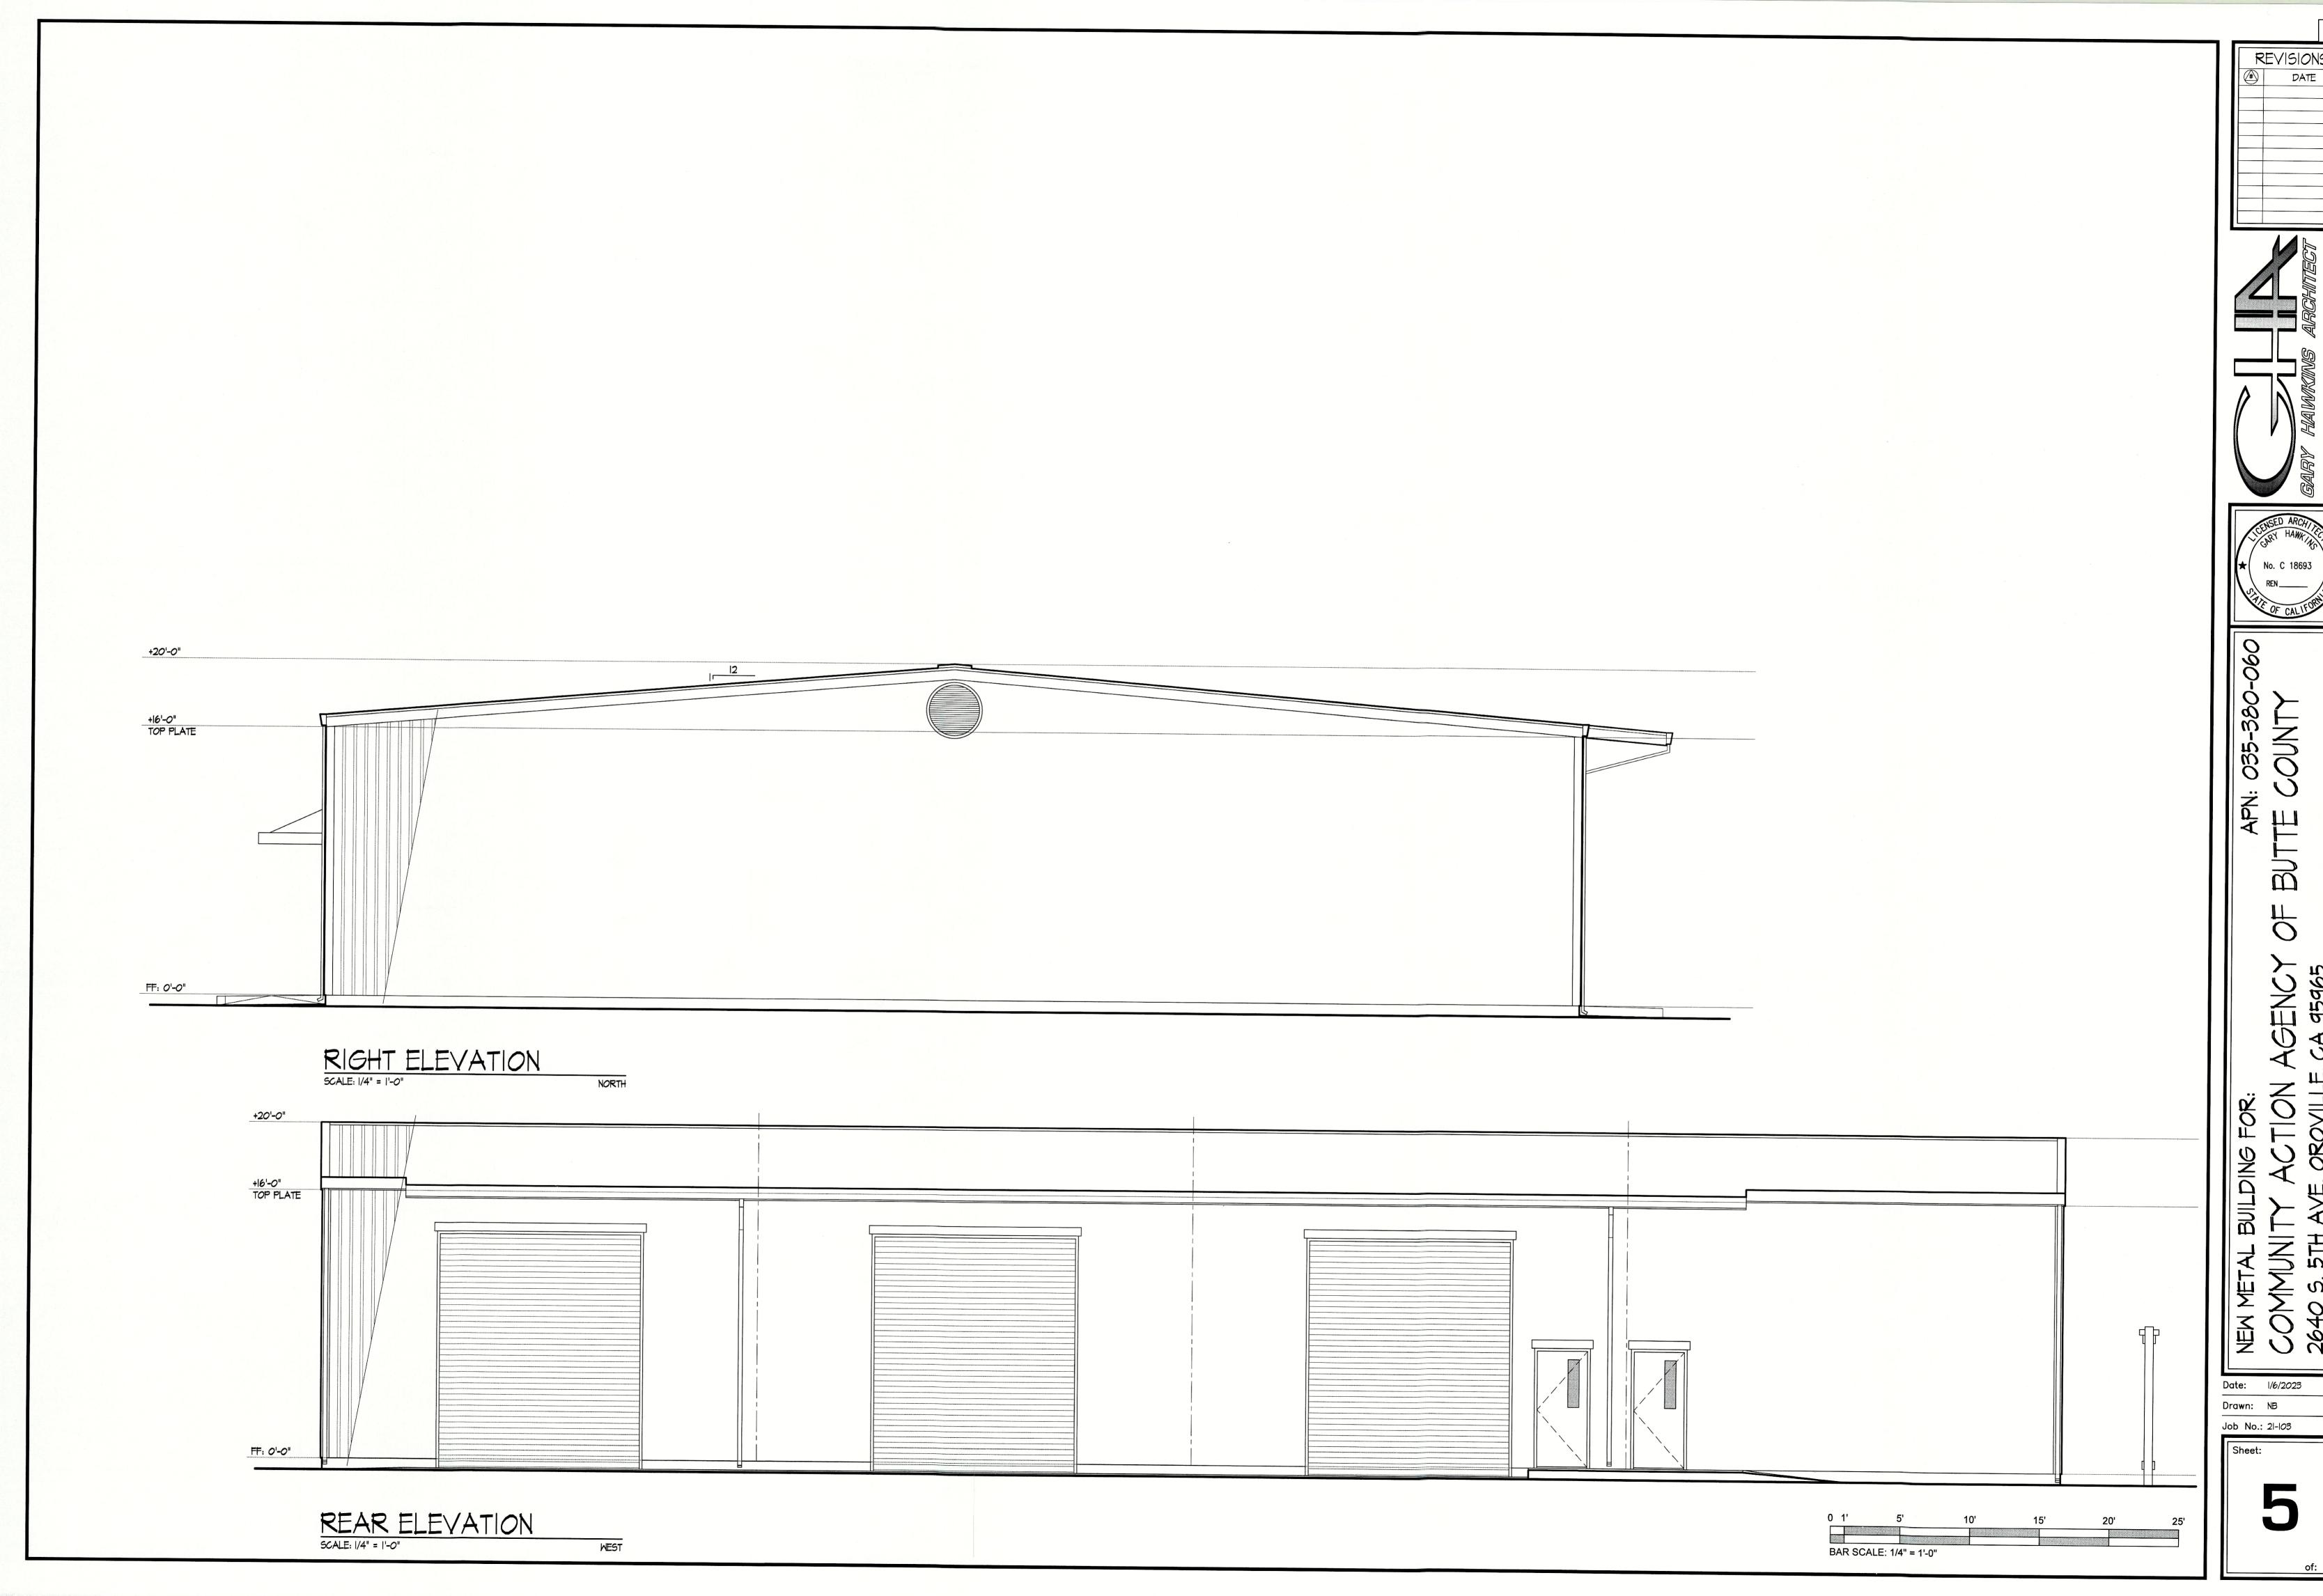

SHRUB & GROUND COVER PLANTING AREA 6,366 SF

# FIRE NOTES:

- . ENSURE LOCATION AND SIZE OF ALL TREES AT FULL MATURITY DO NOT OBSTRUCT OR OBSCURE FIRE APPURTENANCES, FIRE ACCESS OR THE BUILDING ADDRESSES OR NUMBERS FOLLOWING CONFIRMATION OF THEIR LOCATION ON THE ARCHITECTURAL AND ELECTRICAL PLANS PER 2019 CFC §505.1
- MAINTAIN TREES TO PROVIDE A 13'-6" MINIMUM VERTICAL CLEARANCE ALONG THE FIRE APPARATUS ACCESS ROADWAY PROVIDE FOR A MINIMUM 3-FOOT CLEARANCE FROM ALL FIRE PROTECTION EQUIPMENT PER

2019 CFC §507.5.4 AND §507.5.5

PARKING ANALYSIS

OFFICE: 1/300 WAREHOUSE: 1/2000 TOTAL:

3 SPACES IO SPACES REQUIRED 21 SPACES PROVIDED

CITY OF OROVILLE BUILDING DEPARTMENT

JAN 1 9 2023

RECEIVED

# PARKING LOT SHADE CALCULATIONS



# NOTES:

# A. SOIL PREPARATION AND AMENDING:

- 1) AFTER ROUGH GRADING OPERATIONS, THE CONTRACTOR IS RESPONSIBLE FOR OBTAINING A SOILS REPORT THAT PROVIDES AN ANALYSIS OF THE EXISTING SOIL THAT STATES WHAT SOIL AMENDMENTS ARE REQUIRED FOR OPTIMUM PLANTING GROWTH. THE CONTRACTOR SHALL INCORPORATE THE RECOMMENDED QUANTITIES BY THOROUGHLY CULTIVATING ALL PLANTING AREAS TO A DEPTH OF EIGHT (8) INCHES. ROUGH FINISH GRADE ALL AREAS.
- 2) BROADCAST THE FOLLOWING SOIL AMENDMENTS.
- QUANTITIES GIVEN ARE PER 1,000 SQUARE FEET
- OF AREA. NITROGEN STABILIZED AND IRON FORTIFIED COMPOST: PER SOIL ANALYSIS RECOMMENDATIONS, OR 4 CY FOR BID
- PELLETIZED FERTILIZER (21-0-0): 10LBS., OR AS PER SOIL ANALYSIS RECOMMENDATIONS SOIL SULFUR: PER SOIL ANALYSIS
- RECOMMENDATIONS
- GYPSUM: 100 LBS
- 3) CULTIVATE AND THOROUGHLY INCORPORATE THE AMENDMENTS INTO THE TOP EIGHT (8) INCHES OF SOIL
- 4) DE-ROCK AREA TO BE PLANTED BY USING A MECHANICAL ROCK PICKER. ALL ROCKS LARGER THAN I INCH IN DIAMETER ARE TO BE REMOVED.
- F. INSTALL WEED BARRIER FILTER FABRIC OVER DRIP IRRIGATION COMPONENTS, MANUFACTURED OF POLYPROPYLENE, 28 MIL THICKNESS, AND 2.6 OUNCES PER SQUARE YARD. DEWITT PRO-5, OR EQUAL SECURE FABRIC SEGMENTS, TO SOIL, WITH 6"XI"X6" STEEL 'U' SHAPE PINS. OVERLAP ADJACENT FABRIC SEGMENTS A MINIMUM OF SIX (6) INCHES AND SECURE WITH PINS AT TWENTY FOUR (24) INCHES ON CENTER.
- G. INSTALL 3" DEPTH FIR BARK MULCH OVER THE FILTER FABRIC ON ALL SHRUB AND GROUND

COVER PLANTING AREAS. BARK MULCH SHALL BE WOOD RESIDUAL DERIVED AND MANUFACTURED FROM PINE, WHITE AND/OR RED FIR TREE BARK. THE MATERIAL SHALL BE EQUAL TO THAT REFERRED TO AS WALK ON BARK' IN THE TRADE.

H. MAINTENANCE. LANDSCAPED AREAS SHALL BE CONTINUALLY MAINTAINED IN GOOD CONDITION AND SHALL BE KEPT CLEAN AND WEEDED AND TREES SHALL BE PRUNED IN A NATURAL PATTERN AND SHALL NOT BE TOPPED OR POLLARDED. MAINTENANCE SHALL INCLUDE BUT NOT BE LIMITED TO:

CULTIVATION OF PLANTING BEDS, AND MOWING TO MAINTAIN GRASSY AREAS.


PRUNING OF PLANTS AS NECESSARY TO CONTROL AND DIRECT GROWTH.3. REPLACEMENT OF DEAD OR UNHEALTHY PLANT MATERIAL IN ACCORDANCE WITH THE APPROVED LANDSCAPING PLAN.4. FERTILIZATION AS NEEDED TO ENSURE PROPER PLANT GROWTH.

REPAIR OR REPLACEMENT OF IRRIGATION SYSTEM COMPONENTS AND IRRIGATION DRAINAGE COMPONENTS, AS NEEDED, TO MAINTAIN THE SYSTEM IN GOOD WORKING CONDITION.

INSTALLATION AND MAINTENANCE AGREEMENT. FOR LAND USES OTHER THAN SINGLE-FAMILY

OWNER SHALL ENTER INTO A WRITTEN AGREEMENT FOR THE INSTALLATION AND MAINTENANCE OF LANDSCAPING. THE AGREEMENT SHALL BE IN A FORM APPROVED BY THE CITY ATTORNEY AND ZONING ADMINISTRATOR AND SUITABLE FOR RECORDATION WITH THE BUTTE COUNTY RECORDER. THE AGREEMENT SHALL BE BINDING UPON THE PROPERTY OWNER AND ANY SUCCESSORS IN INTEREST. (ORD. 1749 § 4; ORD. 1763 §§ 7, 8; ORD. 1819 § 3,

"I HAVE COMPLIED WITH THE CRITERIA OF THE MODEL WATER EFFICIENT LANDSCAPE ORDINANCE (MWELO) AND APPLIED THEM FOR THE EFFICIENT USE OF WATER IN THE LANDSCAPE DESIGN PLAN"

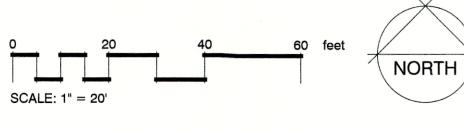

THOMAS H. PHELPS LANDSCAPE ARCHITECTURE IDLA, INC. California Landscape Architect #4122 ID #LA-16771 \* HI #LA-16112 AZ #76633

> P.O.BOX 170129 Boise, Idaho 83717 thp@idlainc.net

(208) 906-1300

These drawings are instruments of service and are the property of Thomas H. Phelps Landscape Architecture. All designs and other information on the drawings are for the use on the specified project and shall not be used otherwise without the express written permission of Thomas H. Phelps Landscape Architecture. Sheet Title LANDSCAPE PLAN

Sheet No.: Drawn By: THP Scale: |"=20'

Date: 01/18/2023 File Name: 23-004



# City of Oroville

# **COMMUNITY DEVELOPMENT DEPARTMENT**

1735 Montgomery Street Oroville, CA 95965-4897 (530) 538-2430 FAX (530) 538-2426 www.cityoforoville.org

# NOTICE OF EXEMPTION

TO Butte County Clerk FROM City of Oroville

155 Nelson Avenue 1735 Montgomery Street Oroville, CA 95965 Oroville, CA 95965

<u>Project Title</u>: Minor Use Permit UP23-01 for the construction of a new 7,800 square foot metal building used for office space and warehousing at 2640 South 5th Avenue (APN 035-380-060).

Project Location - Specific: 2640 South 5th Avenue

Project Location - City: City of Oroville

Project Location - County: Butte

<u>Description of Nature, Purpose, and beneficiaries of project:</u> The project applicant, Brody Bilson, has applied for a Use Permit for a new building primarily used as warehousing. The subject property has a zoning designation of Intensive Commercial (C-2), and a General Plan land use designation of Retail and Business Services (RBS).

Name of Public Agency Approving Project: City of Oroville

Name of Person or Agency Carrying Out Project: Brody Bilson, Butte Community Action Agency

#### Exempt Status (Check One):

☐ Ministerial (Sec. 21080(b)(1); 15268)
☐ Declared Emergency (Sec. 21080(b)(3); 15269(a))
☐ Emergency Project (Sec. 21080(b)(4); 15269(b)(c))
□ Categorical Exemption: State type & section number:
<ul> <li>In-Fill Development Projects, Title 14 CCR, §1533</li> </ul>
Statutory Exemption: State code number:

Reasons why project is exempt: This action has been determined to be exempt from the California Environmental Quality Act (CEQA) review as follows:

# In-Fill Development Projects; Title 14, CCR, §15332

Class 32 categorical exemptions consists of projects characterized as in-fill development meeting specific conditions a-e as described in this section. This project involves the development and use of currently vacant land zoned Intensive Commercial (C-2). The intent of the C-2 zoning designation is to provide for more intensive commercial establishments, including those that deal in large, low-volume items and major repair services, or that require large, outdoor display and storage areas. This project meets all conditions, including being consistent with the General Plan and Zoning Designation, occurs within City limits, has no

Item	1
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value as habitat, will not result in any significant effects, and can be adequately served by all required utilities. All business activities will be contained within the building, and the proposed use will be subject to comply with all applicable City, County, State, Federal, and other local agencies as applicable, it has been determined that there is no possibility that the use permit request will have a significant effect on the environment. Thus, this action is exempt from CEQA.

# If filed by applicant:

<ol> <li>Attach certified document of exemption finding.</li> <li>Has a notice of exemption been filed by the public</li> </ol>	c agency approving the project?   Yes   No
Lead Agency Contact Person: Daniel Kopshever	<u>Telephone</u> : (530) 538-2517
Signature:	Date:
☐ Signed by Lead Agency ☐ Signed by Applicant	



1735 Montgomery Street Oroville, CA 95965-4897 (530) 538-2402 FAX (530) 538-2426 www.cityoforoville.org

# ZONING INTERPRETATION NO. 23-1 Pertaining to a proposed use in a C-2 Zone that is not listed in Table 17.32.010-1

The Zoning Administrator has determined under OMC 17.08.090 that the proposed use of APN 035-380-060 is appropriate, substantially similar to, and less intensive than several uses approved in the C-2 Zone. Thus, the proposed use as a combination office/warehouse for the Butte Food Bank expansion is allowed, but like these other uses requires a use permit to be decided by the Planning Commission.

# **BACKGROUND**

The Butte Community Action Agency has applied to expand their food bank and distribution center located at 2460 South 5<sup>th</sup> Avenue. APN 035-380-060 is a 1.69-acre parcel fronting South 5<sup>th</sup> and located behind the Butte County Community Action Agency building. The parcel they are expanding into is zoned C-2 (Intensive Commercial), while their existing adjacent parcel is zoned M-2 (Intensive Manufacturing).

Warehousing is not listed as an allowed use in the C-2 Zoning Table 17.32.010-1. However, several similar and more intense uses are listed as requiring a use permit, including food production, manufacturing and metalwork over 20,000 square feet, large equipment repair, and parking garages.

This 7,800-sf office/warehouse building is smaller and is less intensive than the abovenamed uses. Nevertheless, a Use Permit is required, the same as for those other uses.

The project (FAR 0.10) is consistent with the General Plan designation of RBS (Retail and Business Services), to wit:

"This designation is intended to provide for business activities that offer goods and services to the community. This designation allows for a maximum FAR of 0.40, except in the Historic Downtown where an FAR of 2.0 will be allowed. Zoning districts specify where specific allowed uses, such as the production of goods, wholesale storage, and distribution facilities, may be located" (Page 3-31 Land Use)

1600The other existing adjacent warehouses also located on land zoned C-2 are:

- A 66,000 square foot warehouse built in 1985 on APN 035-380-042, address = 580
   Cal Oak Road, and occupied by PCP as an offsite warehouse for finished goods and raw materials.
- A 40,000 square foot warehouse built in 1978 on APN 035-380-051, address = 2620
   S. Fifth Avenue. Recently purchased by the Oroville Hope Center for their new central location to serve the needy.

This project will be occupied by a nonprofit agency sanctioned by and supported by Butte County and other local jurisdictions, and its expansion will benefit many citizens.

# **REQUIRED FINDINGS**

The above background allows the Zoning Administrator to make all Findings a-d, based on substantial evidence:

- a. The characteristics of, and activities associated with, the proposed use are equivalent to those of one or more of the allowable uses for the zoning district.
- b. The proposed use will not involve a higher level of activity, density or intensity than other allowable uses for the district.
- c. The proposed use will meet the purpose and intent of the applicable zoning district.
- d. The proposed use will be consistent with the goals, objectives and policies of the general plan.

Approved		
Zoning Administrator		
Date:		



# City of Oroville

### COMMUNITY DEVELOPMENT DEPARTMENT

1735 Montgomery Street Oroville, CA 95965-4897 (530) 538-2430 FAX (530) 538-2426 www.cityoforoville.org

# PLANNING COMMISSION STAFF REPORT

Thursday, February 23, 2023

RE: Minor Use Permit UP23-03 for a drive-through car wash on Feather River Blvd north of Oro Dam Blvd APN (035-030-109)

**SUMMARY:** The Oroville Planning Commission will review and consider approving Use Permit No. UP23-05 for the construction of a new 3,365 square foot car wash building with associated car wash tunnel, equipment room, and a 660 square foot pay station building with office and restrooms. The project also includes 18 standard vacuum stalls and one van accessible vacuum stall under canopies fitted with solar panels.

# **RECOMMENDATION: Staff recommends the following actions:**

- Conduct a Public Hearing on the proposed project;
- 2. Adopt the Notice of Exemption as the appropriate level of environmental review in accordance with the California Environmental Quality Act (CEQA);
- 3. Adopt the recommended Findings for Use Permit No. UP23-03;
- 4. Approve Use Permit UP23-03 and recommended Conditions of Approval;
- 5. Adopt Resolution No. P2023-03

APPLICANT:	Orlando Ramirez			
LOCATION: Corner of Feather River Blvd and Oro Dam Blvd (APN 035-030-109)		GENERAL PLAN: RBS ZONING: C-2 FLOOD ZONE: Zone X		
<b>ENVIRONMENTAL DETERMINATION:</b> Categorically Exempt per Section 15332 of Title 14, California Code of Regulations, In-Fill Development Projects.				
REPORT PREPARED BY:		REVIEWED BY:		
•	er, Assistant Planner elopment Department	Dawn Nevers, Assistant Director Community Development Department		

1

# DISCUSSION

Surf-Thru is proposing a new 3,365 square foot car wash tunnel with an equipment room, as well as a 660 square foot pay station building with office and restrooms. The project also includes 18 standard vacuum stalls and one van accessible vacuum stall under canopies with solar panels. The project site is located on approximately 1.23 acres of undeveloped land on the northwest corner of Oro Dam Blvd and Feather River Blvd north of the Maverick Gas Station. The proposed site improvements include a trash enclosure, 8 employee parking stalls, bicycle rack, and landscaping. Intended hours of operation are Monday through Friday from 7:00am to 9:00pm during the dry season and from 7:30am to 5:30pm during the rainy season. Their operational statement indicates that 4-5 employees will be on site during operational hours and the expected number of cars washed will be between 200-300 cars per day. The property has a zoning designation of Intensive Commercial (C-2). The project is adjacent to the new Dutch Brothers Coffee.

# **Design Guidelines**

# From Design Guidelines - Chapter 5 - Commercial

Section **2.1 Articulation** outlines various ways of implementing horizontal articulation, much of which is accomplished with this design. The facade is broken up by the use of multiple materials, articulation, and colors per the massing and façade sections of the guideline. Materials include split and smooth-faced block, cultured veneer, metal canopies, and concrete tiles. **2.6 Materials** should be (and are in this case) utilized in compatible combinations and accent materials should be used on all facades of the building. **2.7 Color** primary colors and other bright colors should be used as accents to enliven the architecture, but should be used sparingly. Use of matching colors between architectural elements is noted on the exterior elevation drawings.

# **Traffic Considerations**

Surf-Thru has designed the site with triple drive-thru lanes to accommodate 9 vehicles stacking between the entrance and the pay station. The drive-thru lanes merge into one lane before directing traffic into the carwash tunnel, which is 100 feet in length. Any excess vehicle stacking will be contained on private property, minimizing the possibility of any spillback into the public right of way.

In reviewing the application with the City Engineer, staff determined that a traffic study would not be required based in part on the following:

- The proposed vehicle queuing appears to be adequate to handle anticipated vehicle traffic.
- Spillback onto public property will likely not occur as any excess stacking will likely be contained on private property.
- No new driveways are proposed on Feather River Blvd.

# **Parking**

Per **OMC Table 17.12.070-1 Minimum Vehicular Parking Requirements**, car washes

2

require 2 spaces for each wash bay. Since this is a drive-through car wash, 1 space for each 300 square feet of gross floor area shall be used to calculate the minimum parking requirement. This would equal approximately 14 spaces. Applicant is proposing 29 spaces total, which is adequate for the use. This total includes the vacuum stalls, employee parking, and handicap accessible parking.

# Landscaping

Preliminary landscape plans include a variety of drought tolerant plants (drought tolerant after one year) with trees along the site entrance as well as along the southern property line. Shrub groundcover is shown buffering the parking lot and adjacent parcels. All plants will need to have drip irrigation, watering to be reduced after one year to a once per week watering schedule. Water should be kept off in winter months. Prior to construction, detailed landscape and irrigation plans must be submitted.

# Lighting

The proposed lighting model shows foot candle intensity compliant with **OMC 17.12.010 Performance Standards (C) Outdoor Lighting**. Lights shall have a maximum height of 24 feet, which is the height of the proposed building's parapets.

# **Signage**

Conceptual signage is shown on exterior elevations. The plans' keynotes indicate that signage will be applied for under separate application and review.

### **Trash Enclosure**

Proposed trash enclosure location is adequately screened with landscaping. Enclosure shall be designed in accordance with **OMC 17.12.110 Enclosures for solid waste and recyclable materials.** 

# **Water Quality Requirements**

Surf Thru has submitted a statement regarding its water usage: "Surf Thru Car Wash uses an average of 30-40 gallons of freshwater per vehicle. Additionally, our wash process utilizes an underground filtration system that stores and recycles most of the water used.

Per **OMC 17.16.090 Car and vehicle washes:** Each designated wash area shall be paved with an impervious surface and shall be designed and graded so as to collect all wash water and direct the water to an approved drainage system. All wash water shall be treated and filtered on-site to remove sediment and pollutants, using a method approved by the city engineering design standards, before it is discharged into the sanitary sewer system.

An in-bay car wash or a conveyor belt car wash permitted and constructed after January 1, 2014 shall do either of the following:

a. Install, use, and maintain a water recycling system that recycles and reuses at least 60% of the wash and rinse water.

3

b. Use recycled water provided by a water supplier for at least 60% of its wash and rinse water.

# OMC 17.08.135 Art in public places/Oroville beautification.

**Public Art Contribution**. All new nonresidential development projects subject to the requirements of this section shall install public art on the project site in a public place as approved by the city council. The cost of the public art must be equal to at least one percent of the estimated construction costs. The creator of public art shall be an artist, defined as a person who has a reputation among peers as a person of artistic excellence, through a record of exhibitions, public commissions, sale of works, or educational attainment as judged by the arts commission. Public art shall be displayed in a manner that will enhance its enjoyment by the general public. The developer has the option to opt out of this requirement and instead pay the equivalent in-lieu fee which shall be a one percent fee of the estimated construction costs.

<u>Execution of Installation/Time of Payment</u>. If the developer chooses to pay the in-lieu fee, payment in full shall be required at the time all fees are due on any project processed through the city or upon completion of the project, whichever occurs first. The payment of all outstanding fees shall be required prior to the issuance of a Certificate of Occupancy.

For developers choosing to provide art as part of their project the developer shall provide the city with designs for review by the Arts Commission, plus proof of installation of the required public art on the development site - prior to the issuance of a Certificate of Occupancy.

# Required Findings for Use Permits (OMC 17.48.010)

Before approving a use permit, the Planning Commission must consider each of the following issues and make appropriate findings (Staff's comments are in *italics*, draft findings are in the Resolution):

1. The granting of the permit will not be incompatible with or detrimental to the general health, safety or public welfare of the surrounding area or of the city as a whole.

The project will be located in an area surrounded by active commercial development. The project has been reviewed and conditioned to minimize or prevent any potential impacts to the general health, safety, or public welfare of the surrounding area and the city as a whole.

2. The proposed use follows sound principles of land use by having a suitable location relative to the community as a whole, as well as to transportation facilities, public services and other land uses in the vicinity.

The proposed use will provide a desired commercial product and is located in an area with significant employment and transportation access.

3. Public utilities and facilities, including streets and highways, water and sanitation, are adequate to serve the proposed use or will be made adequate prior to the establishment of the proposed use.

All infrastructure is in and available. Any utilities not already provided on site will be installed by the property owner, subject to all applicable fees and permits.

4. The location, size, design and operating characteristics of the proposed use will be harmonious and compatible with the surrounding neighborhood and will not adversely affect abutting properties.

As required by OMC Chapter 17.52, the project underwent development review and the applicant made revisions based on the committee's comments. Surf-Thru will be located in an area near compatible commercial businesses. The intended hours of operation are compatible with surrounding users. The site plan, design, lighting, landscaping, and other improvements have been reviewed and the project conditioned to minimize any adverse impacts on abutting properties. Code enforcement will monitor for compliance on an ongoing basis.

5. The subject site is physically suitable for the type and intensity of land use being proposed.

Applicant has submitted a set of drawings demonstrating that the site is physically suitable for the proposed type and intensity of use. The site will provide adequate capacity for the use.

6. The size, intensity and location of the proposed use will provide services that are necessary or desirable for the neighborhood and community as a whole.

Surf-Thru will provide a desired service for the neighborhood and the community as a whole.

7. The permit complies with all applicable laws and regulations, including the requirements of the general plan, of this title and of the city municipal code.

The use is permitted, subject to a use permit for the drive-thru, and is compatible with the General Plan, Zoning codes, and the Oroville Municipal Code.

# **FISCAL IMPACT**

None. The project is subject to all customary fees.

### **PUBLIC NOTICE**

A request for comments was prepared and circulated to the local agencies and surrounding property owners within 300 feet of the property. Additionally, the meeting date, time, and project description were published in the Oroville Mercury

Register and posted at City Hall.

# **ATTACHMENTS**

- 1. Resolution 2023-03
- Notice of Exemption (CEQA)
   Application Materials

### **RESOLUTION NO. P2023-03**

A RESOLUTION BY THE OROVILLE CITY PLANNING COMMISSION MAKING FINDINGS AND CONDITIONALLY APPROVING UP#23-03, FOR A NEW DRIVE-THROUGH CAR WASH ON FEATHER RIVER BOULEVARD NORTH OF OROVILLE DAM BLVD EAST (APN 035-030-109)

**WHEREAS**, the City has received a Use Permit application for new 3,365 square foot car wash building with associated car wash tunnel, equipment room, and a 660 square foot pay station building with office and restrooms at APN 035-030-109; and

WHEREAS, the property is zoned Intensive Commercial (C-2); and

**WHEREAS**, a car wash is listed in OMC Table 17.32.010-1 Allowed Uses in Commercial Districts as a permitted use in C-2. However, drive-through establishments are subject to a Use Permit. As a condition of approval, the applicant will be required to comply with all requirements of the City's Zoning Code as found in the OMC Chapter 17, including, but not limited to, development standards, permit requirements and development review; and

**WHEREAS**, at a duly noticed public hearing, the Planning Commission considered the comments and concerns of public agencies, property owners, and members of the public who are potentially affected by the approval of the use permit described herein, and also considered the City's staff report regarding the change.

# NOW, THEREFORE, BE IT RESOLVED BY THE PLANNING COMMISSION as follows:

- This action has been determined to be exempt from the California Environmental Quality Act (CEQA) review pursuant to Title 14, California Code of Regulations, Section 15332 "In-Fill Development Projects."
- 2. The Planning Commission approves the findings required by Section 17.16.160 of the Oroville City Code, as described in the Staff Report;
- 3. The Planning Commission approves the permit conditions described in this Resolution.

# REQUIRED FINDINGS (OMC 17.48.010) FOR DRIVE THROUGH ESTABLISHMENTS

a) The granting of the permit will not be incompatible with or detrimental to the general health, safety or public welfare of the surrounding area or of the city as a whole.

The project will be in a location surrounded by active commercial development;

- b) The proposed use follows sound principles of land use by having a suitable location relative to the community as a whole, as well as to transportation facilities, public services and other land uses in the vicinity.
  - The proposed use will provide a desired commercial product, and is located in an area with significant employment and transportation access;
- c) Public utilities and facilities, including streets and highways, water and sanitation, are adequate to serve the proposed use or will be made adequate prior to the establishment of the proposed use.
  - All infrastructure is in and available, especially if applicant meets all proposed conditions, and any future conditions imposed by the City or Caltrans,
- d) The location, size, design and operating characteristics of the proposed use will be harmonious and compatible with the surrounding neighborhood and will not adversely affect abutting properties.
  - All abutting properties are also commercial. The proposed use is compatible with the surrounding neighborhood;
- e) The subject site is physically suitable for the type and intensity of land use being proposed.
  - Applicant has submitted a set of drawings demonstrating that the site is physically suitable for the proposed type and intensity of use. The site will provide adequate capacity for the use;
- f) The size, intensity and location of the proposed use will provide services that are necessary or desirable for the neighborhood and community as a whole.
  - The commercial pad has been vacant for years, and a new commercial tenant is desirable for the neighborhood and the entire community;
- g) The permit complies with all applicable laws and regulations, including the requirements of the general plan, of this title and of the city municipal code.
  - The use is permitted, subject to a use permit for the drive-thru, and is compatible with the General Plan, Zoning codes, and the Oroville Municipal Code.

# **CONDITIONS OF APPROVAL**

**Approved project:** The Planning Commission hereby conditionally approves Use Permit No. 23-03, permitting a drive-through at the proposed building on Feather River Boulevard (APN 035-030-109). The subject property has a zoning designation of Intensive Commercial (C-2) and a General Plan land use designation of Retail Business Services (RBS).

# **General Conditions**

1. The applicant shall hold harmless the City, its Council members, Planning Commissioners, officers, agents, employees, and representatives from liability for any

- award, damages, costs, and/or fees incurred by the City and/or awarded to any plaintiff in an action challenging the validity of this permit or any environmental or other documentation related to approval of this permit. Applicant further agrees to provide a defense for the City in any such action.
- 2. The project shall remain in substantial conformance with the Conditions of Approval, as adopted by the Oroville Planning Commission. Any subsequent minor changes in the project (as determined by the Zoning Administrator) may only occur subject to appropriate City review and approval. Any subsequent substantive changes in the project (as determined by the Zoning Administrator) may only occur subject to discretionary review by the Oroville Planning Commission.
- 3. The applicant shall annually pay for and obtain a City of Oroville business license.
- 4. All private facilities, improvements, infrastructure, systems, equipment, common areas, etc. shall be operated and maintained by the applicant in such a manner, and with such frequency, to ensure the public health, safety and general welfare.
- 5. All costs of operation and maintenance of private facilities, improvements, infrastructure, systems, equipment, common areas, etc. shall be the responsibility of the applicant.
- 6. Pursuant to Section 17.12.010, the proposed use of the site shall conform to the performance standards of the Oroville Municipal Code to minimize any potential negative effects that the building, structure, lighting or use could have on its surroundings, and to promote compatibility with surrounding uses and areas.
- 7. Applicable construction plans, calculations, specifications, applications, forms, etc. shall be submitted to the Building Division for review prior to the start of any construction activities requiring a building permit. All applicable plan review and development impact fees shall be paid at time of submittal.
- 8. The applicant shall ascertain and comply with the requirements of all of City, County, State, Federal, and other local agencies as applicable to the proposed project.
- 9. The project shall comply with the City's noise ordinance as found in the OMC Chapter 9.20.
- 10. Each use permit shall be issued subject to the condition that the zoning administrator may inspect the premises for which the use permit is issued at any reasonable time to ensure compliance with the conditions of the use permit. Refusal to permit the zoning administrator to inspect the premises shall be rebuttably presumed to be grounds for revocation of the use permit.
- 11. Pursuant to Section 17.48.010(F) of the City Code, the Planning Commission, upon its own motion, may modify or revoke any use permit that has been granted pursuant to the provisions of this section upon finding any of the following, based on substantial evidence:
  - I. Any of the conditions of the permit have not been satisfied within 1 year after it was granted.

- II. Any of the terms or conditions of the permit have been violated.
- III. A law, including any requirement in the Municipal Code Chapter 17, has been violated in connection with the permit.
- IV. The permit was obtained by fraud.
- 12. Applicant hereby certifies that any and all statements and information provided as part of the application are true and correct to the best of their knowledge and belief. Any misinformation provided, whether intentional or unintentional, that was considered in the issuance of this permit may be grounds for revocation.
- 13. Any roof mounted or ground placed utilities (HVAC, generators, etc.) shall include an architecturally compatible method of screening. This can include screening by landscaping or a decorative fence for ground placed utilities.
- 14. Building shall be addressed per City requirements. Building numbers shall comply with City Code 17.20.050(A).
- 15. The applicant shall submit to the City details of exterior lighting for review and approval.
- 16. The applicant or property owner shall apply for the proper permits as required by OMC Chapter 17.20 prior to any new signage being erected.
- 17. No more than 25% of any window area shall be covered with signs. This includes both permanent and temporary signs used to identify the business, products sold, or services offered.
- 18. The exterior of the building, including windows and doors, shall be maintained, and with such frequency, to ensure the public health, safety and general welfare of the city.
- 19. Windows and doors shall not be boarded up or blocked unless the appropriate approvals are received to ensure the public health, safety and general welfare. This does not include the use of plywood or other material used to cover a window for a temporary period of time that constitutes a safety hazard and/or invites trespassers and malicious mischief.
- 20. Minor changes may be approved administratively by the Community Development Director or designee upon receipt of a written request by the applicant or designee. Changes deemed to be major or significant in nature shall require a formal application for amendment.
- 21. Applicant and/or property owner will take appropriate measures to provide property maintenance of the building exterior, including provisions to keep the premise free of litter and debris.
- 22. Applicant and/or property owner shall ensure adequate lighting of exterior areas, including parking lots, to discourage loitering outside of the buildings.
- 23. Applicant and/or property owner will ensure protection of adjacent properties from noise, odors and undue light and glare, as well as illegal activity.

24. Applicant and/or property owner will maintain adequate onsite security, both inside and outside the building, to satisfy any concerns raised by the chief of police or general public. Substantial camera surveillance and written security protocols approved by the chief of police will suffice.

# **Specific Project Permit Conditions**

- 1. Ensure that signage clearly and immediately directs patrons to the desired drive-thru lane.
- 2. Signage is not included in this Use Permit. Any signage requiring permits will require a new building permit submittal.
- 3. The quantity, locations and striping of all primary and shared parking shall be shown in the building plans upon permit submittal.
- 4. A refuse collection enclosure shall be provided in accordance with City Code 17.12.110. The refuse area shall be large enough to provide adequate storage for solid waste and recyclable materials generated by the use. The drive-through shall not be used by customer's vehicles at the same time as Recology refuse collection vehicles.
- 5. Applicant has submitted a preliminary landscape plan. A Landscape Maintenance Agreement shall be executed to ensure proper maintenance of the property. The agreement shall be in a form approved by the City Attorney and Zoning Administrator and suitable for recordation with the Butte County recorder. The agreement shall be binding upon the property owner and any successors in interest.
- 6. Signage is not included in this Use Permit. Signage will require a new building permit submittal.

# \*\*\*End of Conditions\*\*\*

I HEREBY CERTIFY that the foregoing resolution was duly introduced and passed at	а
regular meeting of the Planning Commission of the City of Oroville held on the 26th of	of
February 2023, by the following vote:	
AYES:	

NOES:	
ABSTAIN:	
ABSENT:	
ATTEST:	APPROVE:

JACKIE GLOVER, ASSISTANT CITY CLERK CARL DURLING, CHAIRPERSON



# **City of Oroville**

Planning Division - Community Development Department

1735 Montgomery Street Oroville, CA 95965-4897 (530) 538-2430 FAX (530) 538-2426 www.cityoforoville.org

TRAKIT#:

### PLANNING DIVISION GENERAL APPLICATION

(Please print clearly and fill in all that apply)

	(Flease print clearly and illi ill								,	+		
APPLICANT'S INFORMATION					Project's:	N/A						
Nan	ne:	Orlando Ram	irez			Name:						
Add	Address: 6781 N Palm Ave Fres				, CA 93704	Company:						
Pho	ne:	559-903-9418	3			Address:						
Ema	ail:	orlandor@bo	ttom-lin	e.c	om	Phone:						
Is th	e applic	ant the Owner?	If applicant is owner /agent a side.	Not the authoriz	owner, please provide ation on the reverse	Email:						
		DEVELOP		JEC	TS & OTHER A	PPLICATION	S (Ple	ase c	heck a	all that a	apply)	
	Anne	kation			Landmark /Modi	fication/Demoliti	on		Tenta	ative Pa	rcel Map	)
	Appea	al			Mining and Recl	amation Plan		П	Tenta	ative Su	bdivisior	п Мар
1	Devel	opment Review			Pre-Application				Use	Permit		
	Final	Мар			Residential Dens	sity Bonus			Varia	ance		
	Gene	ral Plan Amendment/	Rezone		Temporary Use				Wire	less Co	mmunica	ation Facilities
	Landr	nark Designation			Tentative Map E	xtension			Zonir	Zoning Clearance		
П	Other	: (Please Specify)			"							
		+	ADMINIS	TRA	TIVE PERMITS	(Please check	c all th	nat ap	ply)			
	Adult	Oriented Business			Outdoor Storage	)		ΠÌ	Spec	ial Eve	nt	
Home Occupation					Outdoor Display & Sales			П	Stree	et Closu	re	
Large Family Day Care					Second Dwelling Unit			Tree Removal				
Mobile Food Vendor Sign				Sign/Temporary	Sign Permit							
	Other	: (Please Specify)										
*Please provide a letter addressed to the Planning Division with a detailed description for the proposed project. Please include any site plans, maps, aerials, photos, and other relevant information that will help us in processing your application.  ** Any time a set of plans is required, three (3) sets of drawings shall be submitted, unless otherwise directed.												
			•		PROJECT IN							
Proj	ect Nar	ne: Oroville Surf Thru				Proposed Struc	ture(s	) (Sq	Ft.): +/-	3,398sf ca	wash tunne	l and +/-660sf paystation
Address: NWC Oro Dam Blvd. and Feather River Blvd.				Existing Structure(s) (Sq Ft.): 0								
		oss Street: Oro Dam E			River Blvd.	Water Provider						
				School District: Oroville Union								
Lot Size (Acres): +/- 1.23ac				Number of Dwe	elling L	Jnits: I	V/A					
APPLICANT'S SIGNATURE  I hereby certify that the information provided in this application is, to my knowledge, true and correct.												
Signature:					- NEW TOWNS WITH THE	, '		23-1		Date:	1/20/23	
					OFFICE U	SE ONLY						
Gen	eral Pla	an:	Zor	ing:		Zoning Conform	nity:			APN:		
	Fi	le#	Overlay Z	oning	g:	Minimum Setba	icks:	FY		R	Y	SY

AGENT AUTHORIZATION							
To the City of Oroville,	Department of Community Develo	opment					
NAME OF AGENT:	Orlando Ramirez	PHONE NUMBER:	559-999-1963				
COMPANY NAME:	Bottom Line Group	EMAIL:	orlandor@bottom-line.com				
ADDRESS:	6781 N Palm Ave	CITY/ST/ZIP:	Fresno, CA 93704				
AGENT SIGNATURE	: 💝						
Is hereby authorized t	o process this application on my	/our property, identified as Butte	County Assessor Parcel Number (s):				
Portion of 035-030-109							
	ows representation for all applicated including document (s) relation		t to sign all documents necessary for				

O١	vner(	s)	of	Record	(sign	and	print	name
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<u> </u>	ici(3) of Necola (sign and print han			
1)	Sur Thu, Tisc		Society 1/24/2023	
	Print Name of Owner	Signature of Owner	Date	
2)				
	Print Name of Owner	Signature of Owner	Date	
		-		
3)				
	Print Name of Owner	Signature of Owner	Date	
		-		
4)				
	Print Name of Owner	Signature of Owner	Date	
		_		
	Owner's Mailing Address	Owner's Email	Owner's Phone #	
	_			

The Community Development Department operates on a full cost recovery for processing of permits. Staff will charge their time and any expenses associated with processing the application against the initial deposit. Fees that have been captured for the reimbursement of City expenses are nonrefundable.

Technology cost recovery fees are non-refundable



## **City of Oroville**

Planning Division - Community Development Department

1735 Montgomery Street Oroville, CA 95965-4897 (530) 538-2430 FAX (530)538-2426 www.cityoforoville.org

TRAKIT#:

## **DEVELOPMENT REVIEW / PRE-APPLICATION**

(Please print clearly and fill in all that apply)

REC	REQUIRED FOR A COMPLETE APPLICATION								
/	Completed and signed Application Forms								
	Application Fee Paid (\$230.42) + 6% Tech Fee = \$244.25								
2nd	e Developr Thursday c ressed.	nent Review Committee of each month, with meeting	(DRC) w ngs star	ill meet at least once p ting at 3:00 p.m. and c	er month, or as nee oncluding once all th	ded. General ne items on th	ly, the DRC will meet on the agenda have been	the	
	Are yo	u requesting a Pre-Appli	cation (In	nitial Project Review)?	No				
	Are yo	u requesting a Developm	ent Rev	iew?	Yes				
	• Is the	Project in the Downtown	Historic	Overlay?	No				
			TYPE (	OF PROJECT (Pleas	e check all that appl	y)			
	Accessory	/ Structure	<b>'</b>	New Construction		/ Site Imp	rovements		
	Fencing			New Use of Existing	Structure(s)	Industria	al		
	Landmark	Demolition		Parking		Comme	rcial		
	Landmark	Modification		Planned Unit Develo	ppment	Residen	tial		
	Landscap	ing		Sign Program		Mixed U	se		
	Other: (Pl Specify)	ease				:			
		REQ	UIRED	DOCUMENTS (Plea	ase provide all that	apply)			
<b>/</b>	Site Plans	3							
1	Architectu	ral drawings showing pro	posed b	ouilding elevations					
~	Landscap	e plans showing the type	s, sizes	and location of vegeta	tion to be planted ar	nd the irrigation	on system to be installed		
<b>/</b>	Plans for	the configuration and lay	out of all	off-street parking space	ces				
<b>'</b>	Plans for	all lighting to be installed	on the s	ite, including the locati	on, type, height and	brightness of	f each lighting fixture		
<b>'</b>	Drawings	of all signs that are prop	osed in a	association with the pro	oject				
	Any appro	priate studies required for	or the pro	oject (i.e. traffic, noise,	geotechnical, sewe	r capacity, his	storical review, etc.)		
/	projects, h	escription, and explanation ours of operations, numbered and sold.					ded use, for commercial a offered, products	and	
ADDITIONAL INFORMATION									
<ol> <li>For any project that requires development review, buildings permits shall not be issued until the project's development review application has been approved.</li> <li>Buildings plans submitted to the Building Division for review while simultaneously undergoing the development review process with the Planning Division are subject to change.</li> <li>All plans and drawings shall be drawn to scale to the extent feasible and shall indicate the full dimensions, contours and other topographic features and information necessary to make a full evaluation of the project.</li> </ol>									
APPLICANT'S SIGNATURE  I hereby certify that the information provided in this application is, to my knowledge, true and correct.									
Signature: Date: 1/25/23									
OFFICE USE ONLY									
App	roved By:					Date:			
Payment: Number:						11			

PROJECT DESCRIPTION

**Detailed Description:** 

This project encompasses a roughly 1.23ac site located at the Northwest corner of Oro Dam Blvd. and Feather River Blvd in Oroville, CA. The APN number for the project is a portion of 035-030-109. The proposal includes a 3,365 square foot car wash building with associated car wash tunnel. equipment room, and a 660 square foot pay station building inclusive of an office area with restrooms. The Project also includes 18 standard vacuum stalls and 1 van accessible vacuum stall under canopies with solar panels. This property is currently zoned C-2 (Intensive Commercial). The car wash will have an automatic payment station in addition to an attendant to collect cash payments. An average home driveway or parking lot car wash can use 80-140 gallons of freshwater per vehicle, whereas a modern Surf Thru Car Wash uses an average of 30-40 gallons of freshwater. Additionally, our wash process utilizes an underground filtration system that stores and recycles most of the water used. Surf Thru further reduces negative impacts by using environmentally safe detergents. The carwash will operate seven days a week and will be closed on major holidays. The proposed operational hours for the facility will be 7am - 9pm (during non-rainy season), and 7:30am-5:30pm (during rainy season), and will operate seven days a week. The operation will employ 15-20 staff with a mix of part- and full-time employees. There will be approximately 4-5 car wash employees per shift on site during the car wash operational hours. The approximate expected number of cars washed is between 200-300 cars per day. Deliveries will be by large box-type delivery truck (non-semi), to the breakaway driveway area, and deliveries are limited to approximately twice a week, with the deliveries being after the hours of operation. If you have any questions, please do not hesitate to contact this office. Sincerely, Orlando Ramirez

#### **OPERATIONAL STATEMENT**

Surf-Thru Car Wash- NWC Oro Dam Blvd. and Feather River Blvd. (Oroville, CA)

This project encompasses a roughly 1.23ac site located at the Northwest corner of Oro Dam Blvd. and Feather River Blvd in Oroville, CA. The APN number for the project is a portion of 035-030-109. The proposal includes a 3,365 square foot car wash building with associated car wash tunnel, equipment room, and a 660 square foot pay station building inclusive of an office area with restrooms. The Project also includes 18 standard vacuum stalls and 1 van accessible vacuum stall under canopies with solar panels. This property is currently zoned C-2 (Intensive Commercial).

The car wash will have an automatic payment station in addition to an attendant to collect cash payments. An average home driveway or parking lot car wash can use 80-140 gallons of freshwater per vehicle, whereas a modern Surf Thru Car Wash uses an average of 30-40 gallons of freshwater. Additionally, our wash process utilizes an underground filtration system that stores and recycles most of the water used. Surf Thru further reduces negative impacts by using environmentally safe detergents.

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Deliveries will be by large box-type delivery truck (non-semi), to the breakaway driveway area, and deliveries are limited to approximately twice a week, with the deliveries being after the hours of operation.


If you have any questions, please do not hesitate to contact this office.


Sincerely,


Orlando Ramirez


Fresno, CA 93704


Bottom Line Development Group 6781 N Palm Avenue, Suite #100

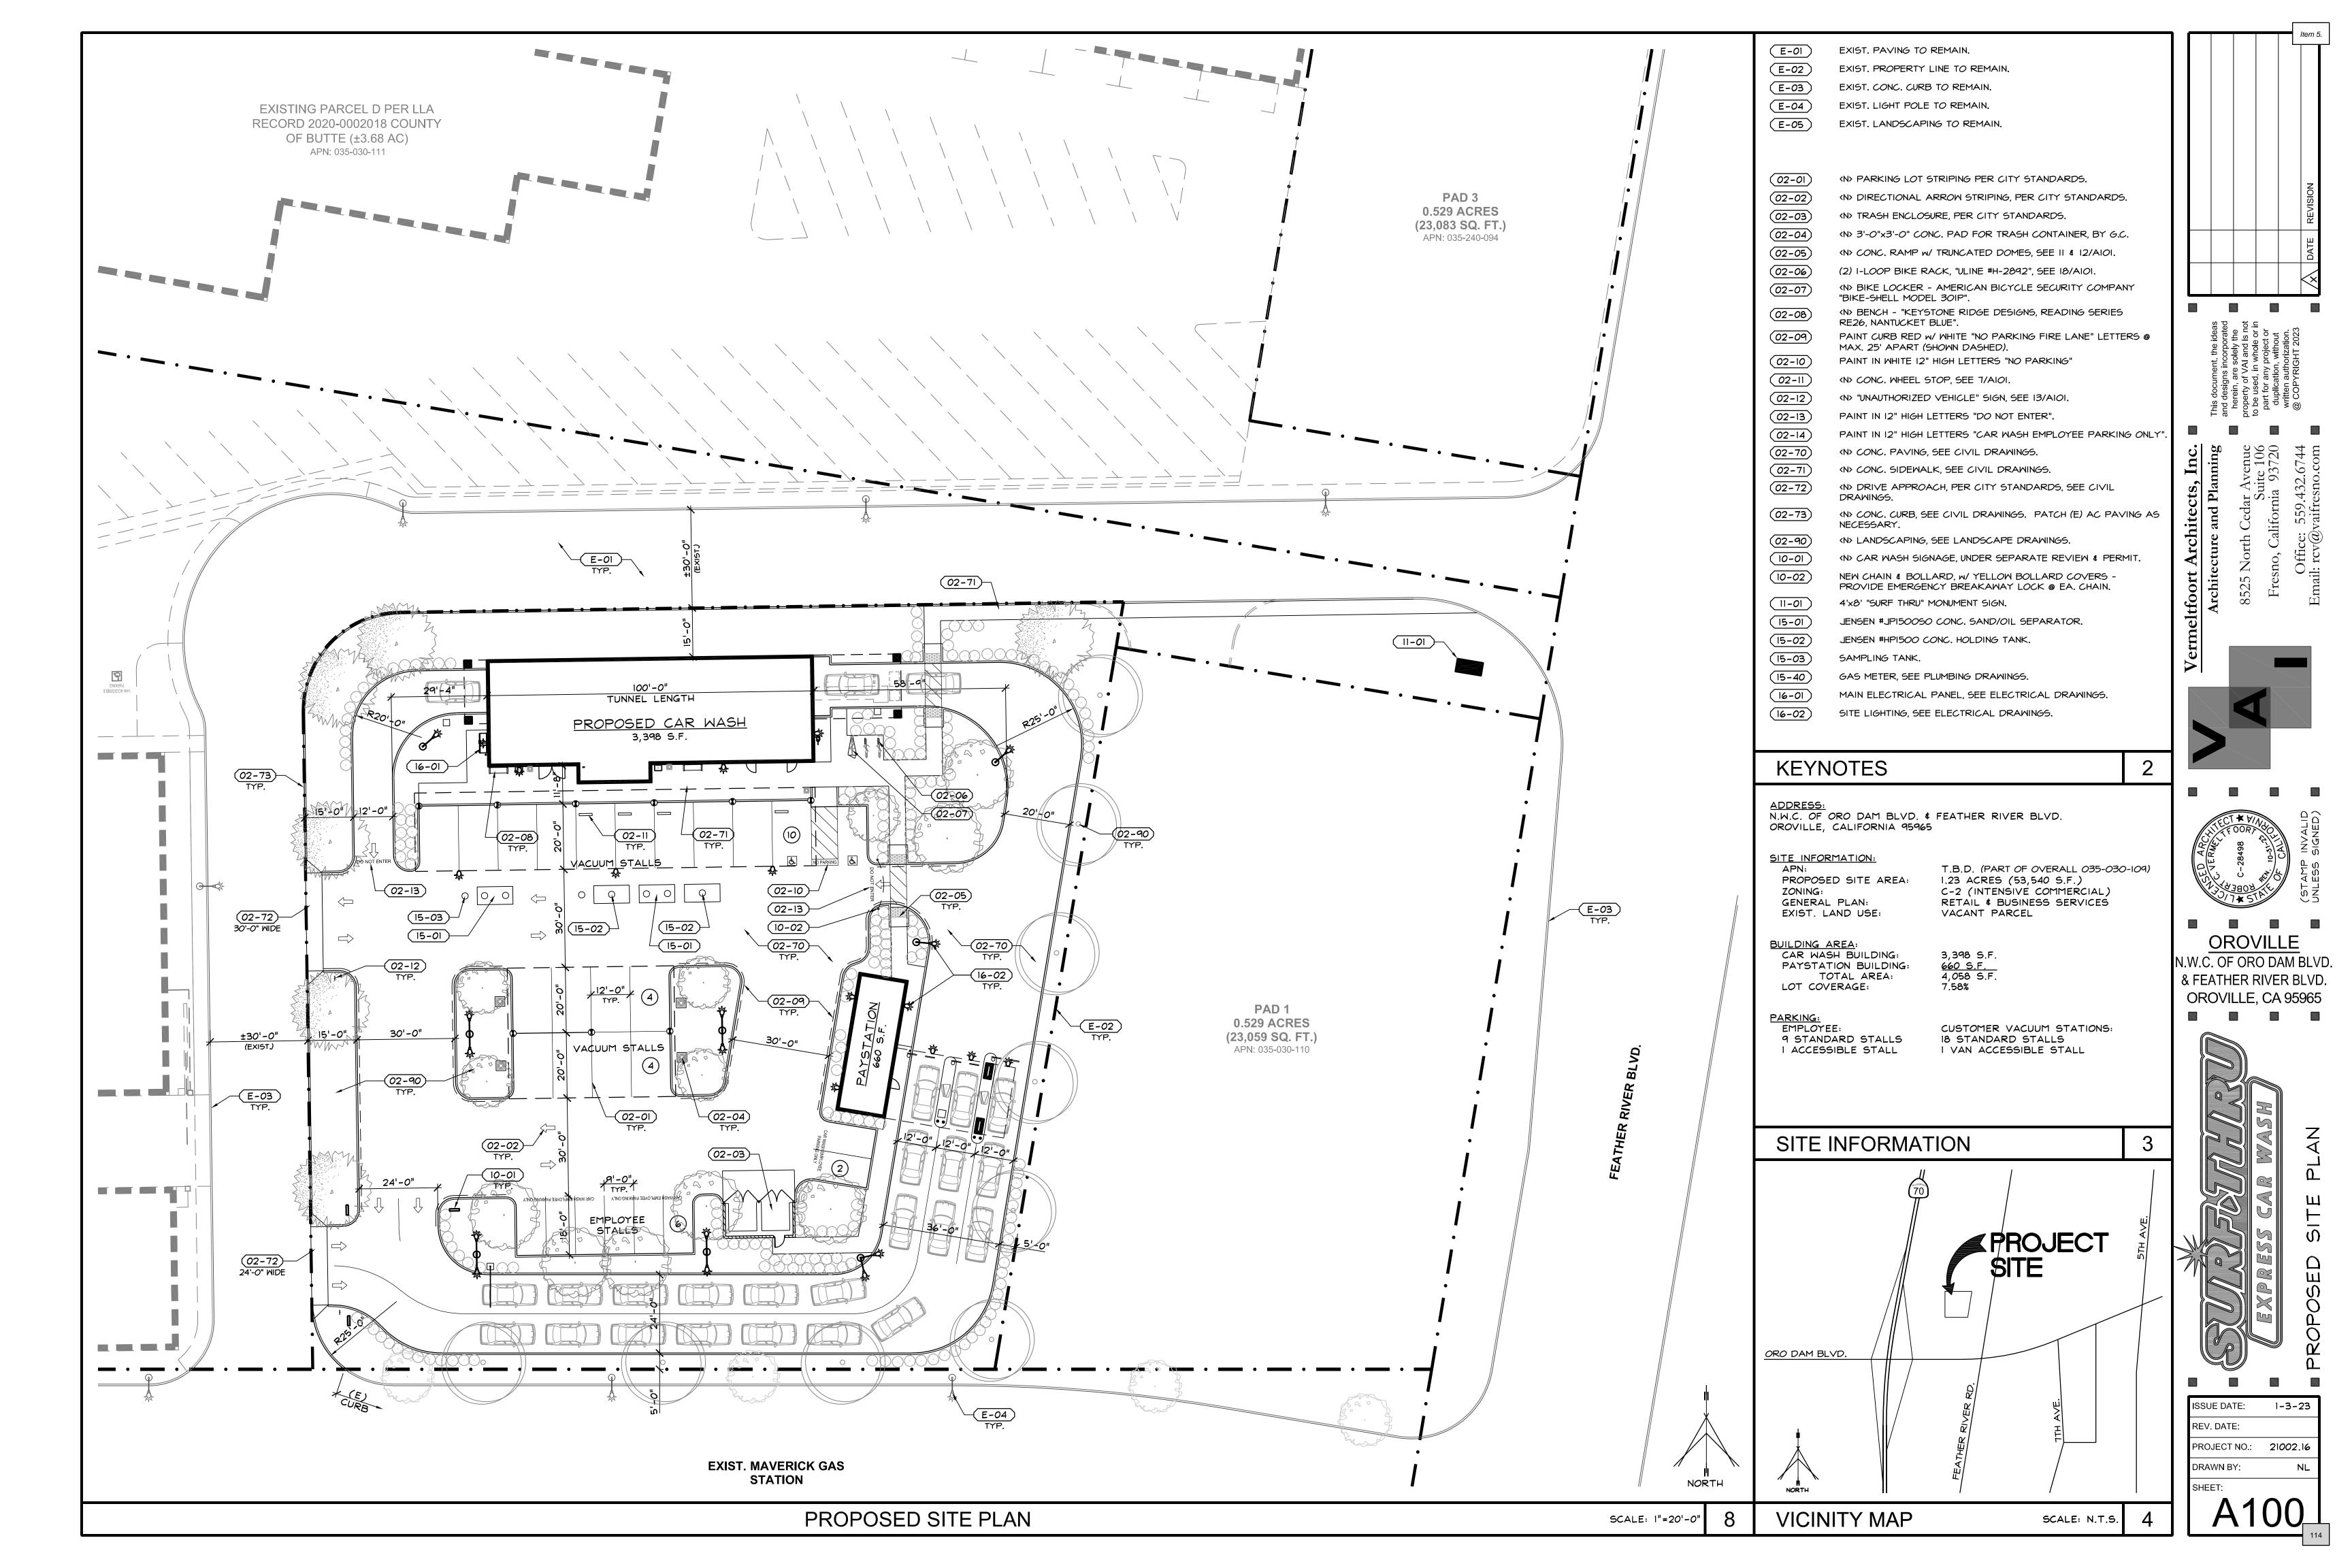

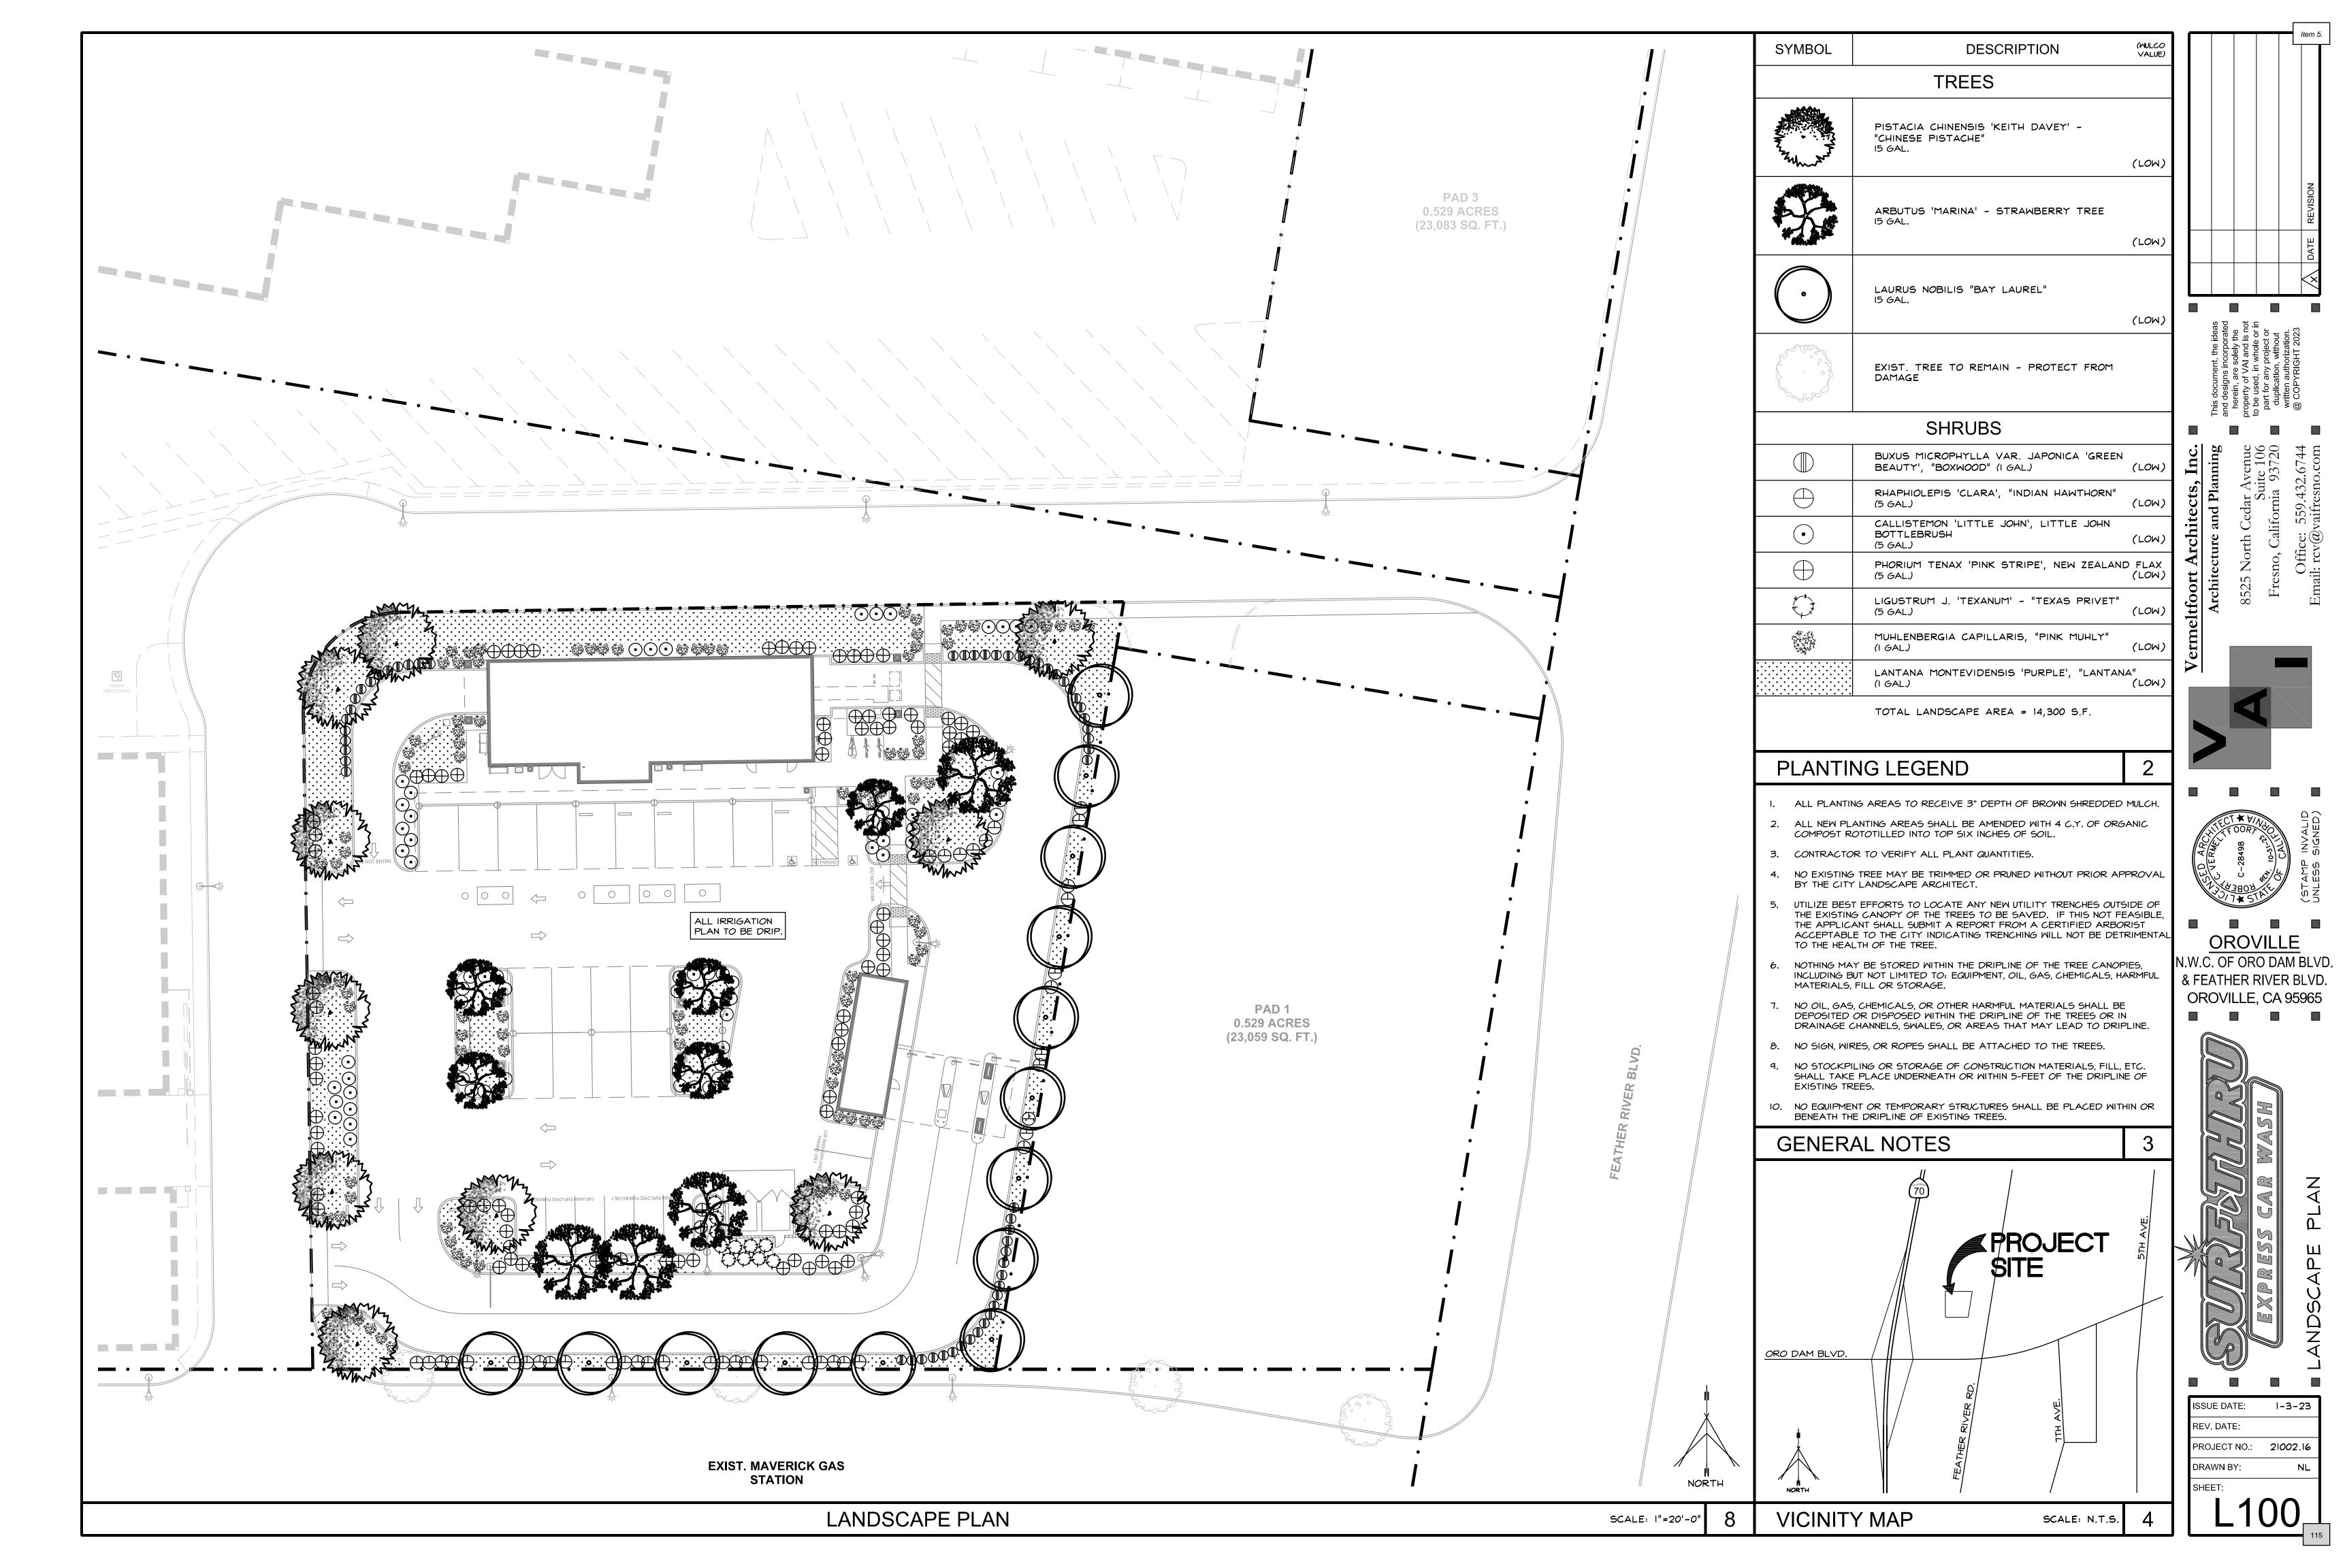

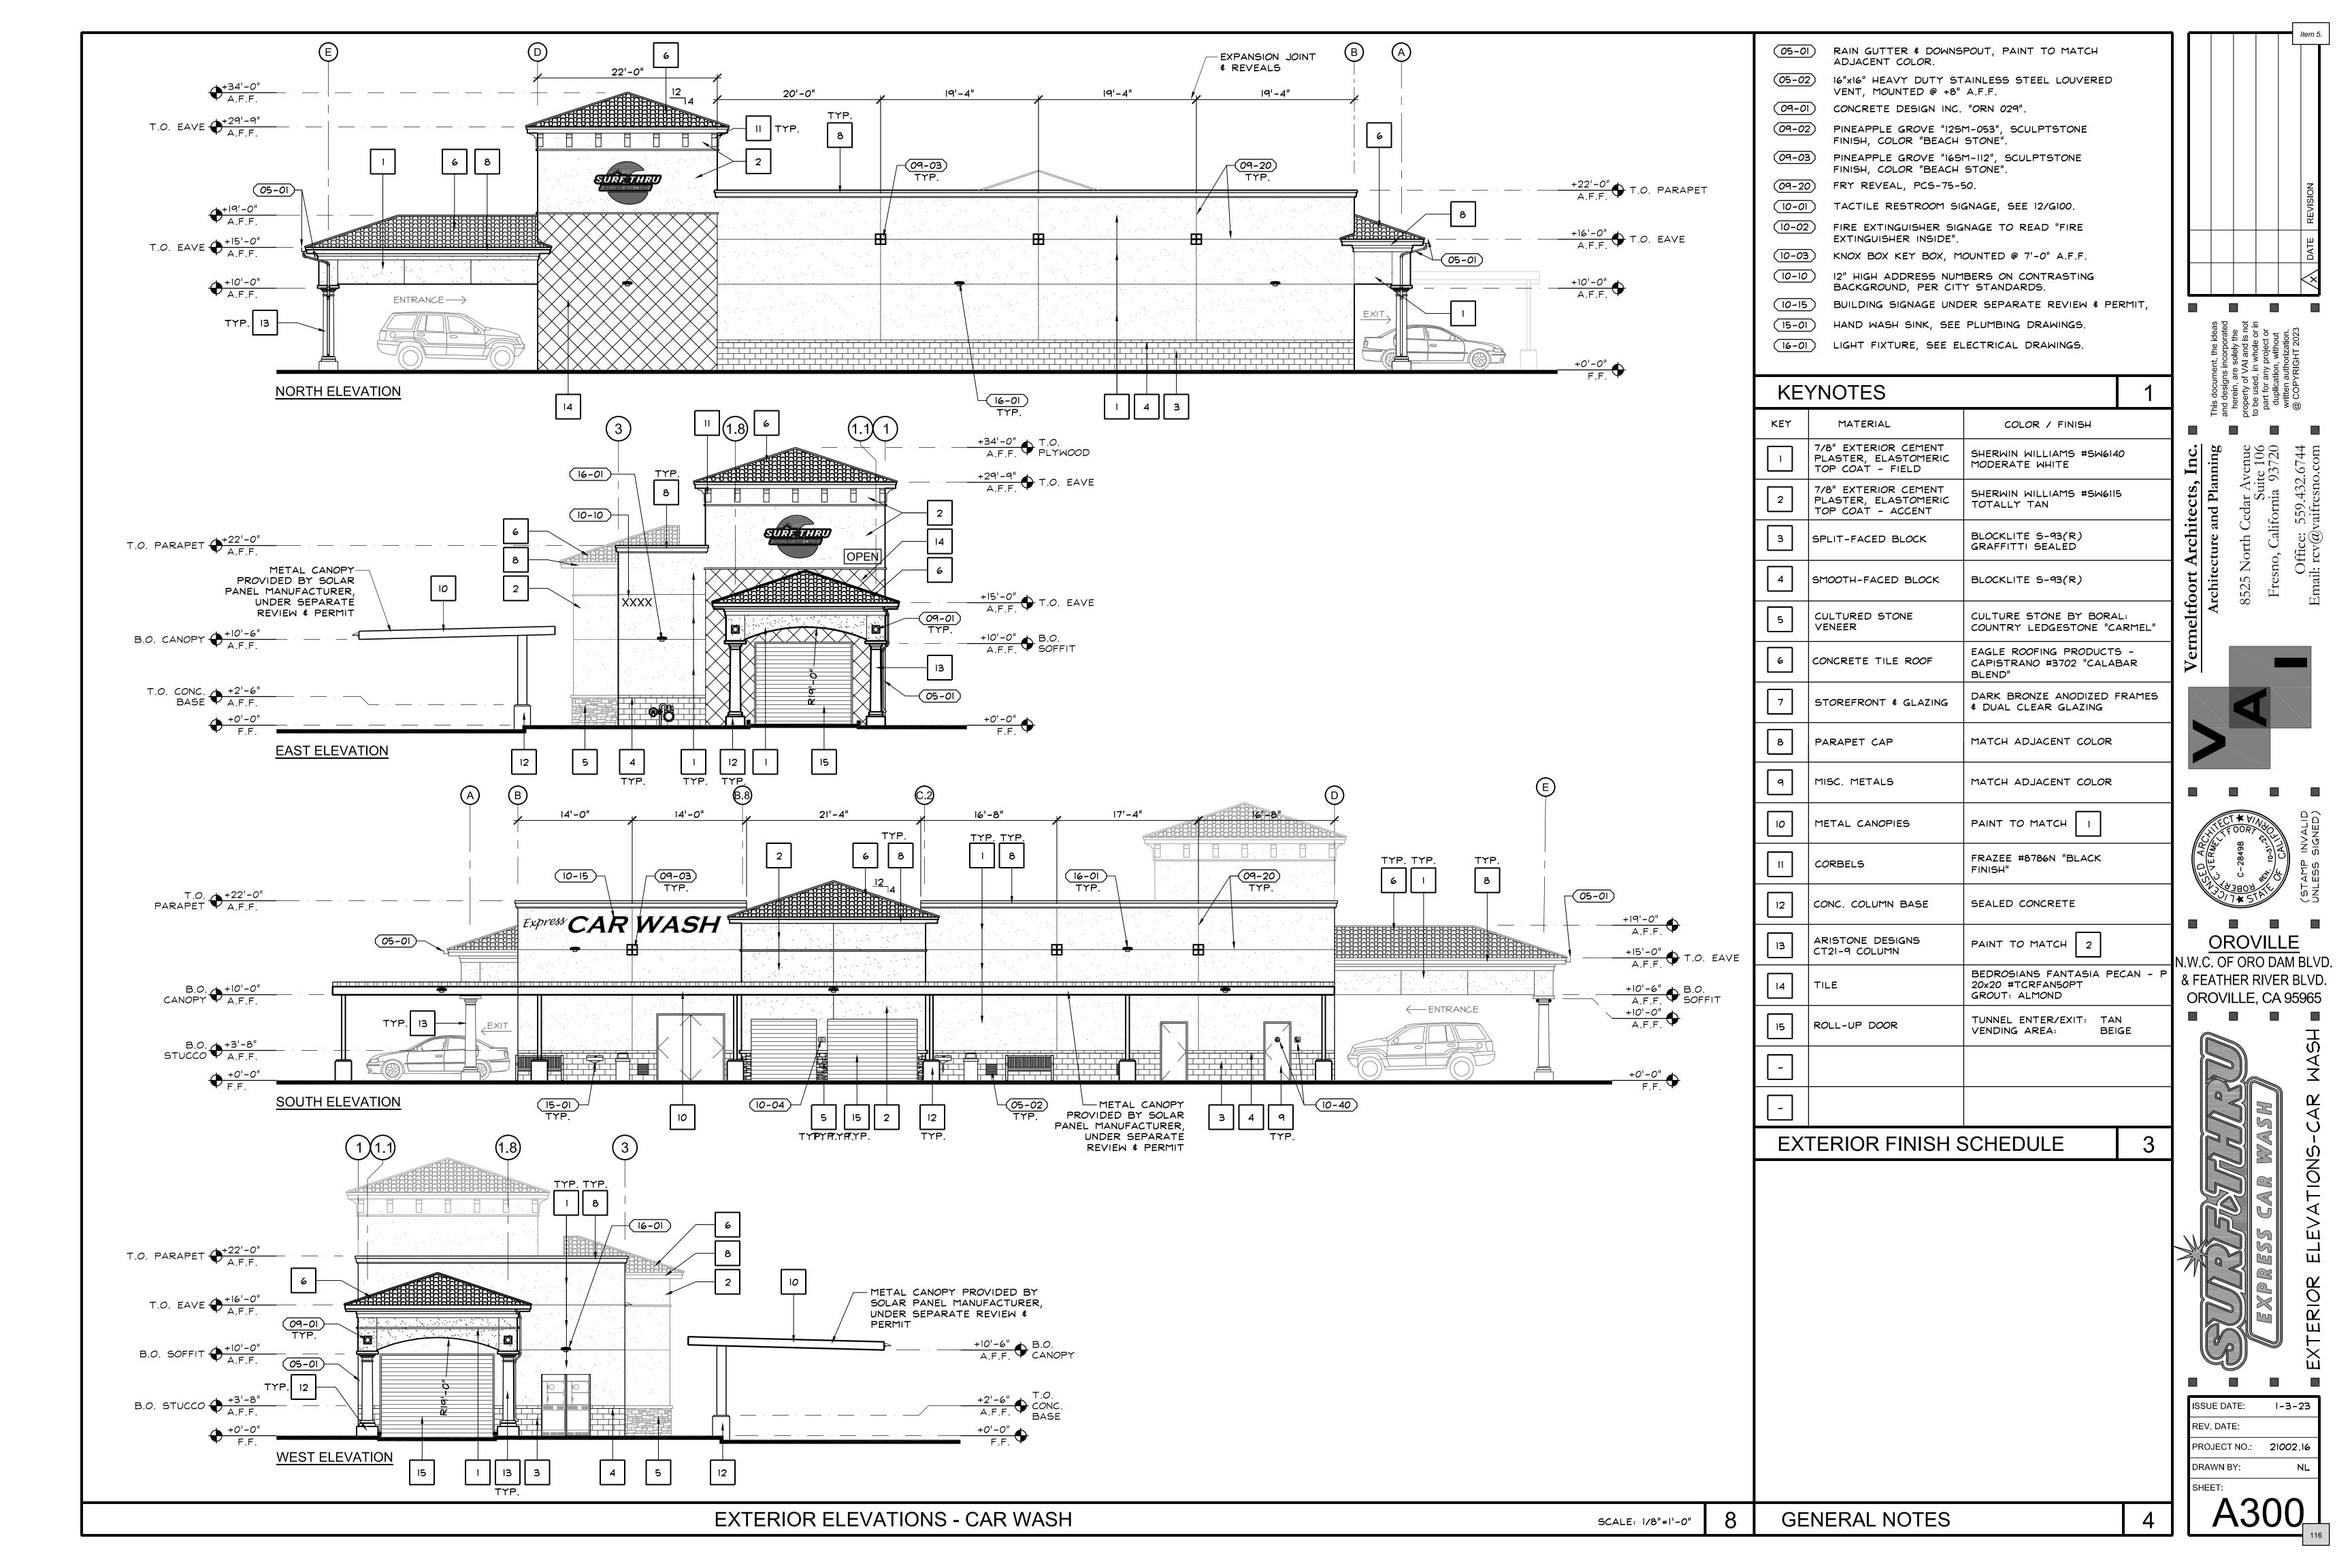

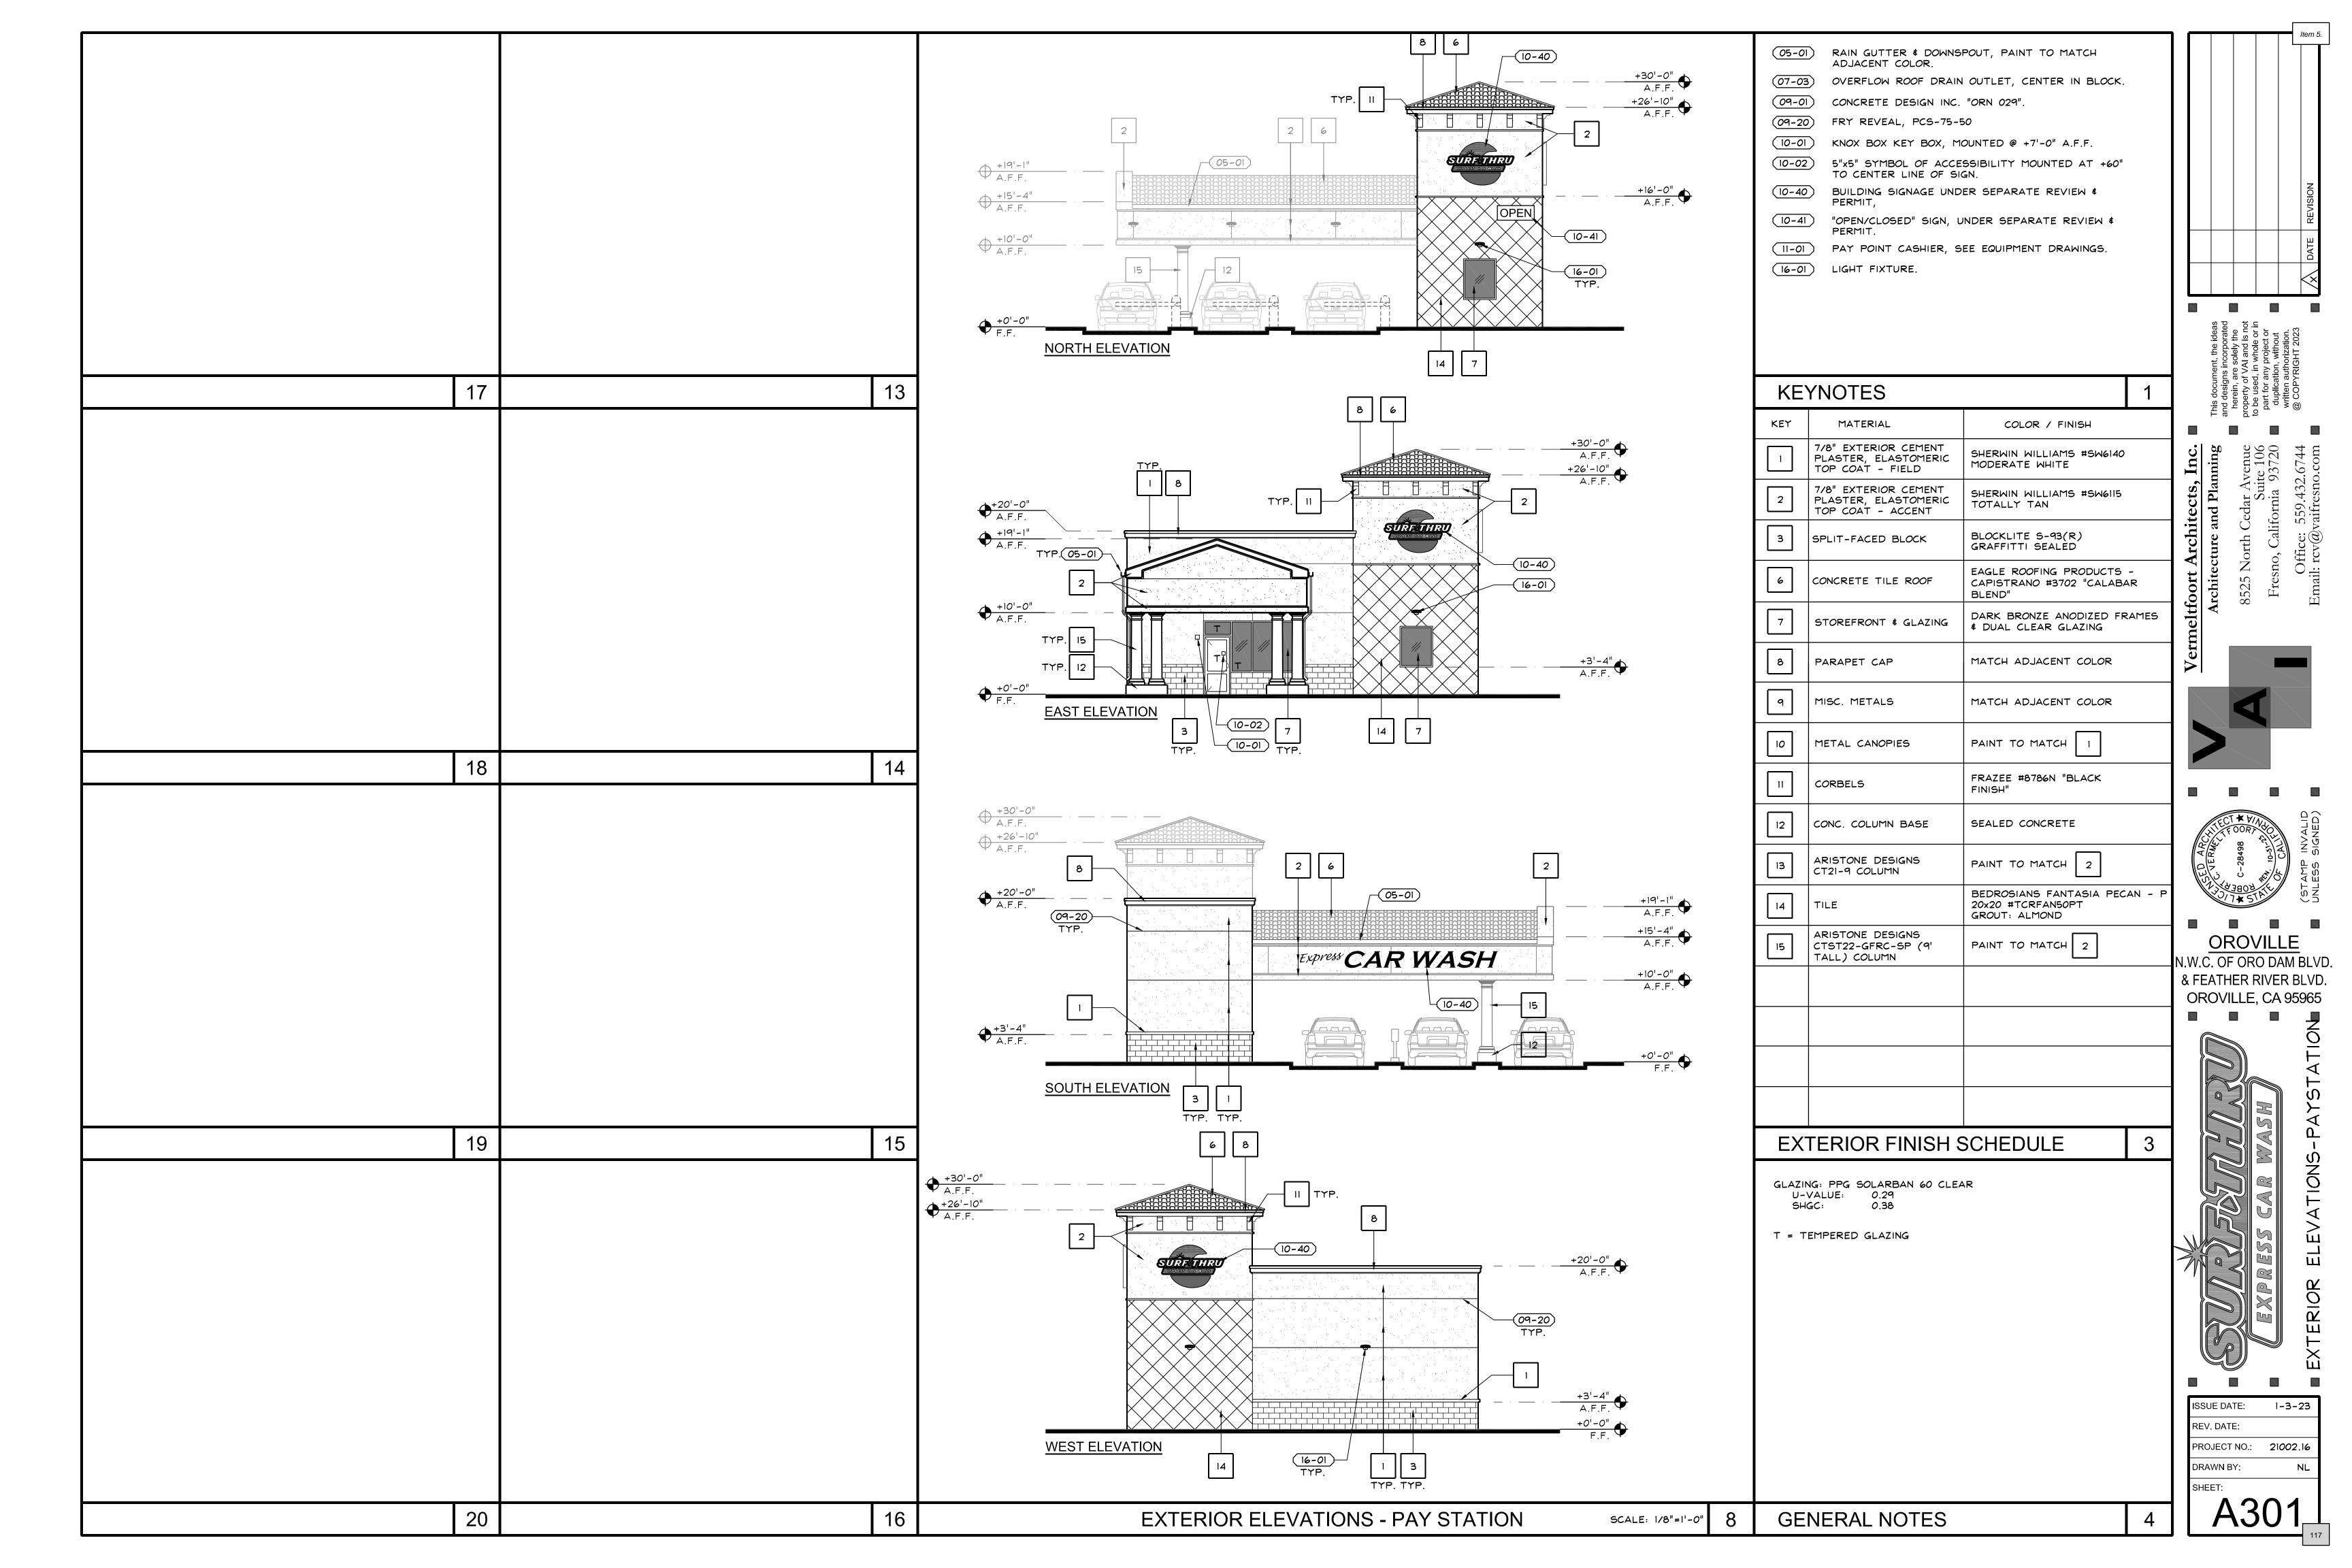

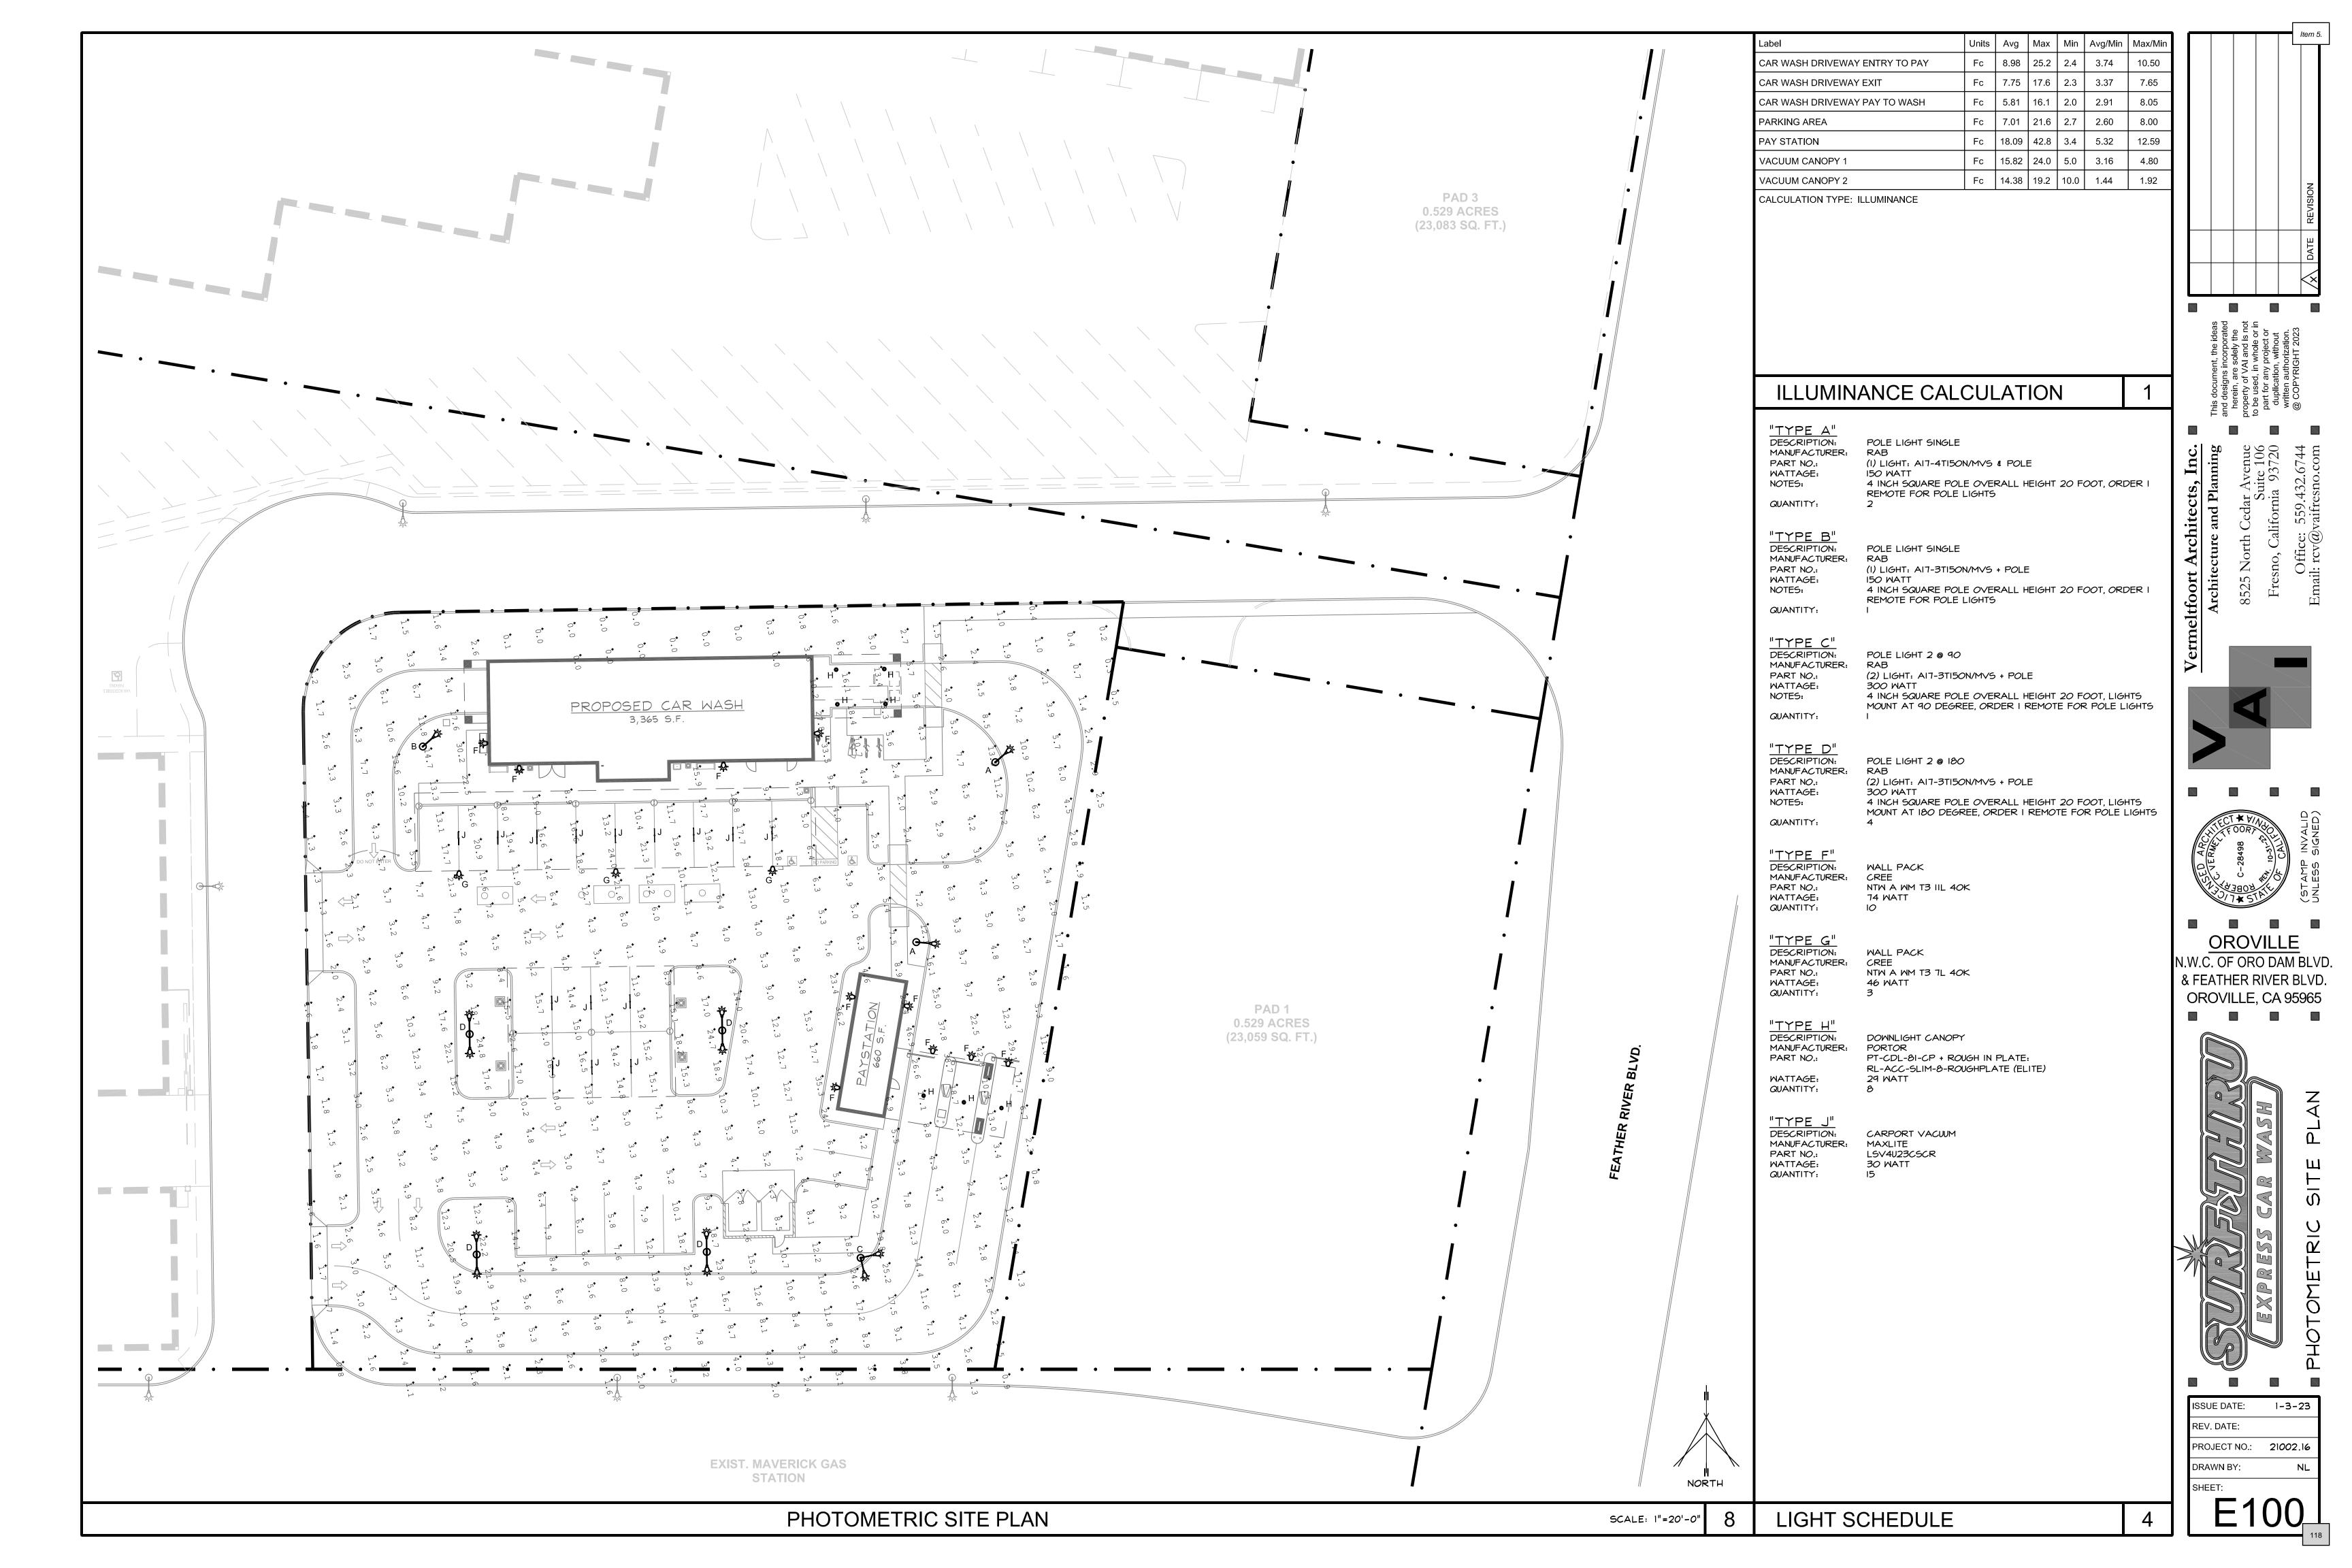



# City of Oroville

#### **COMMUNITY DEVELOPMENT DEPARTMENT**

1735 Montgomery Street Oroville, CA 95965-4897 (530) 538-2430 FAX (530) 538-2426 www.cityoforoville.org

#### NOTICE OF EXEMPTION

TO Butte County Clerk FROM City of Oroville

155 Nelson Avenue 1735 Montgomery Street Oroville, CA 95965 Oroville, CA 95965

Project Title: Minor Use Permit UP23-03 for a drive-through car wash on Feather River Blvd north of

Oroville Dam Blvd E

Project Location - Specific: APN (035-030-109)

Project Location - City: City of Oroville

Project Location - County: Butte

<u>Description of Nature, Purpose, and beneficiaries of project:</u> The project applicant, Orlando Ramirez, has applied for a Use Permit for the operation of Surf Thru Car Wash at (APN: 012-063-012). The subject property has a zoning designation of Intensive Commercial (C-2) and General Plan Land Use Designation of Retail Business Services.

Name of Public Agency Approving Project: City of Oroville

Name of Person or Agency Carrying Out Project: Orlando Ramirez

#### Exempt Status (Check One):

	Ministerial (	(Sec.	21080	(b)	(1`	): ˈ	15268)	١
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- Declared Emergency (Sec. 21080(b)(3); 15269(a))
- Emergency Project (Sec. 21080(b)(4); 15269(b)(c))
- ☐ Categorical Exemption: State type & section number:
  - General Rule Exemption; Title 14, CCR, §15061(b)(3)
  - In-Fill Development Projects, Title 14, CCR, §15332
- Statutory Exemption: State code number:

Reasons why project is exempt: This action has been determined to be exempt from the California Environmental Quality Act (CEQA) review as follows:

#### General Rule Exemption: Title 14. CCR. §15061(b)(3)

This project involves the use of a property zoned Intensive Commercial (C-2). The intent of the C-2 zoning designation is to provide for more intensive commercial establishments, including those that deal in large, low-volume items and major repair services, or that require large outdoor display and storage areas. As the building is existing, no new construction is proposed, minor interior alterations will occur, all business activities will be contained within the building, and the proposed use will be subject to comply

Item 5.

with all applicable City, County, State, Federal, and other local agencies as applicable, it has been determined that there is no possibility that the use permit request will have a significant effect on the environment. Thus, this action is exempt from CEQA.

#### In-Fill Development Projects, Title 14, CCR, §15332

Class 32 categorical exemptions consists of projects characterized as in-fill development meeting specific conditions a-e as described in this section. This project meets all conditions, including being consistent with the General Plan and Zoning Designation, occurs within City limits, has no value as habitat, will not result in any significant effects, and can be adequately served by all required utilities. The project is a permitted use in a C-2 zone, subject to a use permit for the drive-through.

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<ol> <li>Attach certified document of exemption finding.</li> <li>Has a notice of exemption been filed by the public</li> </ol>	ic agency approving the project?   Yes   No
Lead Agency Contact Person: Daniel Kopshever	<u>Telephone</u> : (530) 538-2517
Signature:	Date:
<ul><li>Signed by Lead Agency</li><li>Signed by Applicant</li></ul>	